#### SCOPE OF WORK:

- 1. REPAIR EXISTING DECK
- 2. UPDATE EXISTING FOOTING AND PROVIDE NEW FOOTINGS PER PLAN
- 3. CONSTRUCTION OF NEW ROOF FOR THE SECOND FLOOR DECK.
- 4. DEMOLISH EXISTING STAIRS AND BUILT NEW STAIRS PER PLAN
- 2X10 PRESSURE TREATED LEDGER BOARD TO BE BOLTED AND ANCHORED INTO MAIL HOUSE. GENERAL CONTRACTOR TO VERIFY BOLTS ANCHORED SECURELY.
- 6. 12X48 SONOTUBE FOUNDATION TYP. EXTEND 6" ABOVE GRADE. SEE DETAIL
- 7. ALL RAILING, POST, DECKING, ETC TO BE PRESSURE TREATED/ DECAY PROOF LUMBER

#### **GENERAL NOTES:**

- 1. DIMENSIONS ARE NOT GUARANTEE, CONTRACTOR SHOULD VERIFY ALL DRAWING DIMENSIONS BEFORE PERFORM WORK.
- 2. THE CONTRACTOR OR OWNER IS RESPONSIBLE FOR OBTAINING AND PAYING FOR ALL PERMITS REQUIRED FOR THIS PROJECT.
  3. ALL WORKS TO BE IN ACCORDANCE WITH THE COMMONWEALTH FOR CURRENT STATE BUILDING CODE AND OTHER APPLICABLE CODES.
- 3. THE CONTRACTOR IS SOLELY RESPONSIBLE FOR MEANS, METHODS, TECHNIQUES, SEQUENCING, SCHEDULING AND SAFETY FOR THIS PROJECT.
- 4. GENERAL CONTRACTOR TO REVIEW PROJECT WITH HOMEOWNER PRIOR TO STARTING CONSTRUCTION.
- 5. THE CONTRACTOR SHALL WARRANTEE HIS WORK FOR A PERIOD O ONE YEAR FROM DATE OF FINAL COMPLETION.
- 6. ALL TRADES TO BE COORDINATED PRIOR TO CONSTRUCTION BY GENERAL CONTRACTOR.
- 7. CONCRETE AND REBARS STRENGTH SHALL HAVE A MINIMUM OF 3,000 PSI AND 60,000 PSI RESPECTIVELY.

#### **RAILING NOTES:**

- 1. HAND RAILS MAY ENCROACH A MAX. OF 3 1/2" INTO THE REQUIRED WIDTH.
- 2. TREADS SHALL HAVE A MIN. WIDTH OF 10". STAIR TREADS MUST BE UNIFORM AND CAN NOT VARY FROM THE LARGEST TO THE SMALLEST BY MORE THAN 3/8".
- 3. STAIRWAYS SHALL HAVE MIN. 6'-8" OF HEADROOM AT THE NOSE OF THE STAIR.
- 4. HANDRAILS SHALL BE CONTINUOUS THE FULL LENGTH OF THE STAIRS. THE ENDS OF HANDRAILS SHALL RETURN TO WALL OR TERMINATE INTO A NEWEL POST OR SAFETY TERMINAL.
- 5. 42" MIN. HEIGHT GUARDRAILS SHALL BE PROVIDED FOR AT PORCHES, DECKS, BALCONIES, STAIRWAYS AND LANDINGS WHERE THE ADJACENT SURFACE IS GREATER THAN 24" BELOW.
- 6. RAILING AND GUARDRAIL BALUSTER SPACING SHALL BE NO GREATER THAN 4".
- 7. THE TRIANGULAR OPENINGS FORMED BY THE RISER, TREAD, AND BOTTOM OF GUARDRAIL SHALL NOT ALLOW A 6" DIAMETER SPHERE TO PASS THROUGH.



**LOCATION MAP** 

## TWO FAMILY HOUSE

REPAIR AND EXTEND REAR DECK AND ADD NEW ROOF ABOVE 88 MARSHAL ST SOMERVILLE, MA

### LIST OF DRAWINGS

A-1 TITLE, LOCATION MAP, CONTENT
A-2 EXISTING FLOOR PLANS &
ELEVATIONS
A-3 PROPOSED FLOOR PLANS &
ELEVATIONS
A-4 PROPOSED FOUNDATION PLAN &
FIRST FLOOR FRAMING PLAN
A-5 PROPOSED SECOND AND ROOF
FRAMING PLAN




12/10/2018


HIGINIO MENDEZ BABILONIA CIVIL ENGINEER BOSTON, MA TEL. 939-640-5833 EMAĮL: hmb170@gmail.com

PEDRO ALVARADO 88 MARSHALL ST SOMERVILLE, MA CONTENT
FLOOR PLAN


SCALE: DATE:

A-1

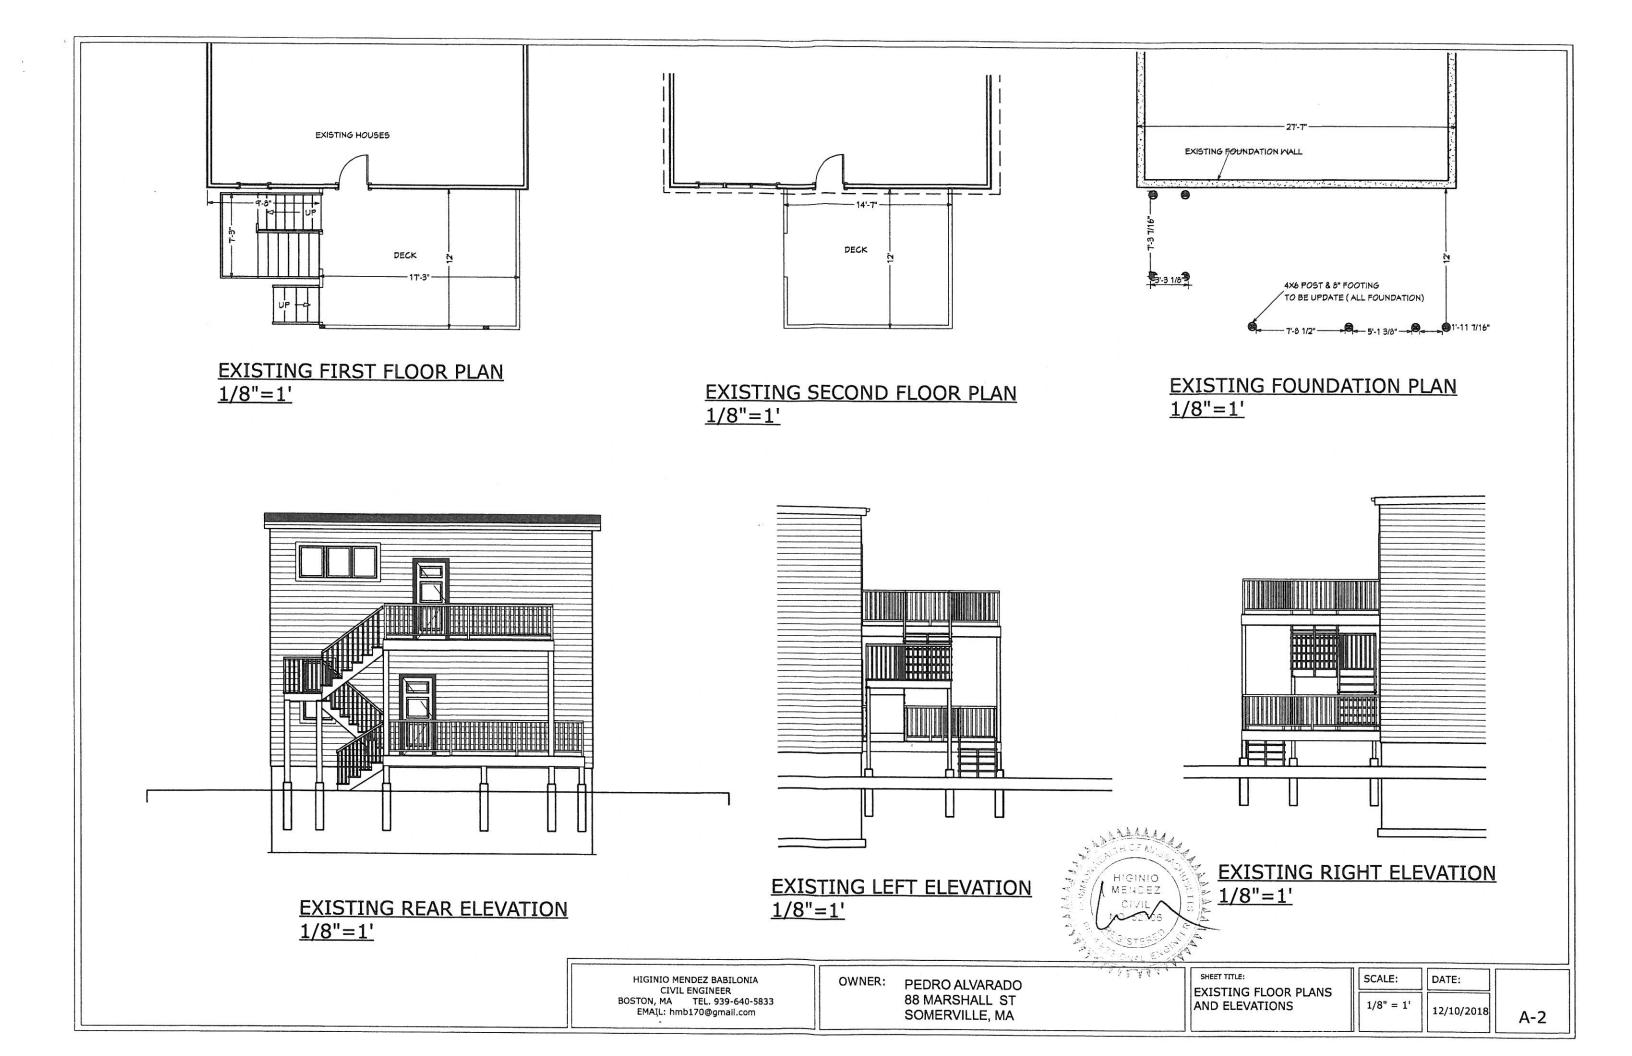


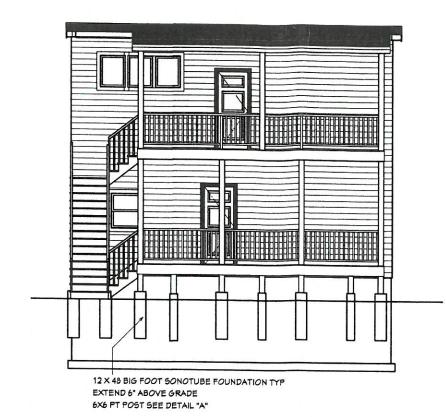


# PROPOSED REAR ELEVATION 1/8"=1'

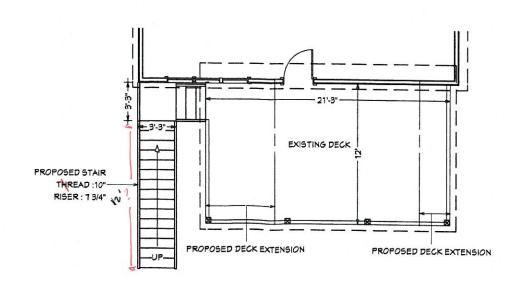

# PROPOSED SECOND FLOOR PLAN 1/8"=1'

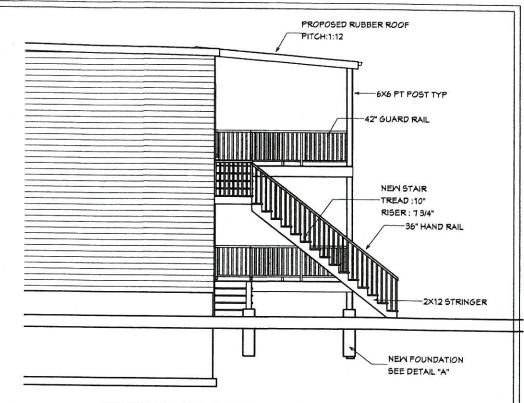


## PROPOSED LEFT ELEVATION 1/8"=1'

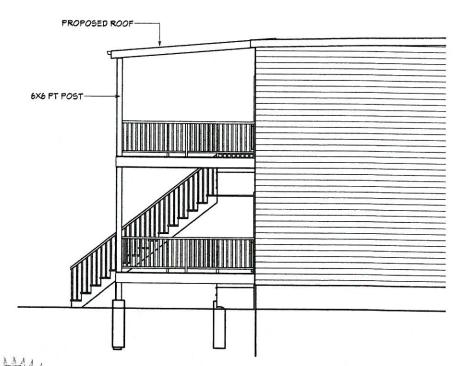

FLOOR PLAN

PROPOSED RIGHT ELEVATION 1/8"=1'

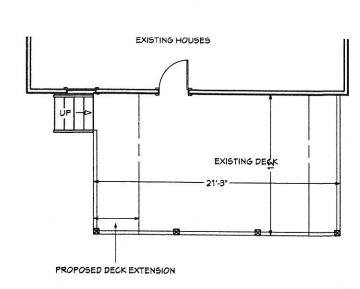

PROPOSED FIRST FLOOR PLAN 1/8"=1'


HIGINIO MENDEZ BABILONIA CIVIL ENGINEER BOSTON, MA TEL. 939-640-5833 EMAŢL: hmb170@gmail.com PEDRO ALVARADO 88 MARSHALL ST SOMERVILLE, MA

PROPOSED ELEVATIONS


SCALE: 3/16" = 1'


DATE:
1' 12/10/2018


A-3

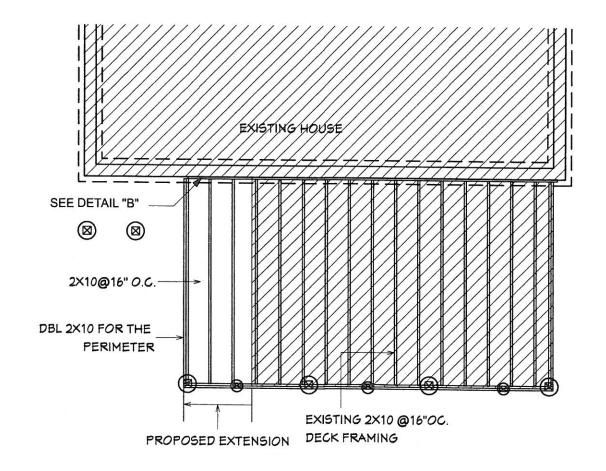


PROPOSED FIRST FLOOR FRAMING PLAN 3/16"=1'

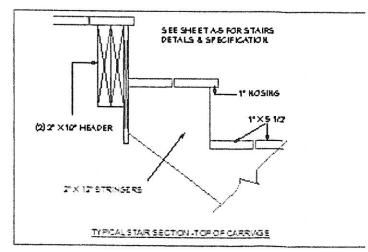

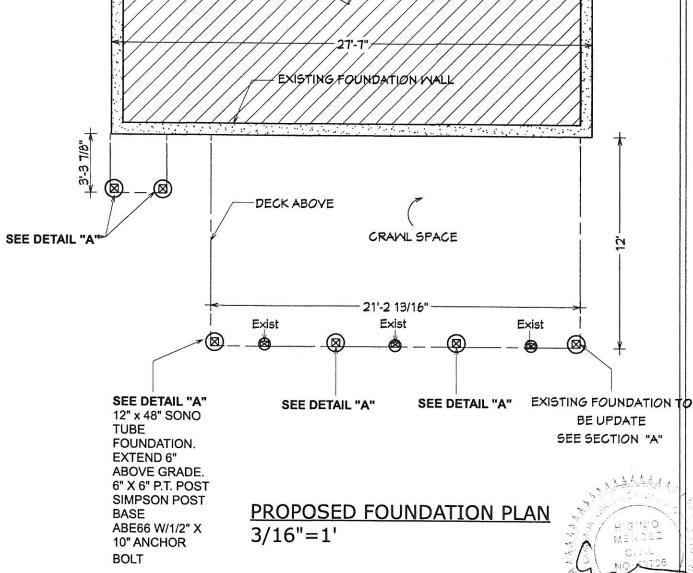

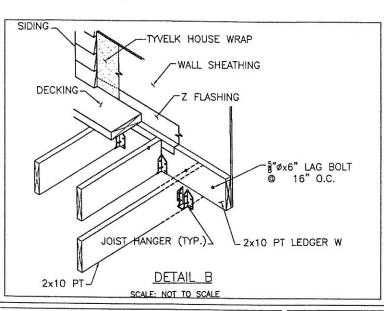

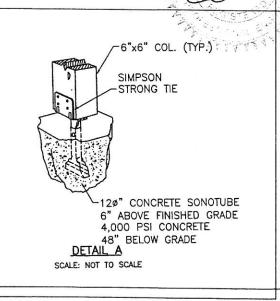


HIGINIO MENDEZ BABILONIA CIVIL ENGINEER BOSTON, MA TEL. 939-640-5833 EMAĮL: hmb170@gmail.com

PEDRO ALVARADO 88 MARSHALL ST SOMERVILLE, MA


FRAMING PLANS

SCALE: DATE: 12/10/2018

A-4

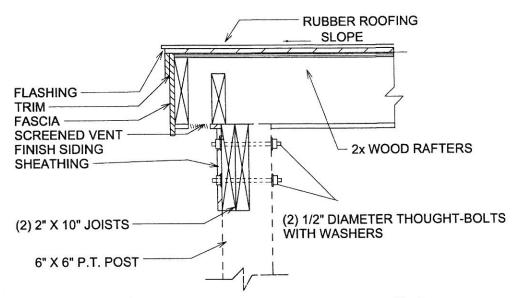

## EAVE AT PORCH ROOF EDGE "C" NTS

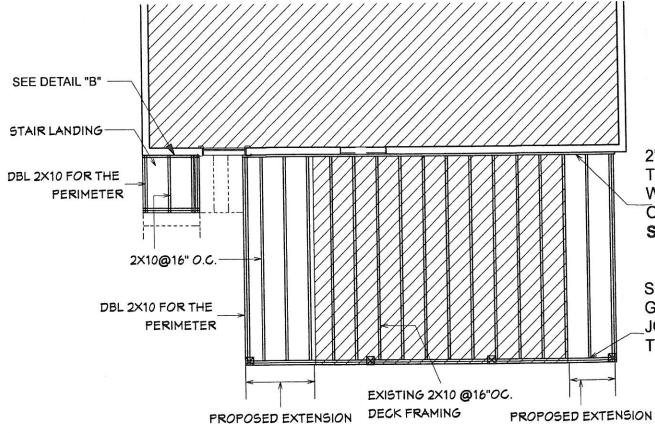

EXISTING ROOF EXISTING MALL 2X10@16" O.C. ROOF RAFTERS PITCH=1:12 DBL 2X10 -DBL 2X10 BEAM

PROPOSED ROOF FRAMING PLAN 3/16"=1'

2" X 10" P.T. LEDGER BOARD ATTACHED TO STUDS, BAND JOIST OR RIM BOARD WITH 1/2" LAG SCREWS OR THROUGH BOLTS WITH WASHERS. SEE DETAIL "B"

SIMPSON TIE **GALVANIZED** JOIST HANGER TYP.

### PROPOSED SECOND FLOOR FRAMING PLAN 3/16"=1'

HIGINIO MENDEZ BABILONIA CIVIL ENGINEER BOSTON, MA TEL. 939-640-5833 EMAIL: hmb170@gmail.com

PEDRO ALVARADO 88 MARSHALL ST SOMERVILLE, MA

SHEET TITLE: FRAMING PLAN SCALE: DATE:

A-5

12/10/2018