Zoning Summary 7-9 Louisburg Place, Somerville

Zoning District: NR (Neighborhood Residential)

Description	Required/Allowed	Existing	Proposed/Conformance
Use	Residential Use	2 Family	3 Family/Conforming
House Type	n/a	Detached House	No Change/Conforming
Lot Area	n/a	3,502 SF	No Change/Conforming
Lot Depth	n/a	86.51 Feet	No Change/Conforming
Lot Coverage*	60% Maximum	55.5%	50.8%/Conforming
Demolition Percentage	50% Maximum	n/a	42%/Conforming
Maximum Height	2.5 Stories Maximum	2.25 Stories	2.5 Stories/Conforming
Minimum Front Yard	10.0' Minimum	41.3'	30.8'/Conforming
Minimum Left Side Yard	3.0' Minimum (both sides must add to >10.0')	0.1'	No Change/Conforming
Minimum Right Side Yard	3.0' Minimum (both sides must add to >10.0')	21.5'	No Change/Conforming
Minimum Rear Yard	20.0' Minimum	1.7'	No Change/Conforming
Parking	n/a	2.0 Spaces	3.0 Spaces/Conforming

*Lot Coverage Calculations Existing Lot Coverage Calculation House (990 SF) + Concrete Impervious Areas (953 SF) = 1,943 SF 1,943 SF / 3,502 SF = 55.5% Lot Coverage

Proposed Lot Coverage Calculation
House (1,229 SF) + Concrete Impervious Areas (218 SF) = 1,447 SF
Pervious Pavers (1,013 SF) * Runoff Coefficient (0.33) = 334 SF
1,447 SF (House + Concrete Areas) + 334 SF (Pervious Pavers) = 1,781 SF
1,781 SF / 3,502 SF = 50.8% Lot Coverage



PROPOSED RENOVATION AND ADDITION

No.	Description	Date
		1


ZONING	}		
Project number	6		
Date	11-06-2024	A-00	
Drawn by	MS		
Checked by	MS	Scale	

				W	/indow Schedule	*NOTE: ALL WINDOW AND DOOR SIZES/COUNTS NEED TO BE VERIFIED BY OWNER PRIOR TO ORDERING.
Type Mark	Manufacturer	Model	Count	Rough Width	Rough Height	Description
1	HARVEY	SLIMLINE AWNING WINDOW	1	2' - 6"	1' - 5 1/2"	AWNING WINDOW
2	HARVEY	11056	4	1' - 10"	5' - 6"	DOUBLE-HUNG WINDOW
3T	HARVEY	2436	4	2' - 4"	3' - 6"	DOUBLE-HUNG WINDOW, TEMPERED GLASS
5	HARVEY	2456	2	2' - 4"	5' - 6"	DOUBLE-HUNG WINDOW
6T	HARVEY	3036	3	3' - 0"	3' - 6"	DOUBLE-HUNG WINDOW, TEMPERED GLASS
7	HARVEY	3056	4	3' - 0"	5' - 6"	DOUBLE-HUNG WINDOW
7T	HARVEY	3056	1	3' - 0"	5' - 6"	DOUBLE-HUNG WINDOW, TEMPERED GLASS
8T	HARVEY	2446-2	2	4' - 6 1/4"	4' - 6"	DOUBLE DOUBLE-HUNG WINDOW. TEMPERED GLASS
9	HARVEY	2646-2	2	4' - 10 1/4"	4' - 6"	DOUBLE DOUBLE-HUNG WINDOW
10	HARVEY	2656-2	2	4' - 10 1/4"	5' - 6"	DOUBLE DOUBLE-HUNG WINDOW
11	HARVEY	3050-2	1	5' - 10 1/4"	5' - 0"	DOUBLE DOUBLE-HUNG WINDOW
12	HARVEY	3056-2	7	5' - 10 1/4"	5' - 6"	DOUBLE DOUBLE-HUNG WINDOW
13	HARVEY	21046-3	2	8' - 2 1/2"	4' - 6"	TRIPLE DOUBLE-HUNG WINDOW
14	HARVEY	3056-3	2	8' - 8 1/2"	5' - 6"	TRIPLE DOUBLE-HUNG WINDOW
15	VELUX	FIXED SKYLIGHT	2	3' - 0 1/2"	3' - 0 1/2"	FIXED SKYLIGHT
E1	N/A	EXISTING	1	2' - 2"	5' - 6"	EXISTING DOUBLE-HUNG WINDOW

					Door Schedule *NOTE: ALL WINDOW AND DOOR SIZES/COUNTS NEED TO BE VERIFIED BY OWNER PRIOR TO ORDERING.
Type Mark	Count	Comments	Rough Width	Rough Height	Description
1	2	EXTERIOR ENTRY	3' - 2 1/2"	6' - 10 1/2"	COMMON ENTRY PANEL DOOR, SMOOTH FINISH, PAINTED, STYLE TO BE SLECTED BY OWNER
2	1	DECK SLIDING	5' - 2 1/2"	6' - 10 1/2"	DECK SLIDING GLASS DOOR, 9 LITE, PAINTED, PROVIDE DEADBOLT, STYLE TO BE SELECTED BY OWNER
3	3	UNIT ENTRY	3' - 2 1/2"	/2" 6' - 10 1/2" ENTRY PANEL DOOR, SMOOTH FINISH, PAINTED, PROVIDE DEADBOLT, STYLE TO BE SLECTED BY OWNER	
4	14	BED/BATH	2' - 8 1/2"	6' - 10 1/2"	INTERIOR DOOR, SMOOTH FINISH, STYLE TO BE SELECTED BY OWNER
5	8	CLOSET	2' - 8 1/2"	6' - 10 1/2"	INTERIOR DOOR, SMOOTH FINISH, STYLE TO BE SELECTED BY OWNER
6	1	LINEN CLOSET	2' - 2 1/2"	6' - 10 1/2"	INTERIOR DOOR, SMOOTH FINISH, STYLE TO BE SELECTED BY OWNER
7	1	LINEN CLOSET	1' - 8 1/2"	6' - 10 1/2"	INTERIOR DOOR, SMOOTH FINISH, STYLE TO BE SELECTED BY OWNER
8	5	CLOSET	4' - 2 1/2"	6' - 10 1/2"	INTERIOR DOUBLE DOOR, SMOOTH FINISH, STYLE TO BE SELECTED BY OWNER
9	4	CLOSET	5' - 2 1/2"	6' - 10 1/2"	INTERIOR DOUBLE DOOR, SMOOTH FINISH, STYLE TO BE SELECTED BY OWNER
10	1	CLOSET	4' - 2 1/2"	4' - 8 1/2"	INTERIOR DOUBLE DOOR, SMOOTH FINISH, STYLE TO BE SELECTED BY OWNER, HEIGHT TO BE VERIFIED IN FIELD
11	2	<varies></varies>	2' - 8 1/2"	4' - 8 1/2" INTERIOR DOOR, SMOOTH FINISH, STYLE TO BE SELECTED BY OWNER, HEIGHT TO BE VERIFIED IN FIELD	

No.	Description	Date


SCHEDULES		
Project number	6	
Date	11-06-2024	A-0.0
Drawn by	MS	, (0.0
Checked by	MS	Scale

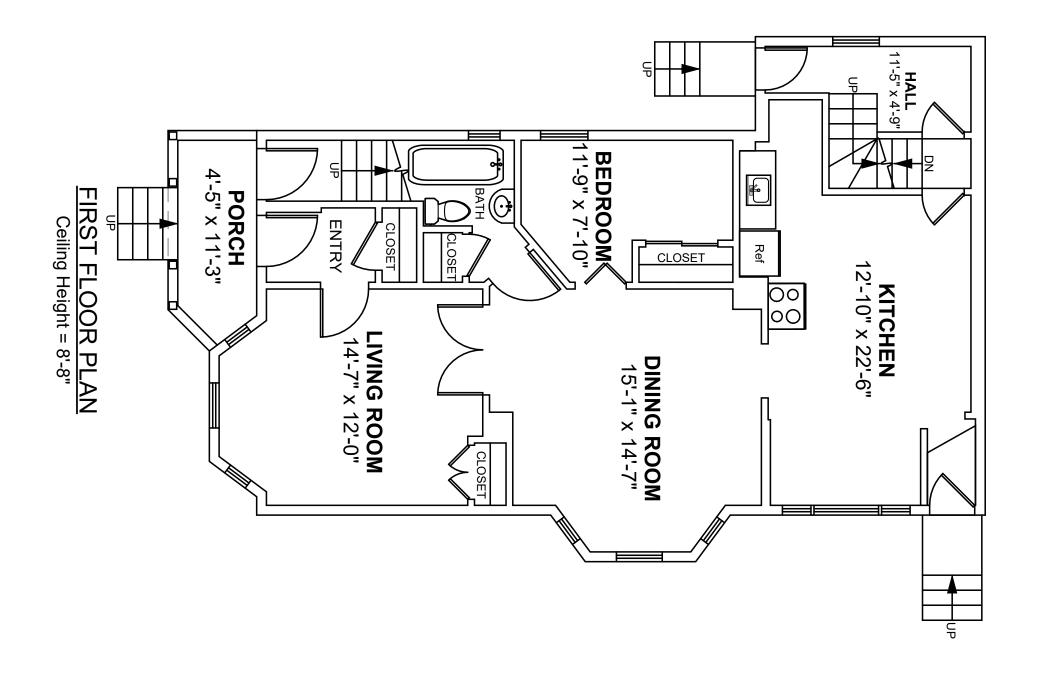



No.	Description	Date

EXISTIN	XISTING 1ST FLOOR PLAN	
Project number	6	_ , , , ,
Date	11-06-2024	E-1.10
Drawn by	MS	
Checked by	MS	Scale 3/16" = 1'-0"

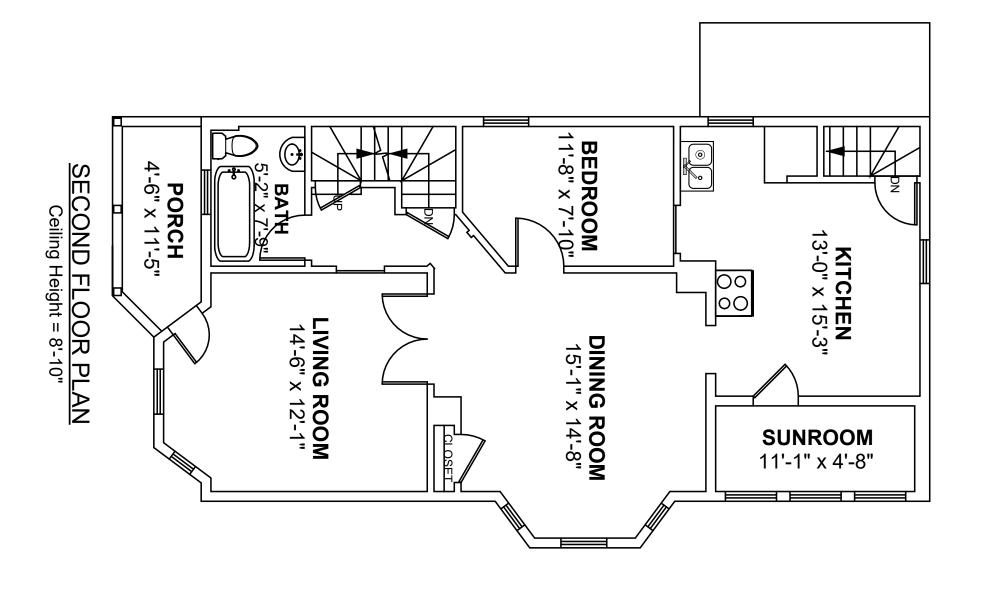



Scale 3/16" = 1'-0"

PROPOSED RENOVATION AND ADDITION


7 LOUISBURG PLACE SOMERVILLE, MA

No.	Description	Date

EXISTIN	IG 2ND FLC	OR PLAN
Project number	6	_ 4 00
Date	11-06-2024	E-1.20
Drawn hy	MS	

Checked by

MS

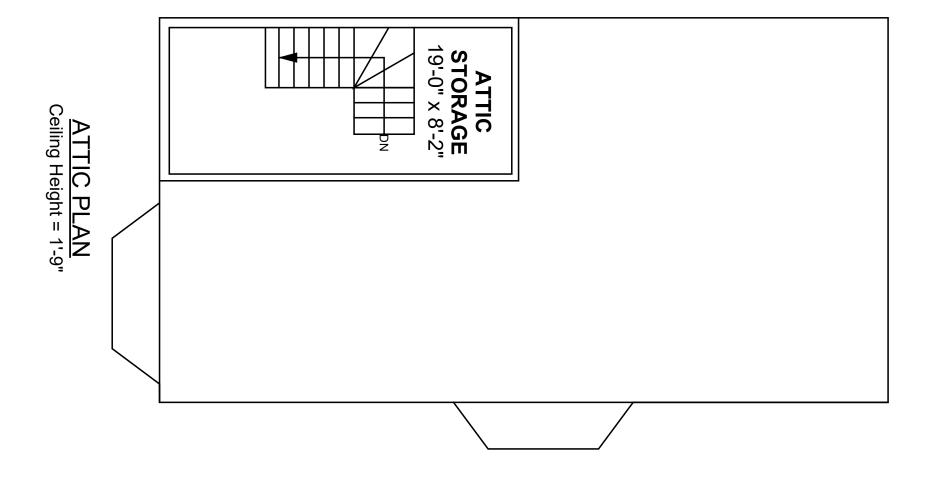



NO.	Description	Date

EXISTING 3RD FLOOR PLAN		
Project number	6	_ ,
Date	11-06-2024	E-1.30
Drawn by	MS	
Checked by	MS	Scale 3/16" = 1'-0"



MICHAEL L. MELASSIVER CONTROL OF A 47314

TO A 47314

TO A 55 ONAL ENGINEER CONTROL OF A 17314

Scale 3/16" = 1'-0"

PROPOSED RENOVATION AND ADDITION

No.	Description	Date

EXISTIN	EXISTING FRONT ELEVATION	
roject number	6	
ate	11-06-2024	E-2.0
rawn by	MS	




AND ADDITION

SOMERVILLE, MA

No.	Description	Date

EXISTING SIDE ELEVATION		
Project number	6	
Date	11-06-2024	∣ E-2.1
Drawn by	MS	
Checked by	MS	Scale 3/16" = 1'-0"

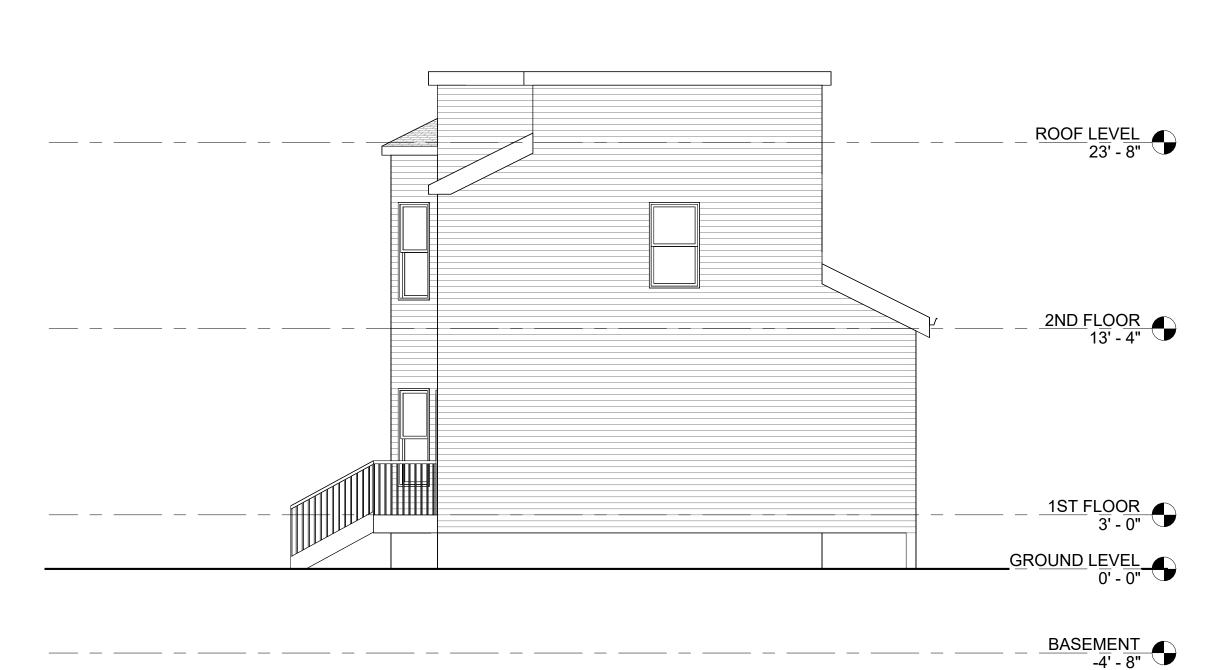


MICHAEL L. MICHAEL L.

PROPOSED RENOVATION AND ADDITION

Description	Date
	Description

EXISTIN	IG REAR EI	LEVATION
Project number	6	
Date	11-06-2024	F ₋ 2 2

Project number	6	
Date	11-06-2024	F-2.2
Drawn by	MS	
Checked by	MS	Scale 3/16" = 1'-0"

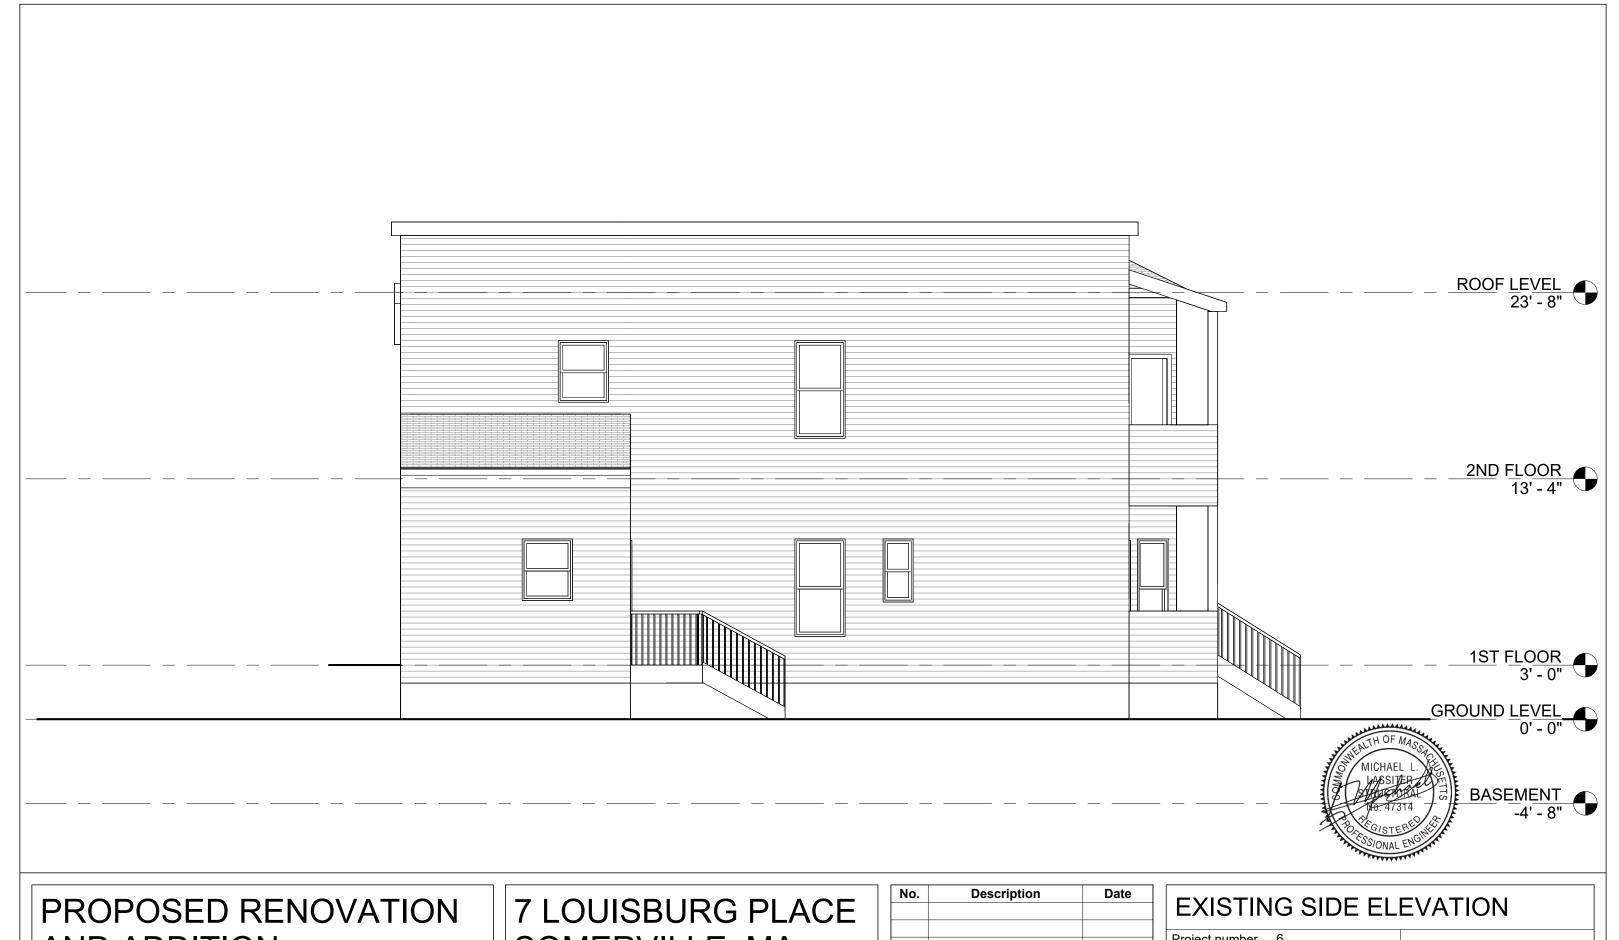

AND ADDITION


SOMERVILLE, MA

NO.	Description	Date

EXISTING SIDE ELEVATION		
Project number	6	
Date	11-06-2024	E-2.3
Orawn by	MS	
Checked by	MS	Scale 3/16" = 1'-0"



FRONT ELEVATION: TOTAL SQFT = 629 SQFT DEMO SQFT = 629 SQFT

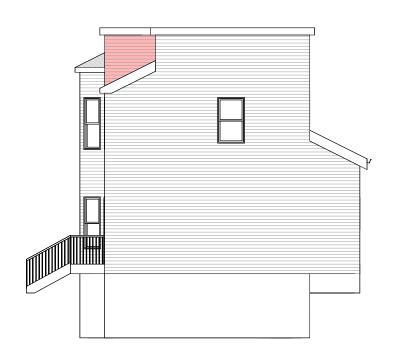


REAR ELEVATION: TOTAL SQFT = 742 SQFT DEMO SQFT = 21 SQFT



RIGHT SIDE ELEVATION: TOTAL SQFT = 1,231 SQFT DEMO SQFT = 512 SQFT



LEFT SIDE ELEVATION: TOTAL SQFT = 1,231 SQFT DEMO SQFT = 0 SQFT

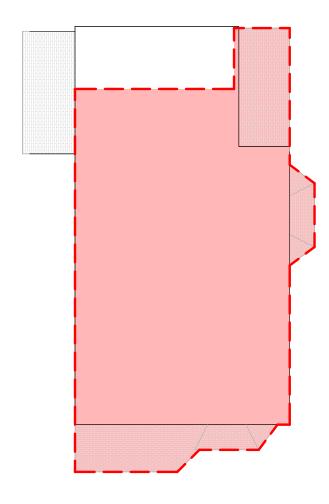

ROOF PLAN: TOTAL SQFT = 1,096 SQFT DEMO SQFT = 918 SQFT




TOTAL EXTERIOR SURFACE CALC: TOTAL SURFACE SQFT = 4,929 SQFT TOTAL DEMO SQFT = 2,080 SQFT DEMO PERCENTAGE = 42%

PROPOSED RENOVATION AND ADDITION

No.	Description	Date

Project number	6	– • 4
Date	11-06-2024	E-2.4
Drawn by	MS	
Checked by	MS	Scale 1" = 10'-0"

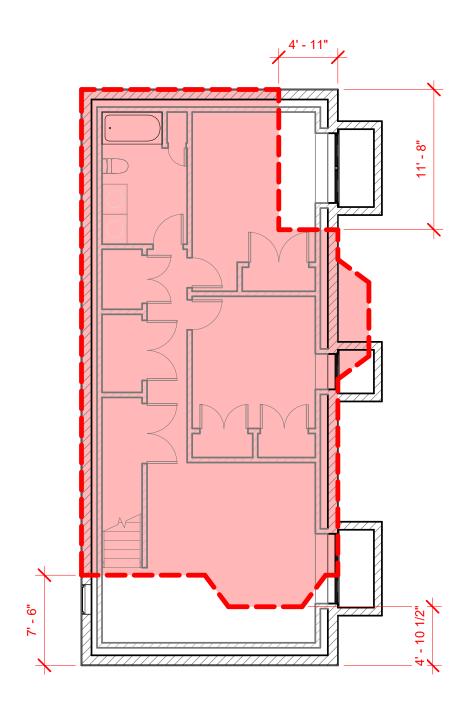

1 00_BASEMENT EXISTING OVERLAY 1/8" = 1'-0"




2 01_1ST FLOOR EXISTING OVERLAY 1/8" = 1'-0"




PROPOSED RENOVATION AND ADDITION

No.	Description	Date

EXISTIN	EXISTING OVERLAY PLANS	
Project number		
Date	11-06-2024	A-0.1
Drawn by MS		
Checked by	MS	Scale 1/8" = 1'-0"

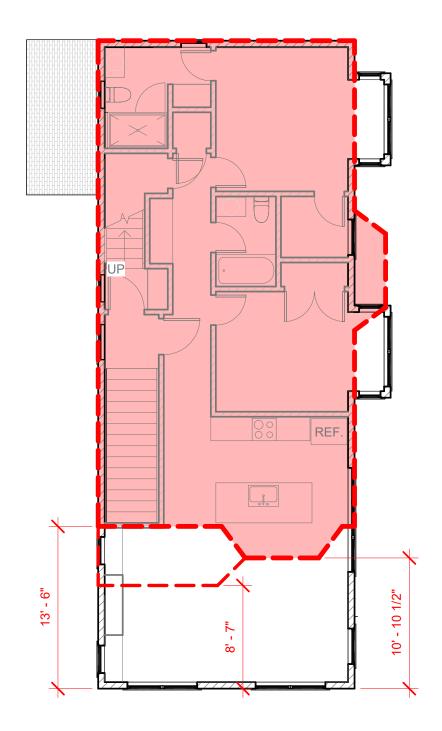

1 02_2ND FLOOR EXISTING OVERLAY 1/8" = 1'-0"

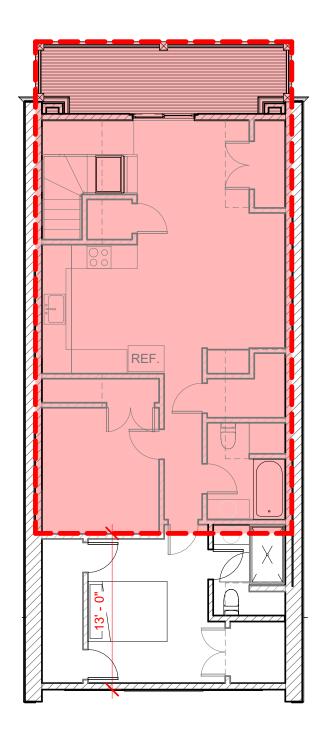


 $203_{1/8"}$ = 1'-0"



PROPOSED RENOVATION AND ADDITION

Description	Date
	Description

EXISTING OVERLAY PLANS			
Project number	6		
Date	11-06-2024	□ A-0.2	
Drawn by MS			
Checked by	MS	Scale 1/8" = 1'-0"	

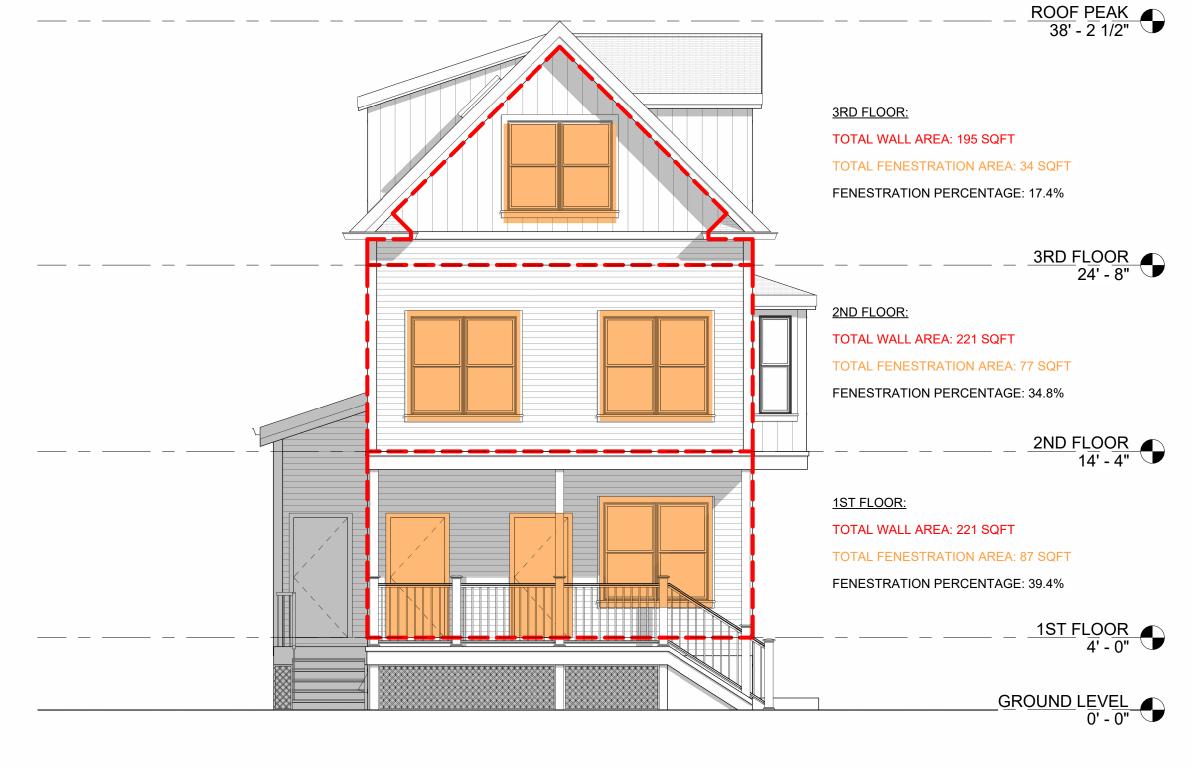


BASEMENT -5' - 0"



PROPOSED RENOVATION AND ADDITION

No.	Description	Date


OPENING CALCULATIONS		
Project number	6	
Date	11-06-2024	A-0.3
Drawn by		
Chacked by	MS	Scale 3/16" - 1' 0"

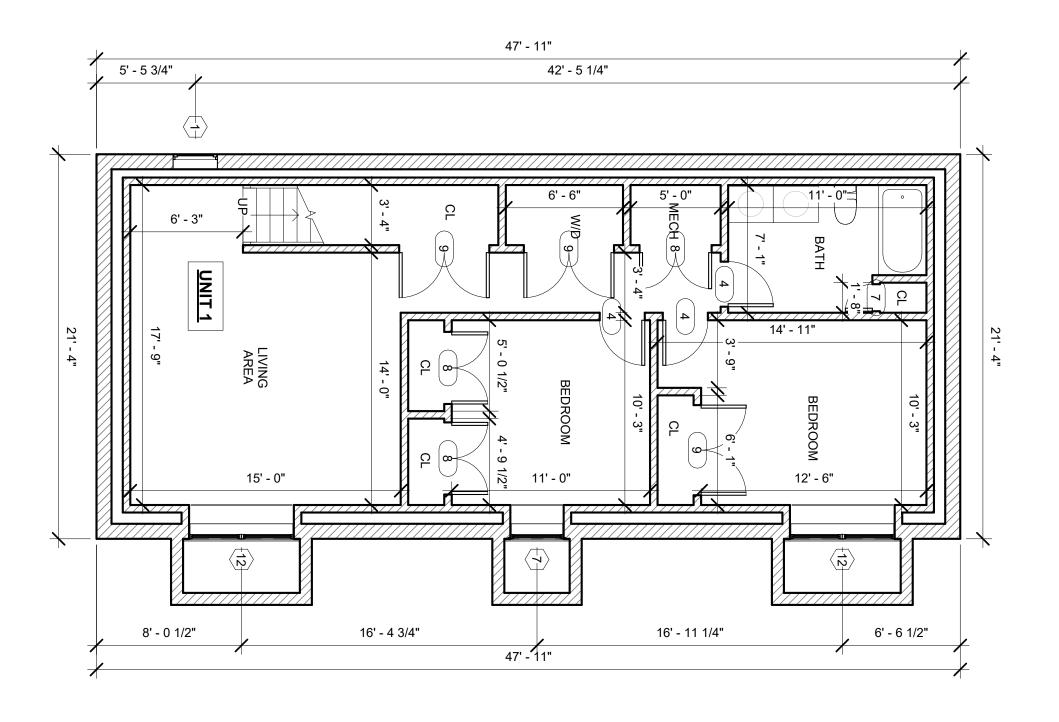



Date	า	Description	No.

PROPOSED BASEMENT PLAN		
roject number	6	
ate	11-06-2024	A-1.00
rawn by	MS	, (1100
Checked by	MS	Scale 3/16" = 1'-0"

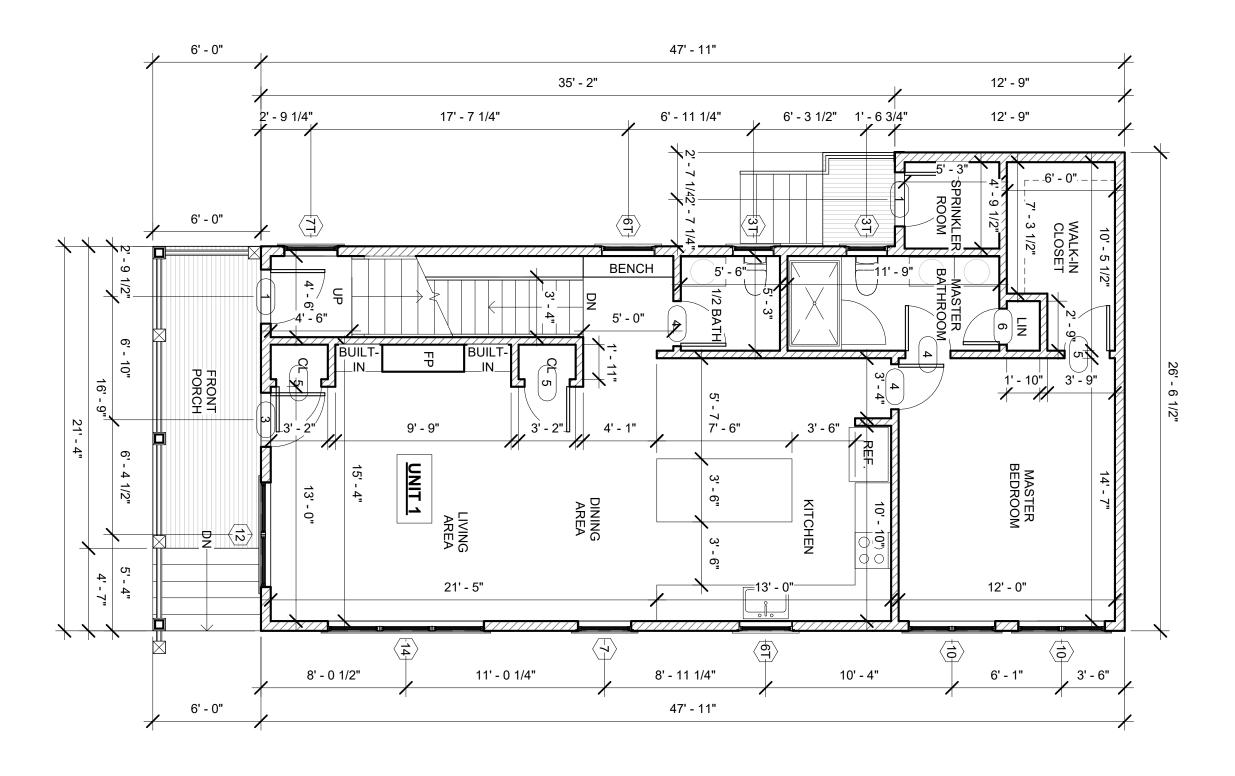




7 LOUISBURG PLACE SOMERVILLE, MA

No.	Description	Date

PROPOSED 1ST FLOOR PLAN

Project number	6	
Date	11-06-2024	A-1.10
Drawn by	MS	, , , , , , ,
Checked by	MS	Scale 3/16" = 1'-0"

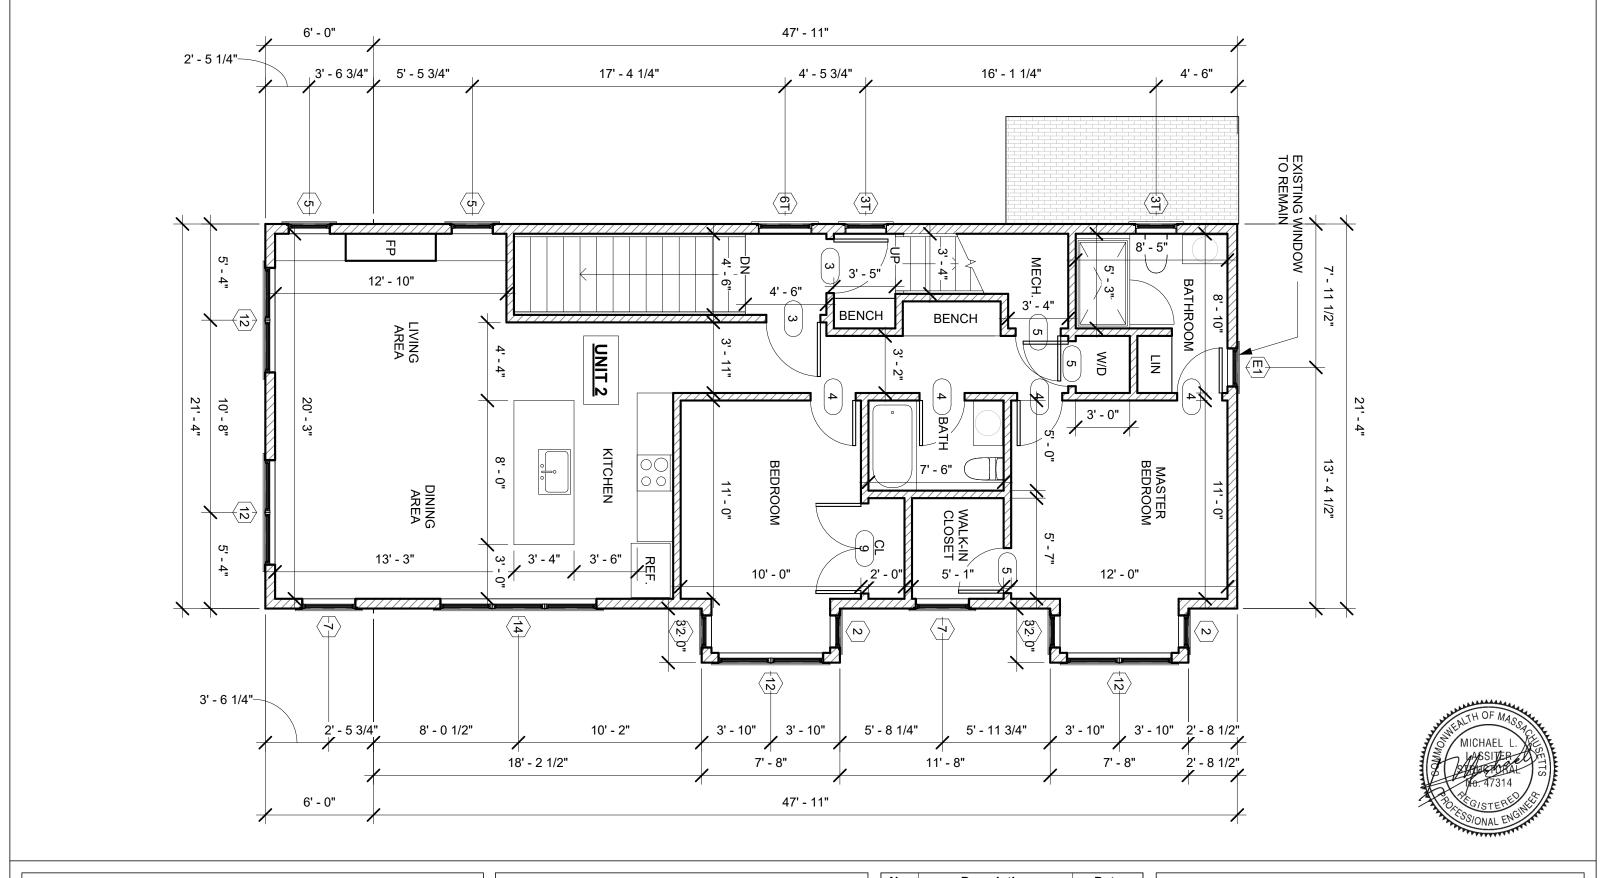


7 LOUISBURG PLACE SOMERVILLE, MA

No.	Description	Date

PROPOSED 2ND FLOOR PLAN

Project number	6	
Date	11-06-2024	A-1.20
Drawn by	MS	, () 1129
Checked by	MS	Scale 3/16" = 1'-0"

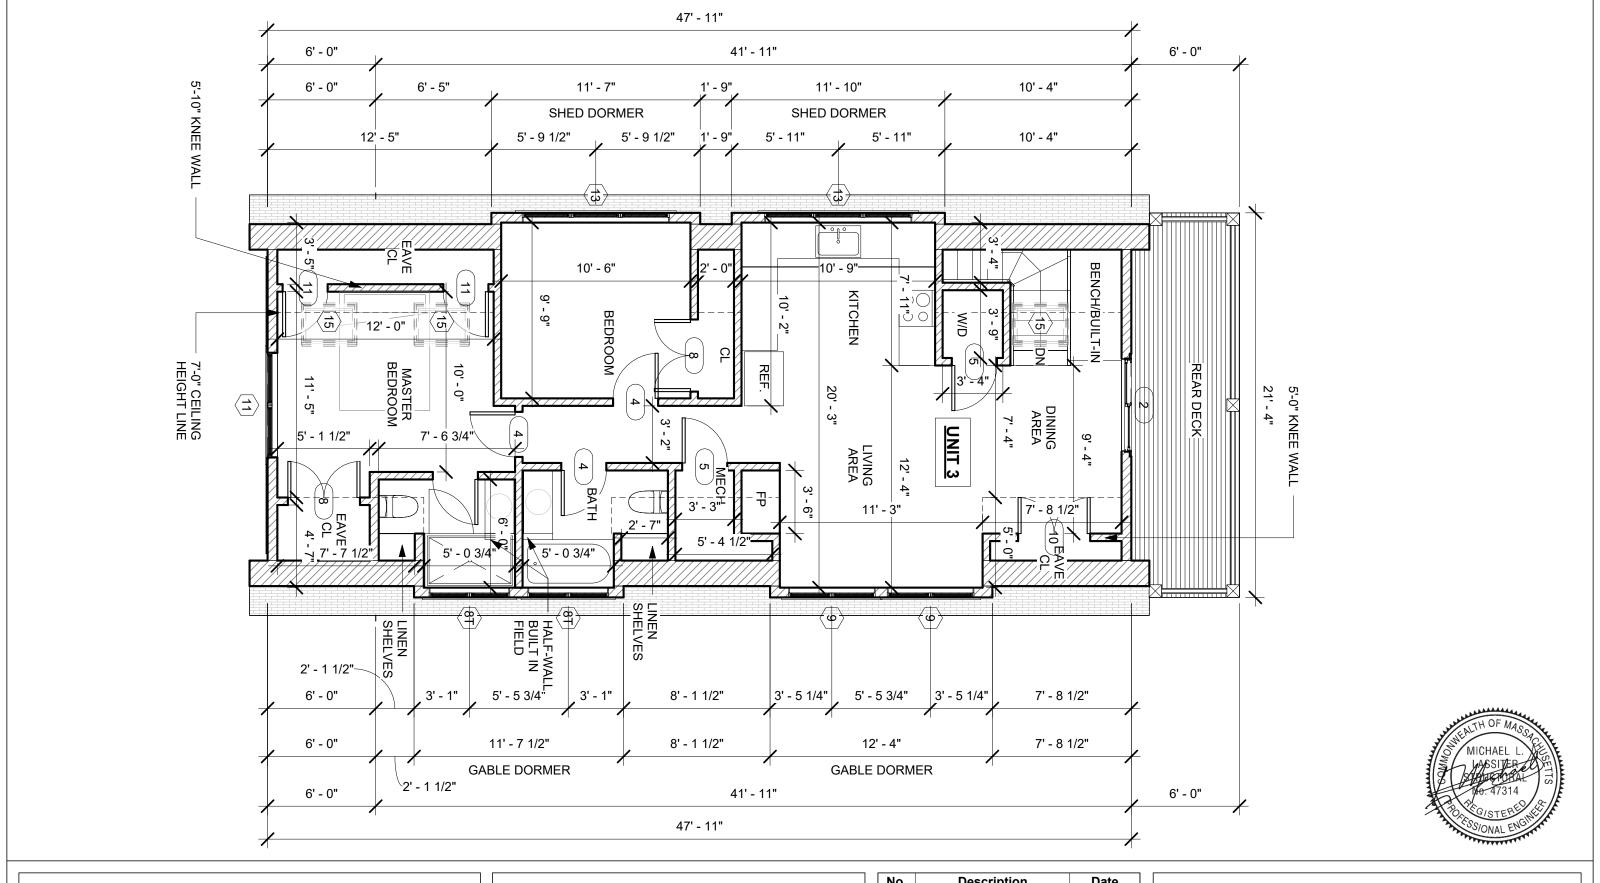


7 LOUISBURG PLACE SOMERVILLE, MA

No.	Description	Date

PROPOSED 3RD FLOOR PLAN

Project number	6	
Date	11-06-2024	A-1.30
Drawn by	MS	7 (1100
Checked by	MS	Scale 3/16" = 1'-0"

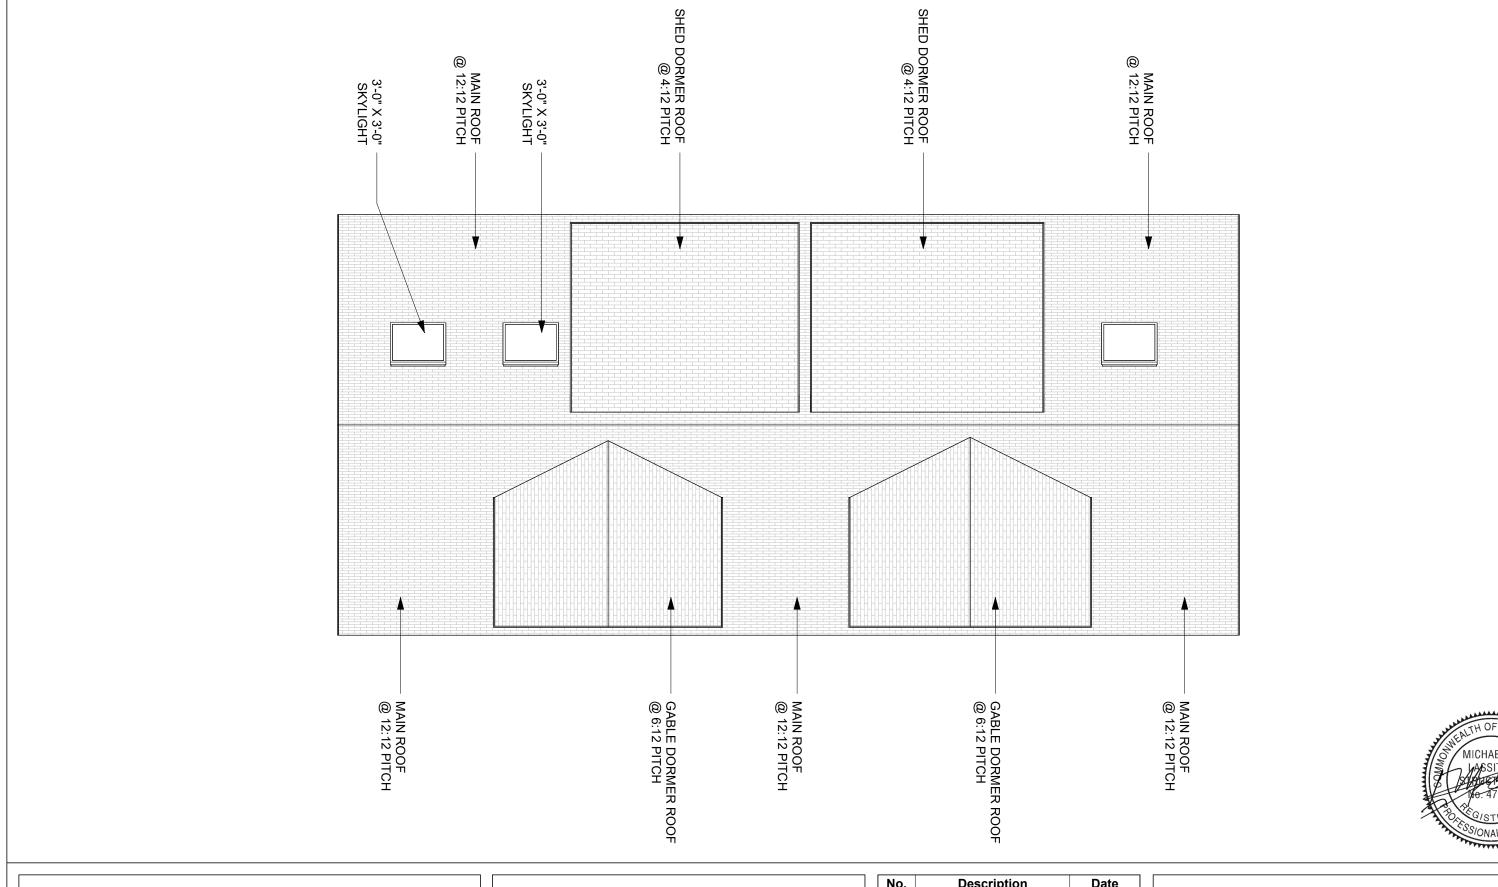



Scale 3/16" = 1'-0"

PROPOSED RENOVATION **AND ADDITION**

7 LOUISBURG PLACE SOMERVILLE, MA

Description	Date
	Description

PROPOSED ROOF PLAN		
Project number	6	
Date	11-06-2024	A-1.40
Drawn by	MS	, , , , , , , ,

Checked by





7 LOUISBURG PLACE SOMERVILLE, MA

Description	Date
	Description

PROPOSED FRONT ELEVATION

Project number	6	
Date	11-06-2024	A-2.0
Drawn by	MS	, \
Checked by	MS	Scale 3/16" = 1'-0"




7 LOUISBURG PLACE SOMERVILLE, MA

No.	Description	Date

PROPOSED SIDE ELEVATION

Project number	6	
Date	11-06-2024	A-2.1
Drawn by	MS	, ,
Checked by	MS	Scale 3/16" = 1'-0"

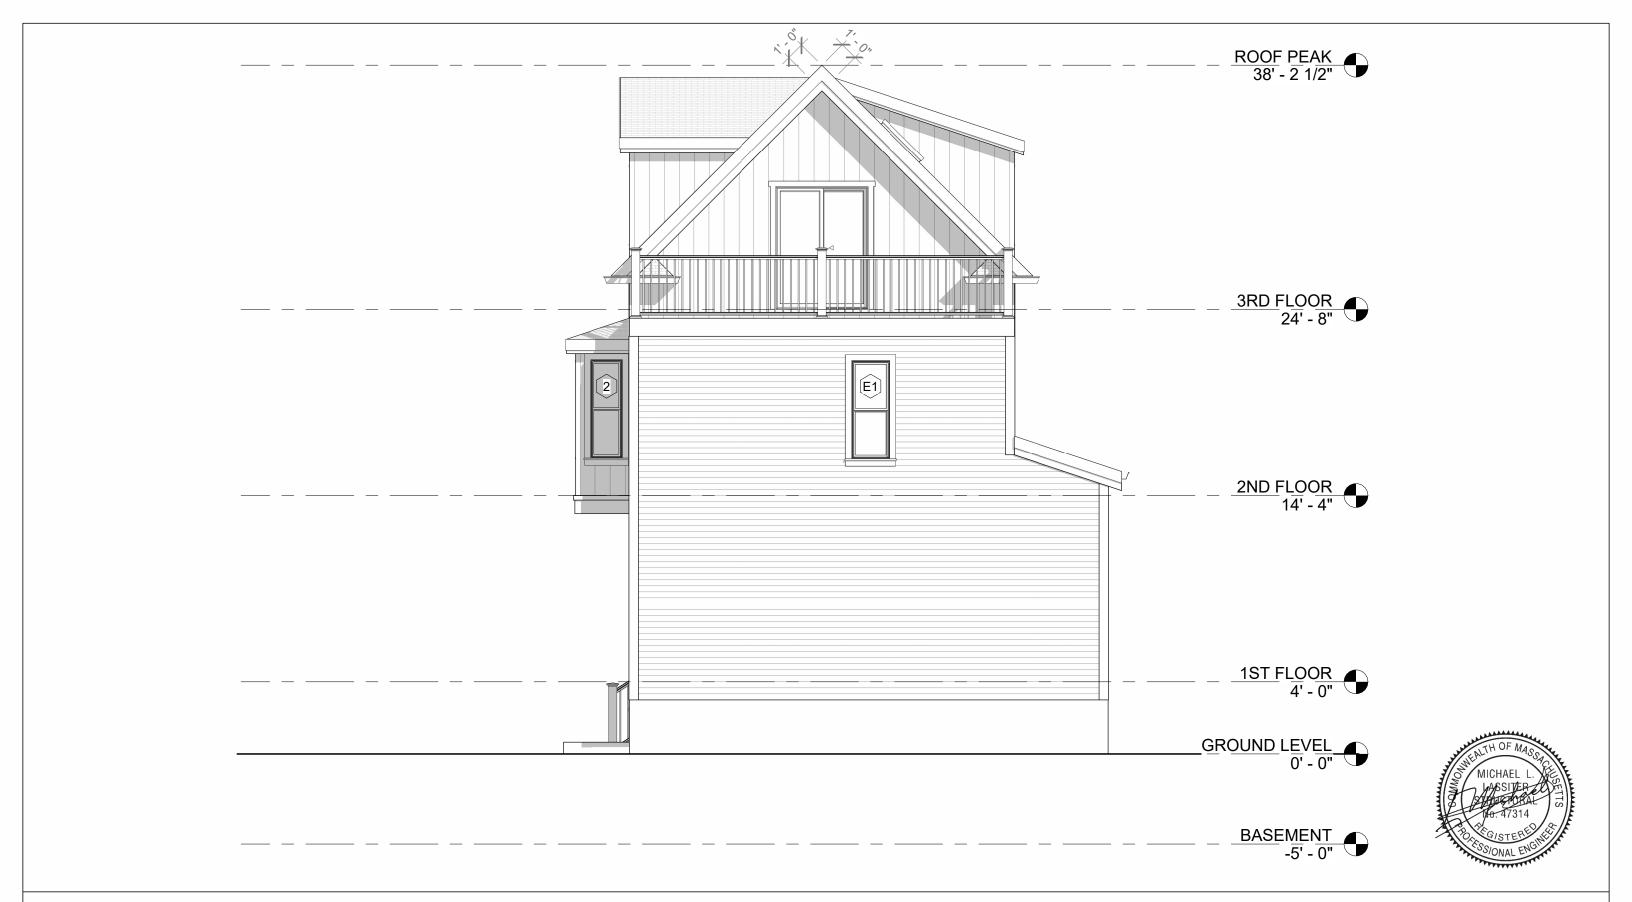

7 LOUISBURG PLACE SOMERVILLE, MA

No.	Description	Date

PROPOSED REAR ELEVATION

Project number	6	
Date	11-06-2024	A-2 2
Drawn by	MS	/ \ — ! —
Checked by	MS	Scale 3/16" = 1'-0"



7 LOUISBURG PLACE SOMERVILLE, MA

No.	Description	Date

PROPOSED SIDE ELEVATION		
Project number	6	
Date	11-06-2024	A-2.3
Drawn by	MS	, , , , , ,

Scale 3/16" = 1'-0"

Checked by

