REDEVELOPMENT OF 53 CHESTER ST

SOMERVILLE, MA 02144 A MIXED-USED COMMERCIAL AND RESIDENTIAL PROJECT



3D VIEW AT CHESTER STREET CORNER

PROGRAM SUMMARY

3 RESIDENTIAL UNITS 1 COMMERCIAL SPACE

3 PARKING SPACES
8 BIKE SPACES
4 LONG-TERM IN PARKING GARAGE
4 SHORT-TERM IN FURNISHING ZONE
OF SIDEWALK

PREPARED BY:

ARCHITECT
PETER QUINN
ARCHITECTS LLC

259 ELM ST, STE 301 SOMERVILLE, MA 02144 PH (617) 354 3989 SURVEYOR
BOSTON SURVEY,
INC.

UNIT C-4 SHIPWAY PLACE CHARLESTOWN, MA 02129 PH (617) 242 1313 LANDSCAPE ARCHITECT
VERDANT LANDSCAPE
ARCHITECTS
318 HARVARD ST, STE 25
BROOKLINE, MA 02446
PH (617) 735 1180

LIST OF DRAWINGS		NEIGHBORHOOD PRESENTATION 07 JUNE 2023	UDC SUBMISSION 12 JULY 2023	NEIGHBORHOOD PRESENTATION 28 NOV 2023	PB SP/SPR 18 JAN 2024	REV-1	REV-2	PB SP/SPR REV-3 8 OCT 2024	REV-4
GEI	NERAL								
T-1	TITLE SHEET	х	Х	Х	Х	Х	Х	Х	Х
	EXISTING CONDITIONS PLOT PLAN	х	Х	х	Х	Х	Х	Х	Х
L1-6	LANDSCAPE PLAN (9 SHEETS)		Х	х	Х	Х	Х		
Z-1	ZONING ANALYSIS - ZONING TABLE		Х	х	х	х	х	х	Х
Z-2	ZONING ANALYSIS - DIMENSIONAL SITE PLAN		Х	х	Х	х	х	х	Х
Z-3	ZONING ANALYSIS - GROSS SQ FOOTAGE		Х	х	х	х	х	Х	Х
Z-4	ZONING ANALYSIS - FENESTRATION CALCULATION		Х	х	Х	Х	Х	Х	Х
Z-5	ZONING ANALYSIS - LOT CALC. & BLDG HEIGHT		Х	х	Х	Х	Х	Х	Х
Z-6	ZONING ANALYSIS - LOBBY ENTRANCE, STOREFRONT					Х	Х	Х	Х
Z-7	ZONING ANALYSIS - BAY WINDOWS					Х	Х	Х	Х
Z-8	ZONING ANALYSIS - SEC. 8.2.5 COMPLIANCE							Х	Х

ARC	HITECTURAL								
A0.1	3D VIEW	Х	Х	х	Х	Х	Х	х	Х
AS-1	CONTEXT SITE PLAN		Х	Х	Х	Х	Х	Х	Х
A-1	FIRST FLOOR PLAN	Х	Х	Х	Х	Х	Х	Х	Х
A-2	SECOND FLOOR PLAN	Х	Х	х	Х	х	Х	Х	Х
A-3	THIRD FLOOR PLAN						Х	Х	Х
A-4	FOURTH FLOOR PLAN	Х	Х	Х	Х	Х	Х	Х	Х
A-5	ROOF PLAN	Х	Х	х	Х	х	х	х	Х
A-6	HERBERT STREET ELEVATION (STUDY #1)	Х	Х	х	Х	х	Х	Х	Х
A-7	CHESTER STREET ELEVATION (STUDY #1)	Х	Х	х	Х	Х	Х	Х	Х
A-8	RIGHT ELEVATION (STUDY #1)	Х	Х	Х	Х	Х	Х	Х	Х
A-9	REAR ELEVATION (STUDY #1)	Х	Х	х	Х	х	х	Х	Х
A-10	STREETSCAPE ELEVATION (STUDY #1)	Х	Х	х	Х	х	х	х	Х
A-5a	HERBERT ST ELEVATION (STUDY #2)		Х	х	Х	Х			
A-6a	CHESTER ST ELEVATION (STUDY #2)		Х	Х	Х	Х			
A-5b	HERBERT ST ELEVATION (STUDY #3)		Х	х	Х	х			
A-6b	CHESTER ST ELEVATION (STUDY #3)		Х	х	Х	х			
A-11	TRANSVERSE SECTION	Х	Х	х	Х	Х	Х	Х	Х
A-12	CROSS SECTION			х	Х	Х	Х	Х	Х
A-13	MATERIALS BOARD		Х	х	Х	Х	Х	Х	Х
SH 1-3	SHADOW STUDY (3 SHEETS)	Х	Х	Х	Х	Х	Х	Х	Х



PETER QUINN ARCHI TECTS

> ARCHITECTURE PLANNING INTERIOR DESIGN

PETER QUINN ARCHITECTS LLC 259 ELM STREET, SUITE 301 SOMERVILLE, MA 02144 PH 617-354-3989

AL

CONSULTANT

53 CHESTER ST

53 CHESTER STREET SOMERVILLE, MA 02144

PREPARED FOR

G2 PAR SOMERVILLE LLC

62 BLACK ROCK RD. COHASSET, MA 02025


DRAWING TITLE


TITLE SHEET


SCALE AS NOTED

REVISION	DATE
B SP/SPR REV-4	6 NOV 2024
B SP/SPR REV-3	8 OCT 2024
B SP/SPR REV-2	5 SEP 2024
B SP/SPR REV-1	26 AUG 2024
B SP/SPR	18 JAN 2024
DRAWN BY MN / YC	REVIEWED BY PQ


LOCUS PLAN 🗥

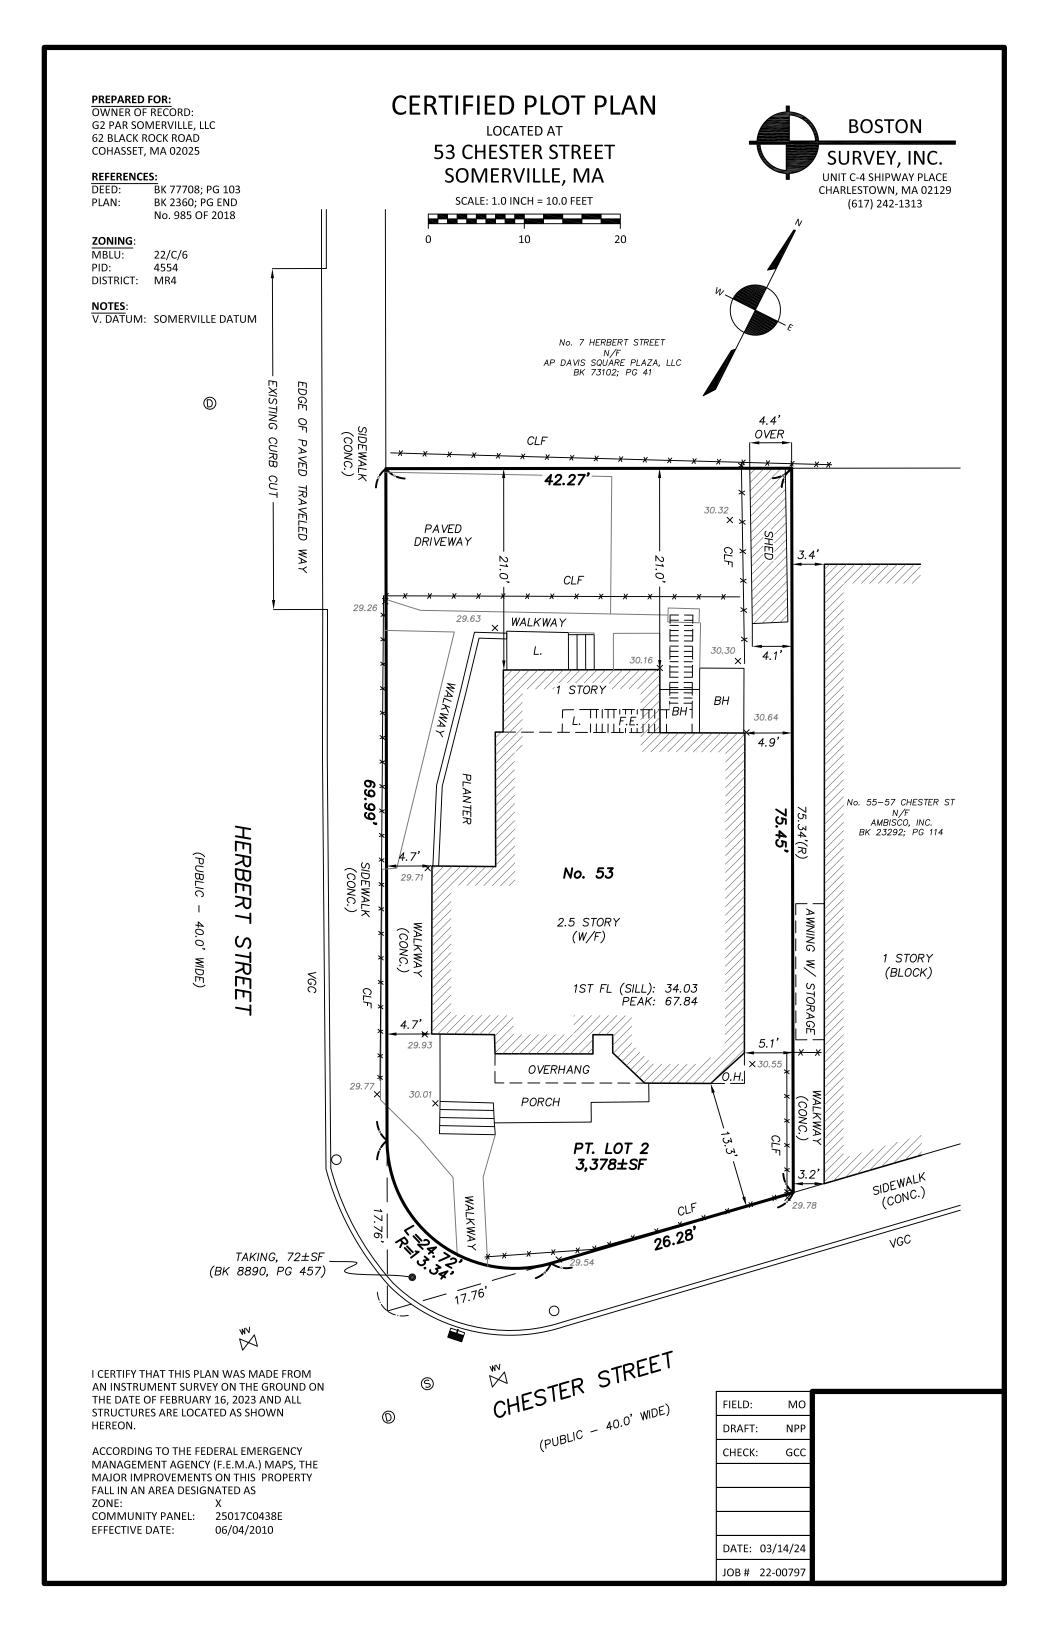

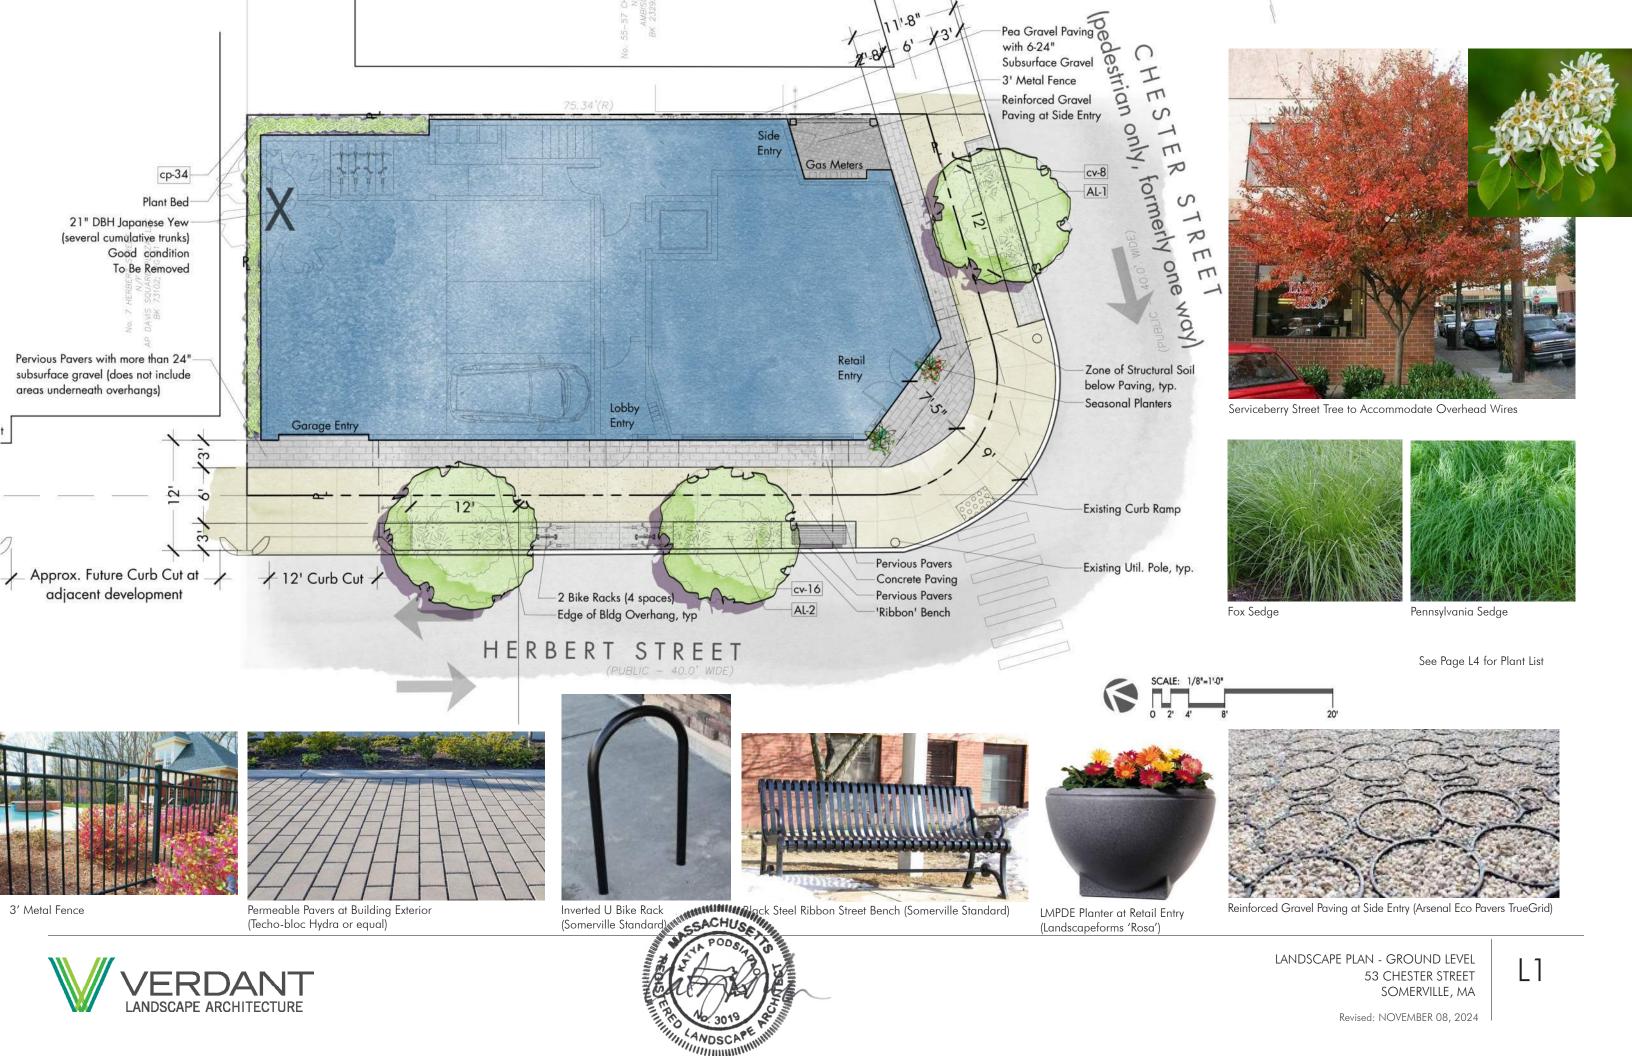

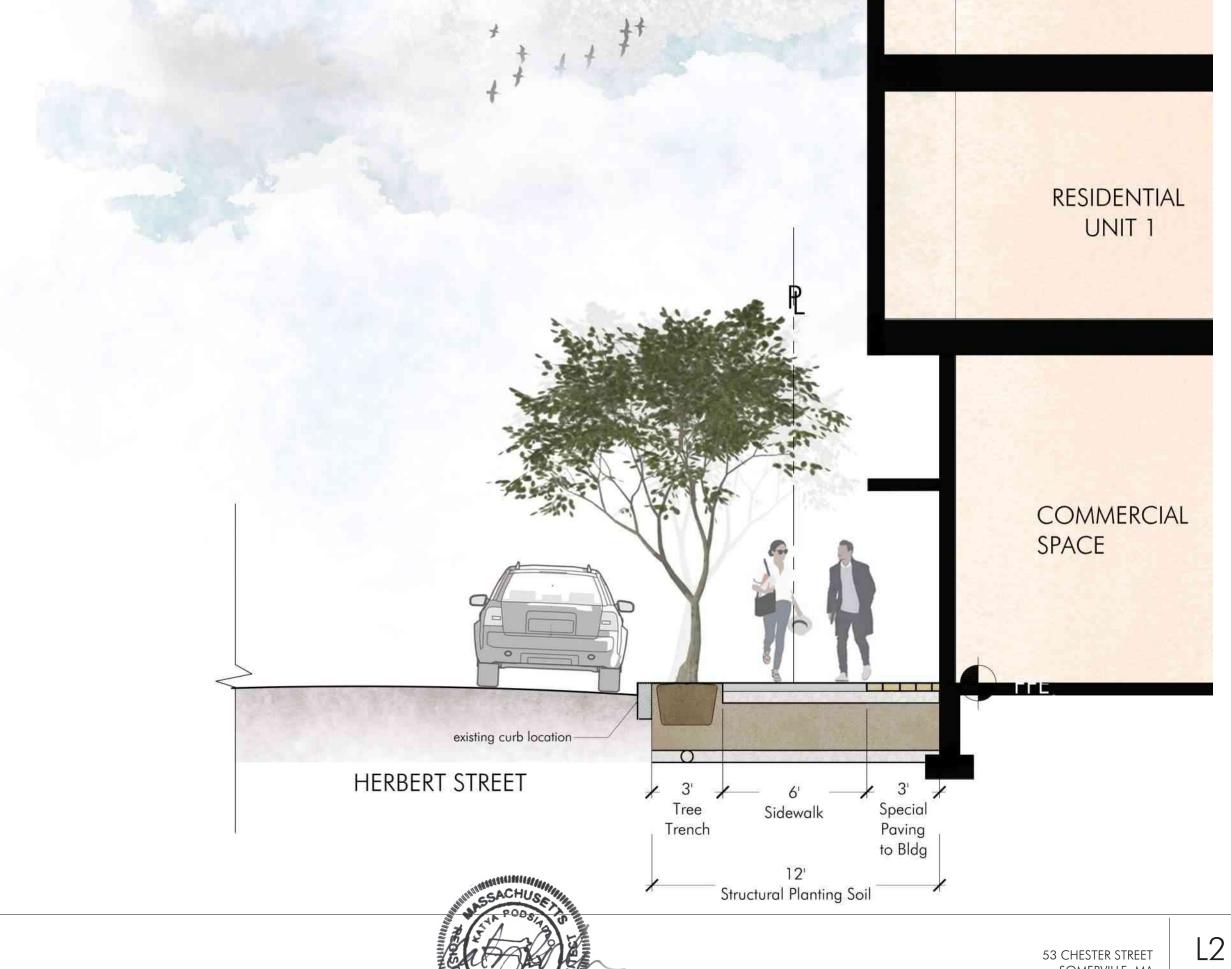



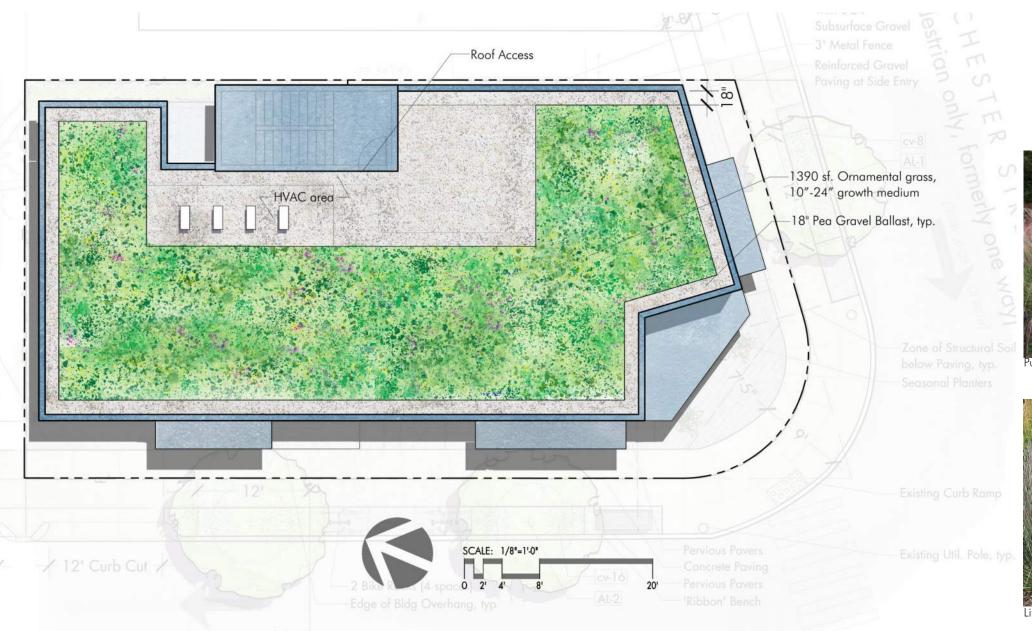









Bottlebrush Grass







Pea Gravel Ballast







TREES TO BE REMOVED				
SPECIES DBH (in) COMMENTS				
Japanese Yew	21 (multiple trunks cumulative sum)	Good Condition, Within proposed		
		construction site		

SYMB QTY.	LATIN NAME	COMMON NAME	SIZE	NOTES
TREES				
AL 3	Amelanchier laevis	Allegheny Serviceberry	2.5-3" cal.	B+B single stem
PERENNIAL	5			
cv 24	Carex vulpinoidea	Fox Sedge	1gal.	Pot
ср 34	Carex pensylvanica	Pennsylvania sedge	1gal.	Pot
-1-	,	,	-	Some

PRO	POSED PL	ANT LIST: ROOFDECK			
SYM	NB QTY.	LATIN NAME	COMMON NAME	SIZE	NOTES
		-			
ORN	VAMENTA	AL GRASS			
es	275	Eragrostis spectabilis	Purple Love Grass	1 qt.	15" o.c.
sh	100	Sporobolus heterolepis	Prairie Dropseed	1 qt.	18" o.c.
SS	115	Schizachyrium scoparium	Little Bluestem	1qt.	24" o.c.
eh	120	Elymus hystrix	Bottlebrush Grass	1qt.	20" o.c.

Somerville Green Score: 53 Chester Revised 8/27/24

	Area or Number	ıber	
	3,375		
		_	
Soils			
Landscaped area with a soil depth less than 24 inches	0	ã	
Landscaped area with a soil depth equal to or greater than 24 inches	97	ã	
Pervious Paving with 6 to 24 inches of subsurface soil or gravel	25	á	
Pervious Paving with more than 24 inches of subsurface soil or gravel	151	ā	
Groundcovers			
Turf grass, mulch, and inorganic surfacing materials	0	á	
Plants			
Vegetation less than two (2) feet tall at maturity	97	ā	
Vegetation at least two (2) feet tall at maturity	0		
Trees			
Small Tree	0		
Large Tree	0		
Preserved Tree	0		
Engineered Landscape			
Vegetated Wall	0	ā	
Rain gardens, bioswales, and stormwater planters	0	ā	
Green Roof with up to 6" of growth medium	0	ā	
Green Roof with 6"-10" of growth medium	0	ā	

Green Roof of 10"-24" growth medium Green Roof of over 24" growth medium

Sq Ft Credit	Multiplier	Weighted Area	Score Value	% of Sco
actual sq ft	0.3	0	0.000	0%
actual sq ft	0.6	58.2	0.017	6%
actual sq ft	0.2	5	0.001	1%
actual sq ft	0.5	75.5	0.022	8%
actual sq ft	0.1	0	0.000	0%
actual sq ft	0.2	19.4	0.006	2%
12	0.3	0	0.000	0%
50	0.6	0	0.000	0%
450	0.6	0	0.000	0%
65	0.8	0	0.000	0%
actual sq ft	0.1	0	0.000	0%
actual sq ft	1.0	0	0.000	0%
actual sq ft	0.1	0	0.000	0%
actual sq ft	0.4	0	0.000	0%
actual sq ft	0.6	834	0.247	84%
Calculat	te as if soils, groun	dcovers, plants, ar	nd trees	N/A
				•

Green Score = 0.294


Required Scor Target Scor Actual Green Scor

1390

	Green Score District Requirements					
	NR & UR	MR3 & MR4	1R5, MR6, & HR	FAB, CC, CB, C		
ore:	0.35	0.25	0.20	0.20		
ore:	0.40	0.3	0.25	-		
ore:	0.294	0.294	0.294	0.294		







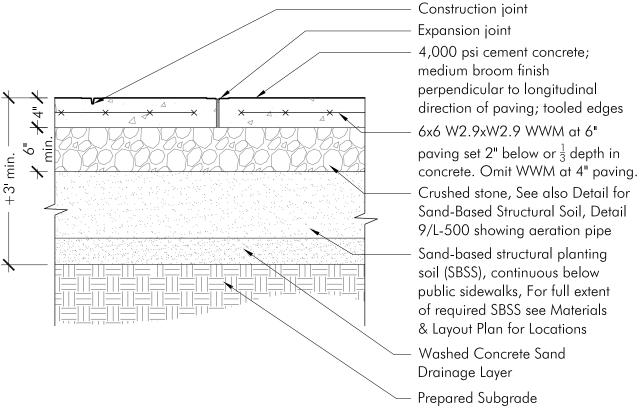

Notes:

- See Civil Engineer Plans + Details for additional information.
 Provide expansion joint between concrete paving & <u>all</u> structures unless specifically directed by owner or Landscape Architect.
- 2. Provide 6" depth concrete at bike racks, benches and other site furnishings as noted on details.
- 3. All construction joints shall be 5' o.c. typical unless otherwise noted.
- 4. Expansion joints every 30' o.c. both ways and as noted.

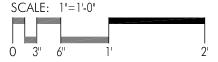

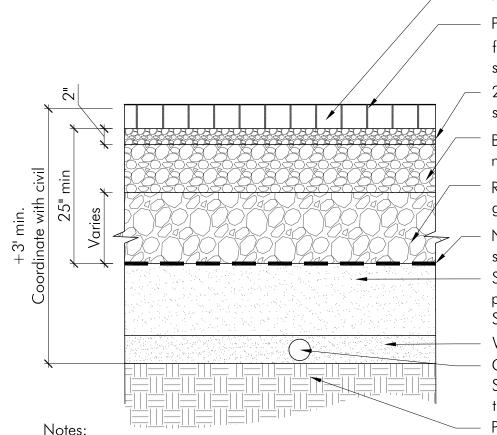

Permeable Pavers, see specifications

Permeable joint opening aggregate; filled with $\frac{3}{8}$ " open graded crushed, angular stone; (ASTM #9)

2" Leveling Course open graded stone (ASTM #8)

Base Course $\frac{3}{4}$ "-1" open graded stone no fines (ASTM #57)

Reservoir Course $1\frac{1}{2}$ "-3" open graded stone no fines (ASTM #2)


Non-woven Geotextile soil separation, see specification


Sand-based structural planting soil (SBSS), public sidewalk, For full extent of required SBSS see Materials & Layout Plan for Locations

Washed Concrete Sand Drainage Layer Continuous 4" ADS Perf. Pipe, covered w Drain Sock, below all permeable unit pavers, connected to stormdrain system, see Civil Eng. Plans Prepared Subgrade


1. Edge restraints may vary.


- 2. All aggregate material shall be crushed, angular stone and free of fines.
- 3. Compact subsoil with a California bearing ratio (cbr) of less than 5% as directed by a professional engineer.
- 4. Surface slope shall be a minimum of 1% and a maximum of 5%.
- 5. Install pvc underdrain pipe where infiltration rate of subsoil is less than 0.5 in./hr. size as directed by a professional engineer.
- 6. Never build permeable pavements on organic clay soils of high plasticity and/or peat, mulch, soils with high organic content.
- 7. Maintain a minimum distance of 2' between bottom of permeable base and water table.
- 8. The minimum aggregate thicknesses are after compaction.

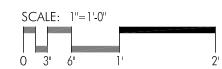


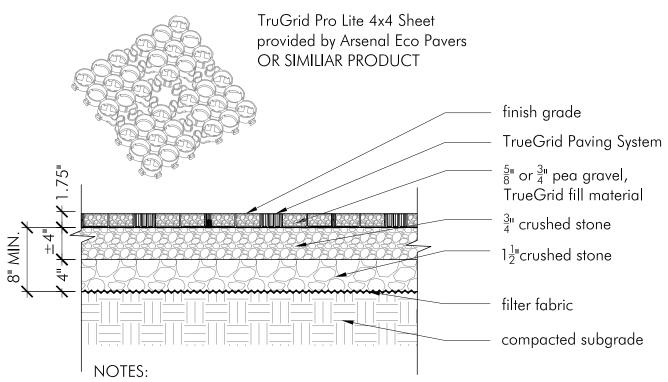


- 1. TruGrid Pro Plus by TrueGrid Paver provided by Arsenal Eco Pavers OR SIMILAR PRODUCT
- 1.1. arsenalecopavers.com
- 1.2. See manufacturer's specifications
- 1.3. Preassembled & delivered in 4'x4' sheet. Reconfigured as needed. No extra tooling or accessories required.
- 2. Geogrid mesh or geofabric may be required between subgrade and subbase for certain soils and site specific requirements.
- 3. No staking necessary when slope is $<10^{\circ}$.
- 4. Final engineered cross section aggregates and depth should allow for expected infiltration rates, storage capacities, outlet flow rates, and other site specific conditions and load requirements.

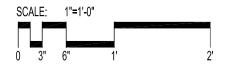

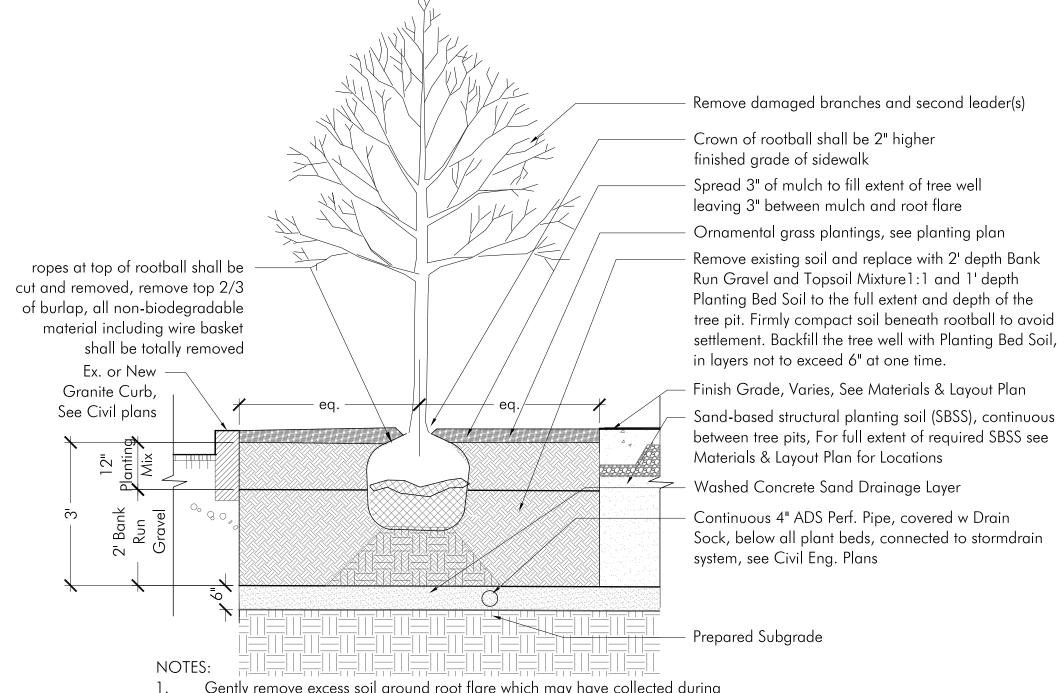

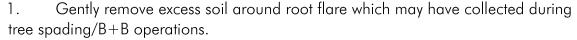



- 2. Provide wooden stakes (2 per tree) and guy wire (rubber hose cover at trunk) in windy locations and as site conditions require, as directed by Landscape Architect.
- 3. See Soil Specifications for Planting Mix, Bank Run Gravel, Concrete Sand, and Sand-Based Structural Soil.

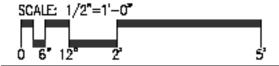






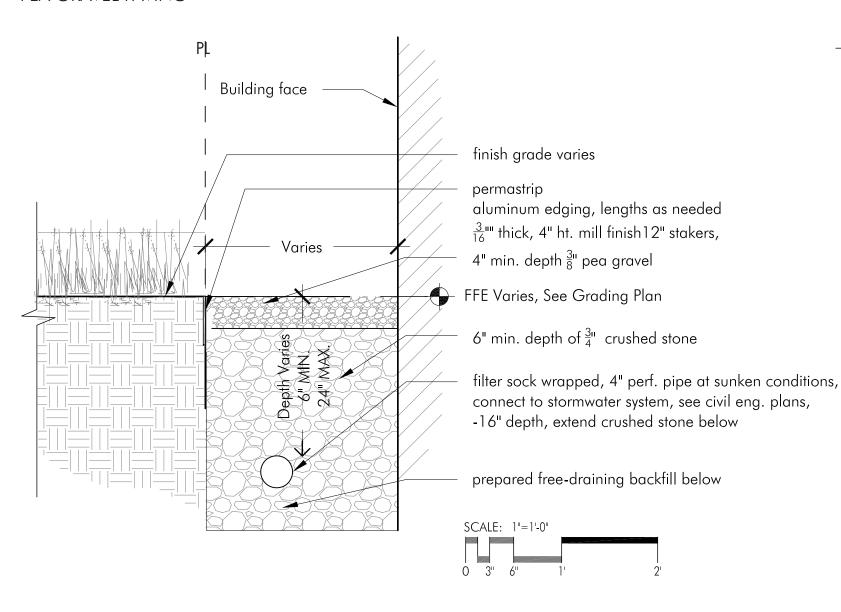

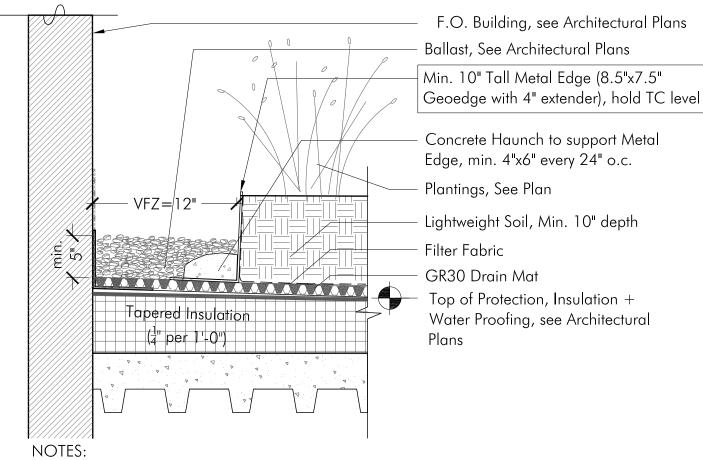

- 1. Follow manufacturer's installation recommendations
- 2. Metal Edge: GeoEdge by Permaloc, finish shall be anodized Silver

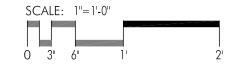



NOTES

- I. Green roof modules are to be delivered in good condition. Green roof modules are to be handled carefully to prevent damage to the plants. Modules shall have plastic unwrapped (if shipped on pallets) the same day as delivery to avoid plant damage caused by overheating.
- 2. Conduct roof top staging of green roof system components after verifying roof loads and acceptable staging areas. Stage green roof modules over plywood panels or protective sheeting.
- 3. Green roof modules are to be conveyed to the roof surface with equipment that is designed and certified to hoist the associated weights safely and in accordance with equipment capacity, and local codes and regulations.
- 4. Protect the roof deck and waterproofing membranes using appropriate materials such as plywood sheeting. Avoid using sharp tools and keep the roof surfaces clean and free of soil, grit, or debris.
- 5. The vegetated green roof system Installer shall maintain the modules for at least 30 days following installation.
- 6. Maintenance during the initial 30-days shall follow industry accepted horticultural practices. Watering: two watering events per week to sufficiently saturate the growing medium. Provide spot weeding (by hand), as needed, to maintain plant health and prevent weed to flower and set seed, and to prevent woody plants to establish. Do not use any pesticides which include herbicides. Repair, rework and replant, if necessary, areas where wash out caused erosion, and replace dead plants.
- 7. Maintenance protocols: Provide the GreenGrid® maintenance guide and protocols to the Owner for extended maintenance of the green roof system. Provide a report(s) to the Owner outlining post-installation green roof conditions and observations about plant care and the initial maintenance period.
- 8. Irrigation: Irrigation lines to be inserted through an integrated irrigation channel in the module during

- installation. Water shall be delivered directly and evenly to plants for uniform plant growth. Pop-up sprinklers and spray systems are commercially available. Consult a qualified irrigation specialist to determine appropriate design, system details and configuration, materials and maintenance requirements.
- 9. Edge Treatment: Provide decorative edge treatment from Permaloc, or equivalent suppliers, in multiple sizes, and color for use as landscape edging around the perimeter of the vegetated green roof system in all depths.
- 10. Stone Ballast: Clean stone or 'river rock', nominal I-1/2" diameter minimum (#4) rounded stone can be used to infill around roof drains or along irregular-shaped areas.
- 11. Drain Covers: Stainless steel drain enclosure and cover to enclose roof drains. Provide standard 24-inch by 24-inch or custom sizes as necessary to fit roof drains and fit within modular green roof system. Drain covers shall have L-shaped tabs at the bottom edges to anchor beneath the modules.
- 12. Qualified Installers including General Contractors, Roofing Contractors and Landscape Contractors can install the GreenGrid® system by following the Installation Guide. A pre-installation conference call/meeting may be appropriate for new Installers. Install the vegetated green roof system according to specifications, applicable codes and regulations.
- 13. Safety: Installers are solely responsible to comply with all applicable safety and fall protection codes, laws and regulations as required by federal, state and local codes and regulations.
- 14. When plants are properly adapted and acclimated to the local weather conditions. In northern climates and unless otherwise permitted, modules shall be installed between April 15th and October 1st, except when temperatures are below 35° F. In more southern climates, the installation season will depend on seasonal weather conditions.
- 15. Handle the modules with care. Do not drop, kick or

- point-load the modules during installation. Place modules above the slip sheet or protective layer in accordance with the landscape design or layout Drawing. Modules shall be placed in straight rows, positioned tight beside each module and in proper orientation according to the landscape design.
- 16. After installation, modules shall be immediately watered so as to thoroughly moisten growing media throughout. Water shall be free of substances harmful to plant growth.
- 17. Do not install modules directly in low sections of roof where water ponds or where modules will block flow of drainage, or on saturated roof surface or during freezing weather conditions.
- 18. If required, install an irrigation system according to the manufacturer specifications and instructions. If an irrigation system is not required, provide hoses/sprayers for temporary irrigation, as needed, to conduct initial watering for plant maintenance.
- 19. Cut modules, only if necessary, to offset structures or roof edges, or around obstructions. Install partial or cut planter modules with the cut edge facing another module or edging.

IRRIGATION NOTES


- I. The Contractor shall provide a complete irrigation plan as described in the specifications.
- 2. The Contractor shall provide water supply through a second meter for the rooftop Greenroof within the Sprinkler room or mechanical room. A backflow preventer and hose-bib (or faucet) shall be provided to drain out the water supply line to the roof.
- 3. At the rooftop, the Contractor shall provide winterization/blowout configuration, including any additional back flow value as may be required by code. Beyond the winterization appurtenances, the Contractor shall provide a valvebox for the irrigation spray zones as may be needed depending on the water pressure at the roof.



GREEN ROOF NOTES 53 CHESTER STREET SOMERVILLE, MA

DIMENSIONAL TABLE FOR 53 CHESTER ST

- MR4 ZONING DISTRICT
- QUARTER MILE STATION AREA WALKSHED
- ON A PEDESTRIAN STREET
- GENERAL BUILDING BUILDING TYPE

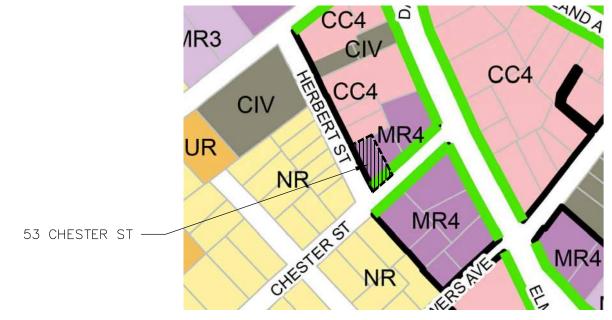

ZONING DISTRICT - MR4



WALKSHED - QUARTER MILE

53 Chester Street	ZONING ITEM MR4 Zone General Building In 1/4 Mile Walkshed On a Pedestrian Street	ALLOWED/ REQ.	PROPOSED MAXIMUM SCHEMATIC DESIGN	COMMENTS
	Building Type	Per Sec. 4.2.6.b	General Building	Complies
	Lot Area	N/A	3,378-SF	Complies
±	Min. Lot Width (min)	30'	41.30'	Complies
Lot	Max. Lot Coverage (max)	90%	88.80%	Complies
	Green Score	0.25 / 0.3 Ideal	See Landscape Drwgs	Complies
	Open Space (min)	15%	16%	Complies
	Primary Front Setback	2' min. 15' max. 12' Sidewalk min.	5.4' 12.1' Sidewalk	Complies Complies
Setbacks	Secondary Front	2' min. 15' max. 12' Sidewalk min.	6.1' 12.1' Sidewalk	Complies Complies
Se	Side Setback	0'	1'-6" and 6"	Complies
	Rear Setback	N/A	N/A	N/A
Parking Setbacks	Primary Front Setback	30' Surface Pkg 30' Structured Pkg	N/A	N/A
Park Setb	Secondary Front Setback	10' Surface Pkg 2' Structured Pkg	6'-9" Structured Pkg	Complies
	Building Width (max) Buildout: Primary Front (min) Secondary Front (min)	200' 80% 65%	73.8' 86.2% 91.6%	Complies Complies Complies
	Max. Floor Plate (max)	15,000-SF	2,456-SF	Complies
ing ing	Ground Story Height (min)	14'	15'-2"	Complies
Building	Upper Story Height (min)	10'	11' and 12'	Complies
_	Number of Stories	3 min, 4 max	4 Stories	Complies
	Building Height (max)	52'	49.4'	Complies
	Roof Type	Flat	Flat	Complies
- de	Ground Story Fenestration Primary Face Secondary Face	70% min 15% min, 70% max	70% 40%	Complies
Facade	Upper Story Fenestration	15% min, 50% max	28%	Complies
	Blank Wall (max)	20'	9.5'	Complies
-dr	Density Factor	1,500-SF / DU	9,110 GSF / 1,500 = 6.1 3 DUs shown	Complies
Use/ Occup.	Inclusionary Ratio	20%	N/A	N/A
	Outdoor Amenity	1/DU	1/DU Provided	Complies
Parking/ Bikes	Parking	1/DU max.	3 Provided for 3 DUs in 1/4 mile transit zone	Complies (Retail < 5,000 SF Section: 4.2.15.a.ii.a)
arkin	Bikes	0.1/DU Short Term	4	Complies
۵.	LEED Standards 25,000 - 50,000 GSF 50,000 and up GSF	1.0/DU Long Term Certifiable Gold Platinum	N/A	Complies N/A

ARCHITECTURE PLANNING INTERIOR DESIGN

PETER QUINN ARCHITECTS LLC 259 ELM STREET, SUITE 301 SOMERVILLE, MA 02144 PH 617-354-3989

SEAL SEAL ARCHIVES CONTROL OF THE CO

CONSULTANT

53 CHESTER ST

53 CHESTER STREET SOMERVILLE, MA 02144

PREPARED FOR

G2 PAR SOMERVILLE LLC

62 BLACK ROCK RD. COHASSET, MA 02025

DRAWING TITLE

DIMENSIONAL TABLE

SCALE AS NOTED

REVISION DATE


B SP/SPR REV-4	6 NOV 2024
B SP/SPR REV-3	8 OCT 2024
B SP/SPR REV-2	5 SEP 2024
B SP/SPR REV-1	26 AUG 2024
B SP/SPR	18 JAN 2024
DDAWN DV	DEVIEWED BY


MN / YC

Z-1

DCADDWGS\Chester-53\02 Schematic Design\Chester 53_Zoning.dwg, 07-Nov-24 1:48:20 PM, DWG To PDF.pc3



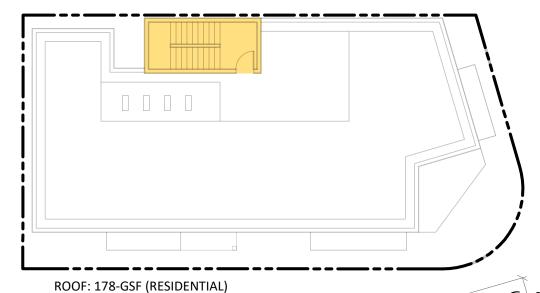


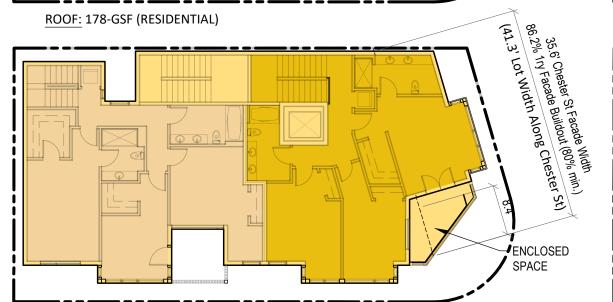



	PROPOSED GSF		
FLOOR	RESIDENTIAL	COMMERCIAL &/OR UTILITY	TOTAL
1ST FL	431	809	1,240
2ND FL	2,564	0	2,564
3RD FL	2,564	0	2,564
4TH FL	2,564	0	2,564
ROOF	178	0	178
SUB TOTAL	8,301	809	9,110-GSF

FOURTH FLOOR: 2,564-GSF (RESIDENTIAL)

PROPOSED GROSS SQ FOOTAGE
SCALE: 1/16" = 1'-0"

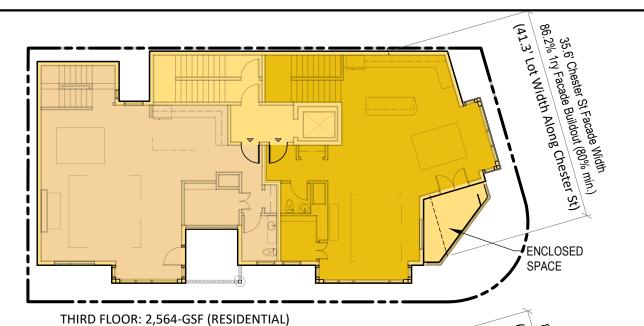

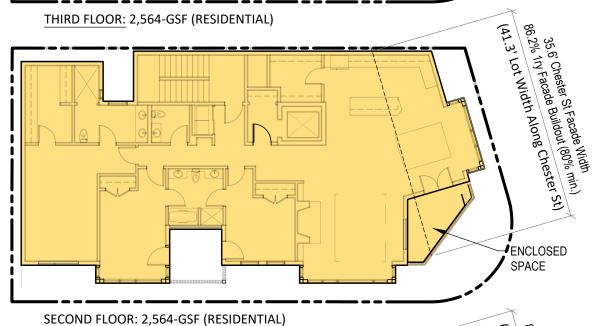

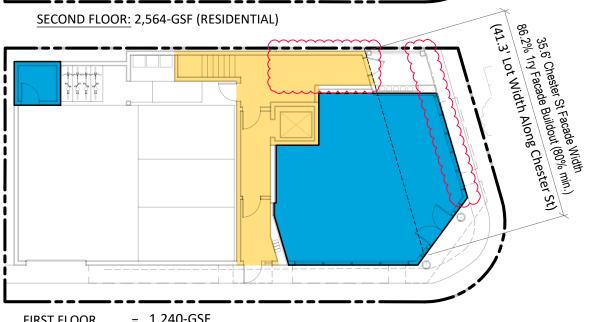

= 1,240-GSF RESIDENTIAL

= 431-GSF = 809-GSF COMMERCIAL

0' 5' 10' 20' ARCHITECTURE PLANNING INTERIOR DESIGN

PETER QUINN ARCHITECTS LLC 259 ELM STREET, SUITE 301 SOMERVILLE, MA 02144 PH 617-354-3989



53 CHESTER ST

53 CHESTER STREET SOMERVILLE, MA 02144

PREPARED FOR G2 PAR SOMERVILLE LLC


62 BLACK ROCK RD. COHASSET, MA 02025

DRAWING TITLE

GROSS SQUARE FEET

SCALE AS NOTED

REVISION DATE		
PB SP/SPR REV-4	6 NOV 2024	
PB SP/SPR REV-3	8 OCT 2024	
PB SP/SPR REV-2	5 SEP 2024	
PB SP/SPR REV-1	26 AUG 2024	
PB SP/SPR	18 JAN 2024	
DRAWN BY MN / YC	REVIEWED BY	

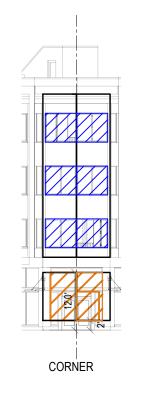



14.4-SF NEEDED. 246.4-SF MIN

CHESTER STREET ELEVATION

HERBERT STREET ELEVATION

SECONDARY FACADE FENESTRATION

Ground Floor: 27
Upper Floors: 77

PRIMARY FACADE FENESTRATION

_____ G

Ground Floor:

Upper Floors:

247 / 352 = ± 70 %

 ${310 / 1,125 = \pm 28 \%}$ (15% min, 70% max)

(70% min)

PETER QUINN ARCHI TECTS

ARCHITECTURE PLANNING INTERIOR DESIGN

PETER QUINN ARCHITECTS LLC 259 ELM STREET, SUITE 301 SOMERVILLE, MA 02144 PH 617-354-3989

SEAL



CONSULTAN

53 CHESTER ST

53 CHESTER STREET SOMERVILLE, MA 02144

PREPARED FOR

G2 PAR SOMERVILLE LLC

62 BLACK ROCK RD. COHASSET, MA 02025

DRAWING TITLE

FACADE FENESTRATION


SCALE AS NOTED

REVISION DATE

PB SP/SPR REV-4 6 NOV 2024
PB SP/SPR REV-3 8 OCT 2024
PB SP/SPR REV-2 5 SEP 2024
PB SP/SPR REV-1 26 AUG 2024

SHEET

Z-4

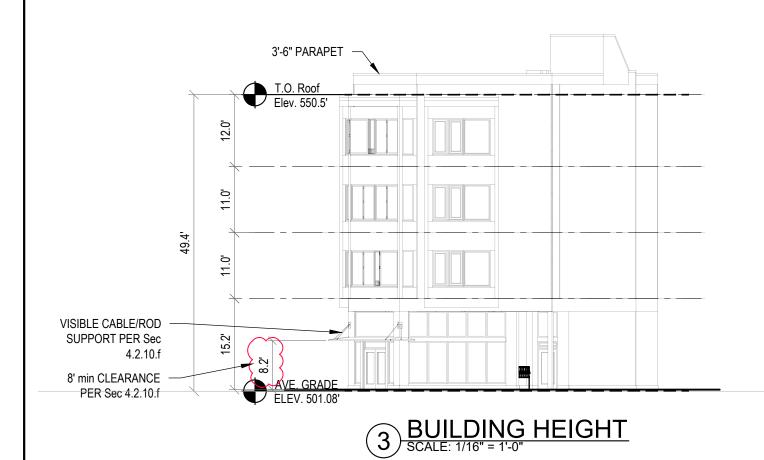


OPEN SPACE
SCALE: 1/16" = 1'-0"

OPEN SPACE -= **16**% LOT AREA 3,378-SF

Actual SF x Coeficient = Contributing SF ITEM GROUND STORY TO OUTSIDE OF EXTERIOR WALLS WITH 2,472-SF 2,472-SF 1.0 **GROUND STORY BUILDING COMPONENTS** PERMEABLE PAVERS BY UNILOCK OR EQUAL 375-SF 0.5 188-SF (ECOLOC-PERMEABILITY LISTED AT APPROX. 50%) **IMPERVIOUS MATERIAL** 352-SF 352-SF 1.0 LANDSCAPED AREA ON FULLY DRAINABLE PLANTING BEDS 0-SF N/A 0-SF **NATIVE SEDGE PLANTING** 97-SF N/A 0-SF **GRAVEL PAVE** 82-SF N/A 0-SF 3,012-SF Total 3,378-SF Lot Area Lot Coverage 89.15% (90% max.)

2 LOT COVERAGE
SCALE: 1/16" = 1'-0"

1) 10.3.5.a.i.g COMPLIANCE

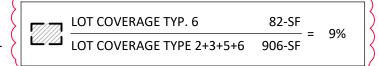

PLANNING INTERIOR DESIGN

PETER QUINN ARCHITECTS LLC 259 ELM STREET, SUITE 301 SOMERVILLE, MA 02144 PH 617-354-3989



53 CHESTER ST

53 CHESTER STREET SOMERVILLE, MA 02144

PREPARED FOR

G2 PAR SOMERVILLE LLC

62 BLACK ROCK RD. COHASSET, MA 02025

DRAWING TITLE

LOT COVERAGE OPEN SPACE, BLDG HT

SCALE AS NOTED REVISION DATE

PB SP/SPR REV-4	6 NOV 2024
PB SP/SPR REV-3	8 OCT 2024
PB SP/SPR REV-2	5 SEP 2024
DD CD/CDD DEV/ 1	26 VIIC 2024

PB SP/SPR REV-1 | 26 AUG 2024 REVIEWED BY MN / YC PQ

ARCHITECTURE PLANNING INTERIOR DESIGN

PETER QUINN ARCHITECTS LLC 259 ELM STREET, SUITE 301 SOMERVILLE, MA 02144 PH 617-354-3989



53 CHESTER ST

53 CHESTER STREET SOMERVILLE, MA 02144

PREPARED FOR

G2 PAR SOMERVILLE LLC

62 BLACK ROCK RD. COHASSET, MA 02025


DRAWING TITLE

LOBBY ENTRANCE, STOREFRONT

SCALE AS NOTED

PB SP/SPR REV-4	6 NOV 2024
PB SP/SPR REV-3	8 OCT 2024
PB SP/SPR REV-2	5 SEP 2024

PB SP/SPR REV-1 26 AUG 2024 REVIEWED BY

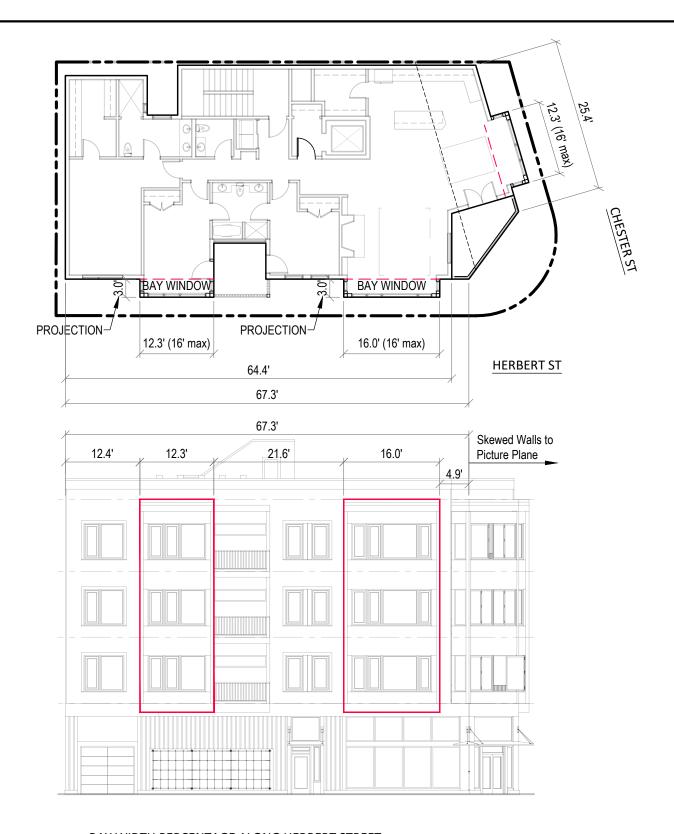

BAY WIDTH PERCENTAGE ALONG HERBERT STREET

CUMULATIVE BAY WIDTH 28.3-ft = 42.1%

WIDTH OF WALL BEHIND 67.3-ft

BAY WINDOWS
SCALE: 1/16" = 1'-0"



BAY WIDTH PERCENTAGE ALONG CHESTER STREET

CUMULATIVE BAY WIDTH 12.3-ft = 48.4%

WIDTH OF WALL BEHIND 25.4-ft

0' 5' 10' 20'



PETER QUINN ARCHI TECTS

ARCHITECTURE PLANNING INTERIOR DESIGN

PETER QUINN ARCHITECTS LLC 259 ELM STREET, SUITE 301 SOMERVILLE, MA 02144 PH 617-354-3989

4L



CONSULTANT

53 CHESTER ST

53 CHESTER STREET SOMERVILLE, MA 02144

PREPARED FOR

G2 PAR SOMERVILLE LLC

62 BLACK ROCK RD. COHASSET, MA 02025

DRAWING TITLE


BAY WINDOWS

SCALE AS NOTED

REVISION	DATE
PB SP/SPR REV-4	6 NOV 2024
PB SP/SPR REV-3	8 OCT 2024
PB SP/SPR REV-2	5 SEP 2024
PB SP/SPR REV-1	26 AUG 2024
PB SP/SPR	18 JAN 2024
DRAWN BY	REVIEWED BY

DRAWN BY REVIEWED BY
MN / YC PQ

Z-7

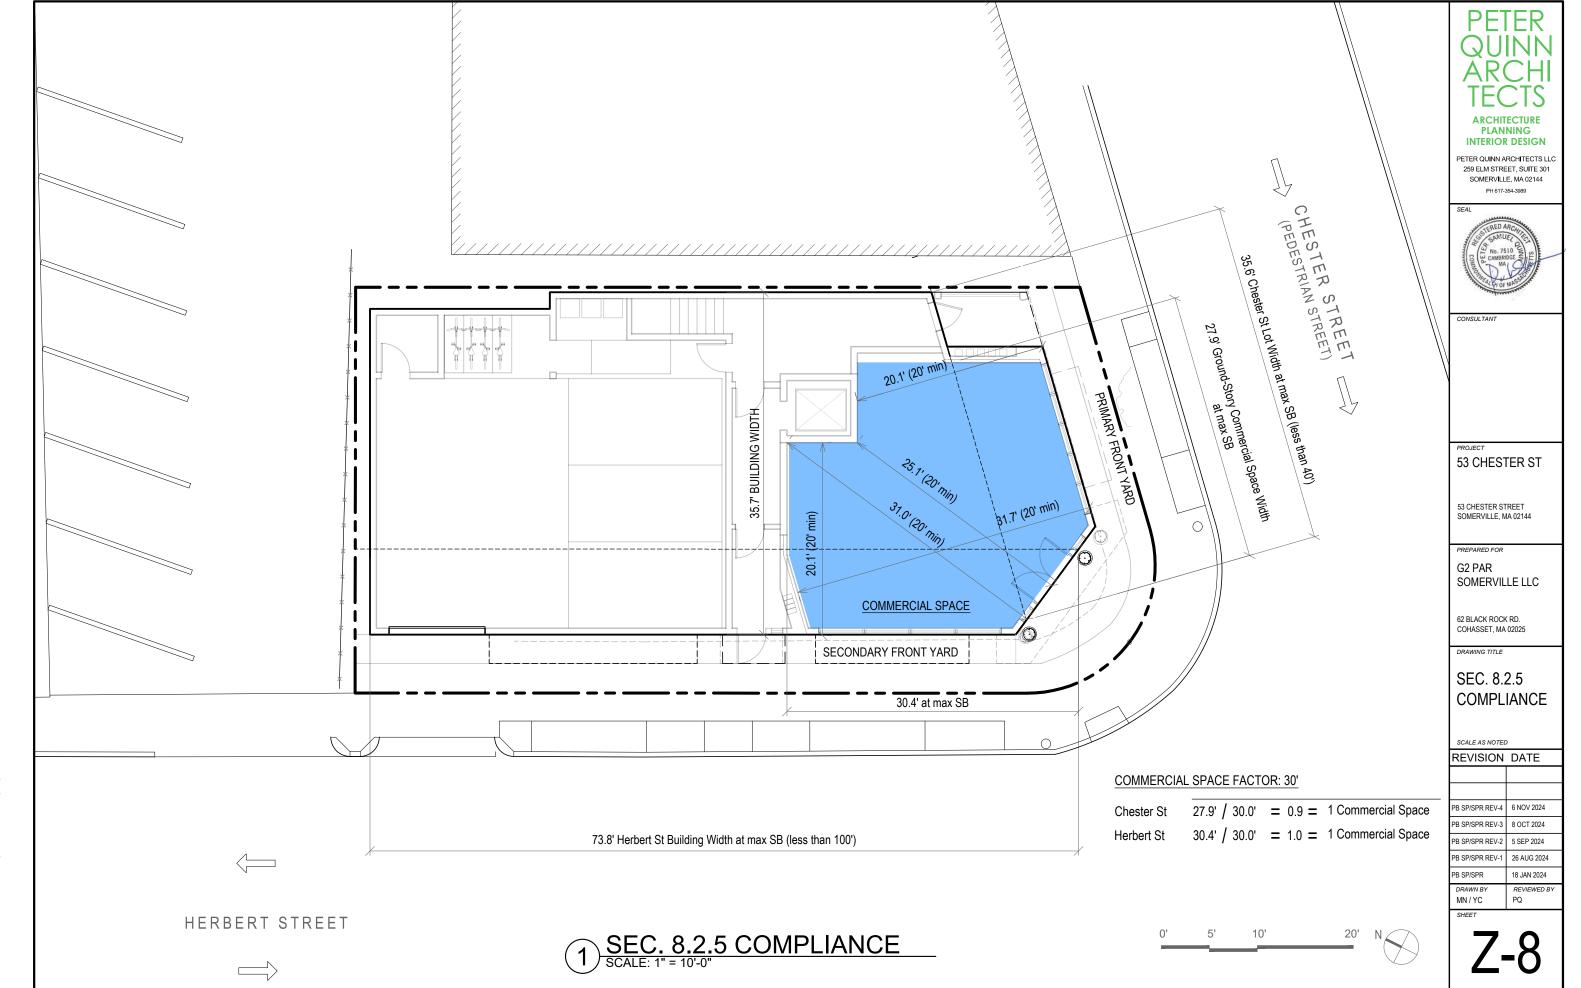

DCADDWGS\Chester-53\02 Schematic Design\Chester 53_Zoning.dwg, 07-Nov-24 6:37:35 PM, DWG To PDF.p

ARCHITECTURE PLANNING INTERIOR DESIGN

PETER QUINN ARCHITECTS LLC 259 ELM STREET, SUITE 301 SOMERVILLE, MA 02144 PH 617-354-3989

SEAL



CONSULTA

53 CHESTER ST

53 CHESTER STREET SOMERVILLE, MA 02144

PREPARED FOR

G2 PAR SOMERVILLE LLC

62 BLACK ROCK RD. COHASSET, MA 02025

DRAWING TO

3D VIEW

SCALE AS NOTED

REVISION DATE

IVE VIOLOIA	DATE

PB SP/SPR REV-4	6 NOV 2024
PB SP/SPR REV-3	8 OCT 2024
PB SP/SPR REV-2	5 SEP 2024
PR SP/SPR REV-1	26 AUG 2024

PB SP/SPR REV-1 26 AUG 2024
PB SP/SPR 18 JAN 2024

DRAWN BY REVIEWED BY

MN / YC

 $\Delta \cap 1$

1 3D VIEW FROM CORNER SCALE: N/A



QUINN ARCHI TECTS

ARCHITECTURE PLANNING INTERIOR DESIGN

PETER QUINN ARCHITECTS LLC 259 ELM STREET, SUITE 301 SOMERVILLE, MA 02144 PH 617-354-3989

SEAL



CONSULTA

53 CHESTER ST

53 CHESTER STREET SOMERVILLE, MA 02144

PREPARED FOR

G2 PAR SOMERVILLE LLC

62 BLACK ROCK RD. COHASSET, MA 02025

DRAWING TITLE

SECOND FLOOR PLAN

SCALE AS NOTED

REVISION	DATE
PB SP/SPR REV-4	6 NOV 2024
PB SP/SPR REV-3	8 OCT 2024
PB SP/SPR REV-2	5 SEP 2024

 PB SP/SPR REV-2
 5 SEP 2024


 PB SP/SPR REV-1
 26 AUG 2024

 PB SP/SPR
 18 JAN 2024

 DRAWN BY
 REVIEWED BY

MN / YC

A-2

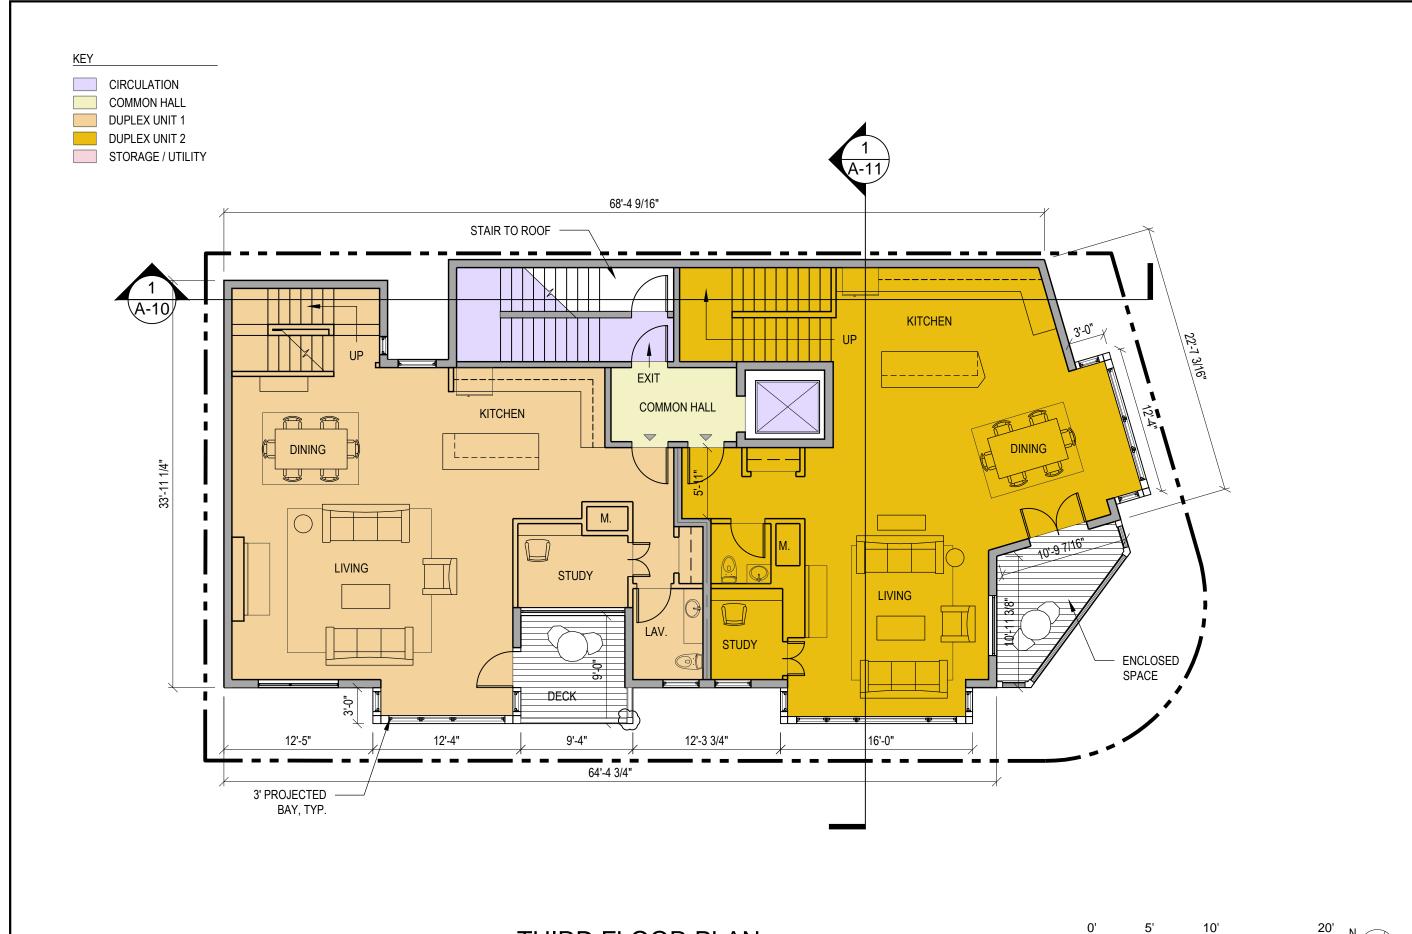

PETER QUINN ARCHITECTS LLC 259 ELM STREET, SUITE 301 SOMERVILLE, MA 02144 PH 617-354-3989

SEAL



CONSULTA

53 CHESTER ST

53 CHESTER STREET SOMERVILLE, MA 02144

PREPARED FOR

G2 PAR SOMERVILLE LLC

62 BLACK ROCK RD. COHASSET, MA 02025

DRAWING TITLE

THIRD FLOOR PLAN

SCALE AS NOTED

REVISION DATE

PB SP/SPR REV-4	6 NOV 2024
PB SP/SPR REV-3	8 OCT 2024

PB SP/SPR REV-3 8 OCT 2024

PB SP/SPR REV-2 5 SEP 2024


PB SP/SPR REV-1 26 AUG 2024

PB SP/SPR 18 JAN 2024

DRAWN BY REVIEWED BY

MN / YC

A-3

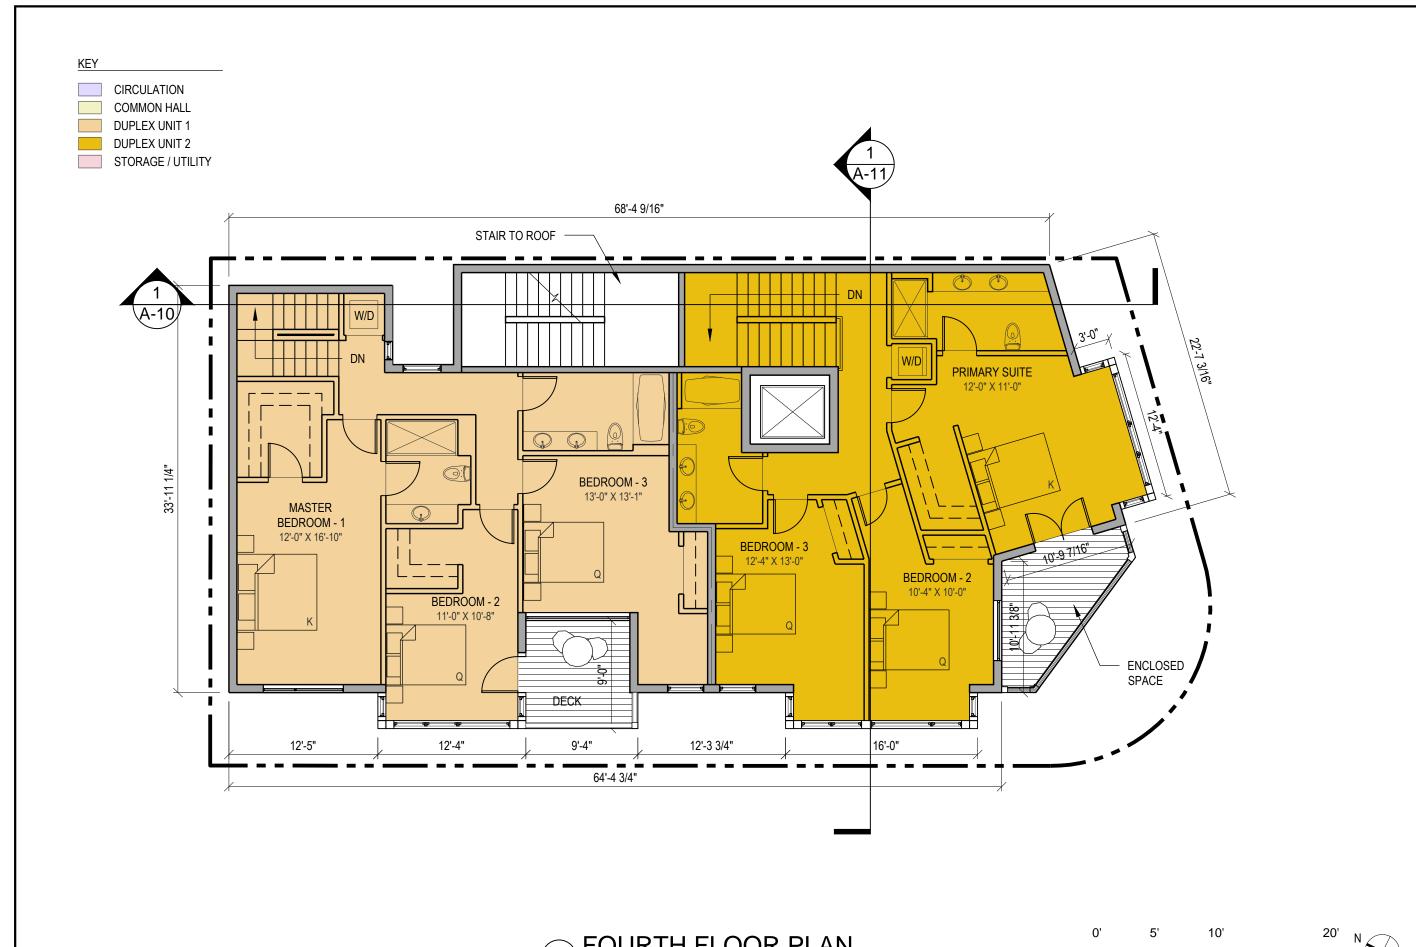

ARCHITECTURE PLANNING INTERIOR DESIGN

PETER QUINN ARCHITECTS LLC 259 ELM STREET, SUITE 301 SOMERVILLE, MA 02144 PH 617-354-3989



53 CHESTER ST

53 CHESTER STREET SOMERVILLE, MA 02144

PREPARED FOR

G2 PAR SOMERVILLE LLC

62 BLACK ROCK RD. COHASSET, MA 02025


DRAWING TITLE

FOURTH FLOOR PLAN

SCALE AS NOTED REVISION DATE

PB SP/SPR REV-4	6 NOV 2024

PB SP/SPR REV-4	6 NOV 2024
PB SP/SPR REV-3	8 OCT 2024
PB SP/SPR REV-2	5 SEP 2024
PB SP/SPR REV-1	26 AUG 2024
PB SP/SPR	18 JAN 2024

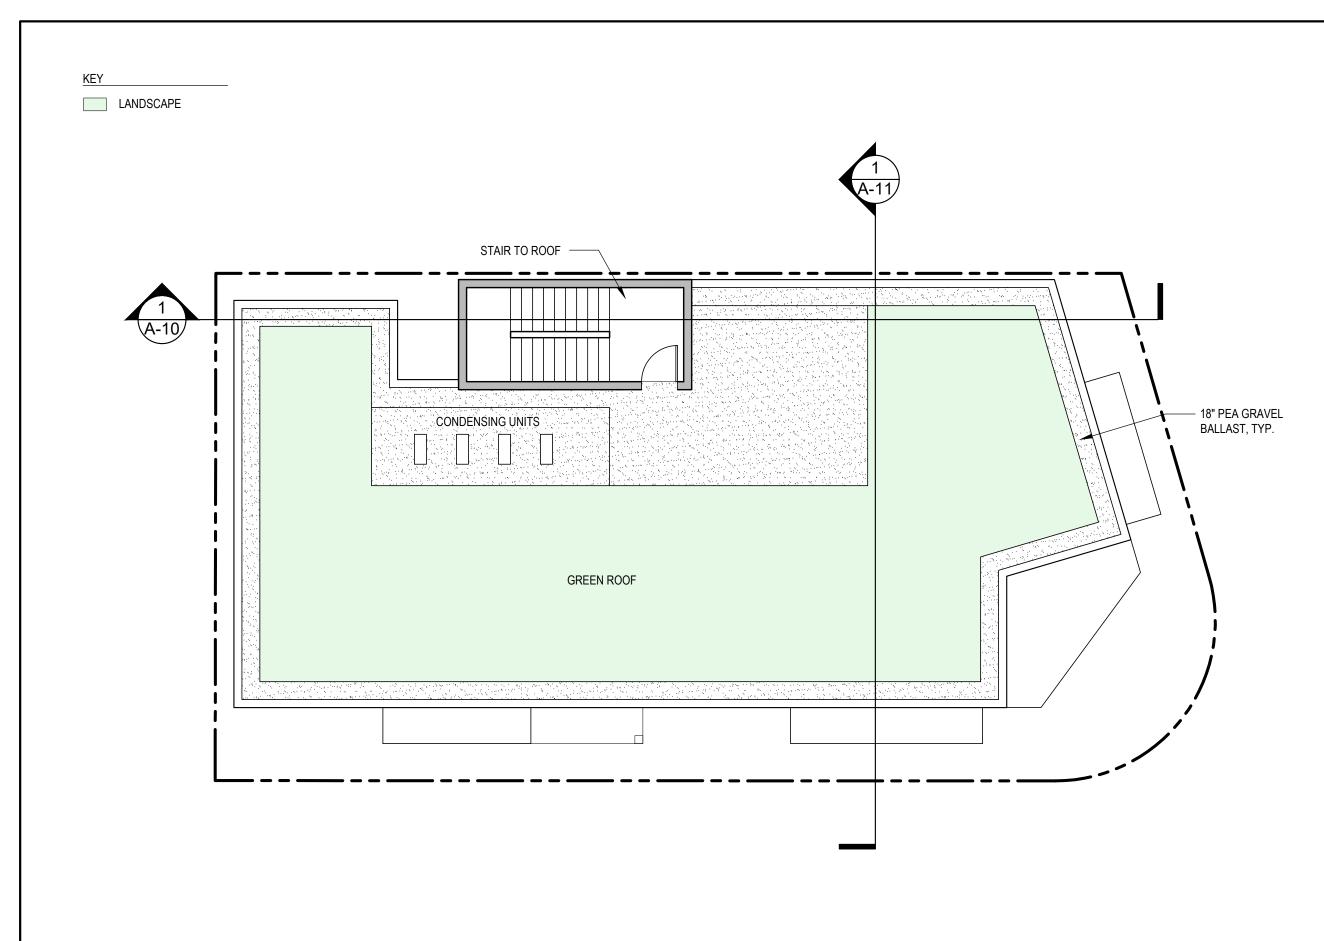

ARCHITECTURE PLANNING INTERIOR DESIGN

PETER QUINN ARCHITECTS LLC 259 ELM STREET, SUITE 301 SOMERVILLE, MA 02144 PH 617-354-3989



53 CHESTER ST

53 CHESTER STREET SOMERVILLE, MA 02144

PREPARED FOR

G2 PAR SOMERVILLE LLC

62 BLACK ROCK RD. COHASSET, MA 02025

DRAWING TITLE

ROOF PLAN

SCALE AS NOTED REVISION DATE

PB SP/SPR REV-4	6 NOV 2024
PB SP/SPR REV-3	8 OCT 2024

PB SP/SPR REV-2 5 SEP 2024 PB SP/SPR REV-1 26 AUG 2024

REVIEWED BY MN / YC

POA -\Chester-53\02 Schematic Design\Chester 53 Elevations.dwg. A6 Herbert. 11/4/2024 2:12:5

3\02 Schematic Design\Chester 53_Elevations.dwg, A8 Right, 11/4/2024 2:15:57 PM

ARCHITECTURE PLANNING INTERIOR DESIGN

PETER QUINN ARCHITECTS LLC 259 ELM STREET, SUITE 301 SOMERVILLE, MA 02144 PH 617-354-3989



53 CHESTER ST

53 CHESTER STREET SOMERVILLE, MA 02144

PREPARED FOR

G2 PAR SOMERVILLE LLC

62 BLACK ROCK RD. COHASSET, MA 02025

DRAWING TITLE

REAR ELEVATION

REVISION DATE	
PB SP/SPR REV-4	6 NOV 2024
PB SP/SPR REV-3	8 OCT 2024
PB SP/SPR REV-2	5 SEP 2024
PB SP/SPR REV-1	26 AUG 2024
PB SP/SPR	18 JAN 2024
DRAWN BY MN / YC	REVIEWED BY PQ

MN / YC

REAR ELEVATION

SCALE: 1/8" = 1'-0"

2 STREETSCAPE ELEVATION - HERBERT ST



STREETSCAPE ELEVATION - CHESTER ST

PLANNING INTERIOR DESIGN PETER QUINN ARCHITECTS LLC 259 ELM STREET, SUITE 301 SOMERVILLE, MA 02144

PH 617-354-3989



53 CHESTER ST

53 CHESTER STREET SOMERVILLE, MA 02144

PREPARED FOR

G2 PAR SOMERVILLE LLC

62 BLACK ROCK RD. COHASSET, MA 02025

DRAWING TITLE


STREETSCAPE ELEVATION

SCALE AS NOTED

REV	ISION	DATE

PB SP/SPR REV-4	6 NOV 2024
PB SP/SPR REV-3	8 OCT 2024
PB SP/SPR REV-2	5 SEP 2024
PB SP/SPR REV-1	26 AUG 2024
PB SP/SPR	18 JAN 2024

REVIEWED BY

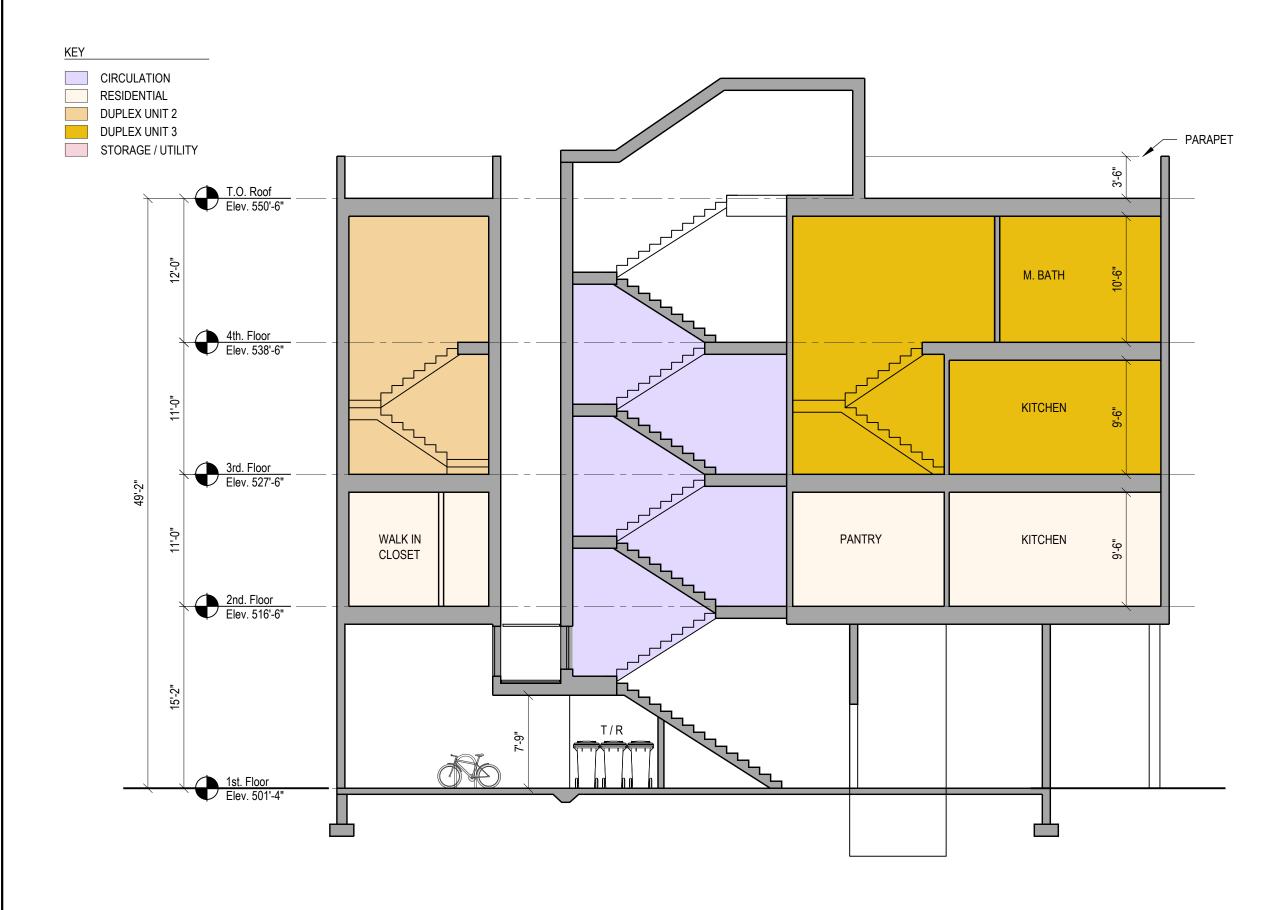

QUINN ARCHI TECTS

ARCHITECTURE PLANNING INTERIOR DESIGN

PETER QUINN ARCHITECTS LLC 259 ELM STREET, SUITE 301 SOMERVILLE, MA 02144 PH 617-354-3989

SEAL



CONSULTAN

53 CHESTER ST

53 CHESTER STREET SOMERVILLE, MA 02144

PREPARED FOR

G2 PAR SOMERVILLE LLC

62 BLACK ROCK RD. COHASSET, MA 02025

DRAWING TITLE

BUILDING SECTION

SCALE AS NOTED

REVISION DATE

KEVIOION BATE	
PB SP/SPR REV-4	6 NOV 2024
PB SP/SPR REV-3	8 OCT 2024
PB SP/SPR REV-2	5 SEP 2024

 PB SP/SPR REV-1
 26 AUG 2024

 PB SP/SPR
 18 JAN 2024

 DRAWN BY YC
 REVIEWED BY PQ


SHEET

20'

10'

A-11

TRANSVERSE SECTION
SCALE: 1/8" = 1'-0"

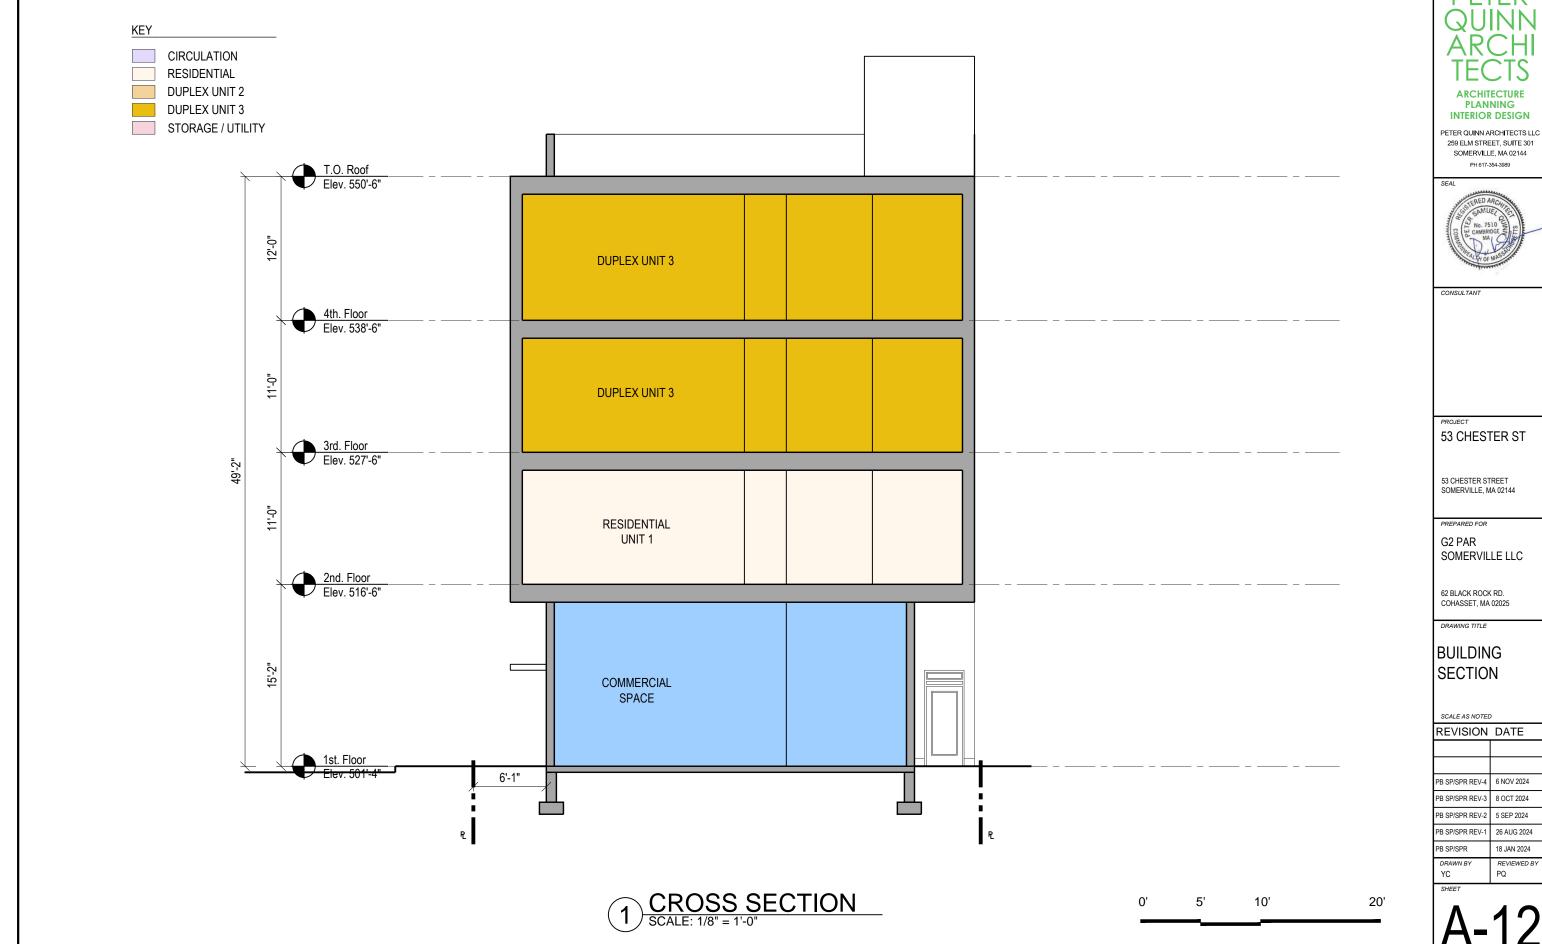



FIBER CEMENT LAP SIDING OR EQUAL

TEXTURE: SMOOTH



MAIN SIDING OF THE BUILDING

STUDY #1-COLOR: AGREEABLE GRAY

STUDY #2-COLOR: NIEBLA AZUL

STUDY #3-COLOR: MORRIS ROOM GRAY



FCB BOARD & BATTEN

SIZE: SINGLE 8"

TEXTURE: SMOOTH

COLOR: PEWTER TANKARD

COLOR: URBANE BRONZE

T & G CEDAR SIDING

DIRECTION: VERTICAL COLOR: WESTEN RED, CLEAR FINISH



MAIN MATERIAL FOR BAYS

METAL BALUSTRADE VERTICAL BALUSTERS



FCB TRIM BOARDS **BORAL TRUEXTERIOR TRIM** COLOR: PAINTED



CORNERS, WINDOWS & DOORS TRIM

METAL SIDING OR EQUAL

ATAS INTERNATIONAL METAL SIDING MULTI-PURPOSE - MPW INTERLOCK PANELS COLOR: DOVE GREY





Dove Grey (13) REAR AND SIDE FACADES FACING ABUTTERS

WINDOW

ANDERSON CASEMENT AND FIXED 400 SERIES OR EQUAL DOUBLE PANE GLAZING



VINE TRELLIS CABLE TRELLIS



PLANNING INTERIOR DESIGN

PETER QUINN ARCHITECTS LLC 259 ELM STREET, SUITE 301 SOMERVILLE, MA 02144 PH 617-354-3989



53 CHESTER ST

53 CHESTER STREET SOMERVILLE, MA 02144

PREPARED FOR

G2 PAR SOMERVILLE LLC

62 BLACK ROCK RD. COHASSET, MA 02025


DRAWING TITLE


MATERIALS BOARD

SCALE AS NOTED

REVISION DATE	
PB SP/SPR REV-4	6 NOV 2024
PB SP/SPR REV-3	8 OCT 2024
PB SP/SPR REV-2	5 SEP 2024

PB SP/SPR REV-1 26 AUG 2024 PB SP/SPR 18 JAN 2024 REVIEWED BY MN / YC

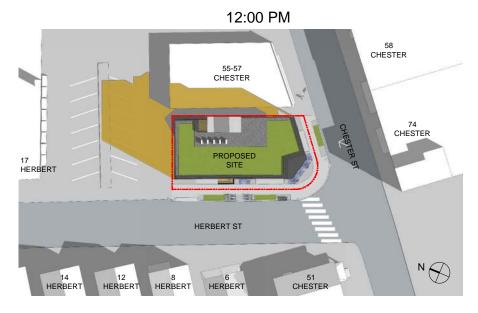

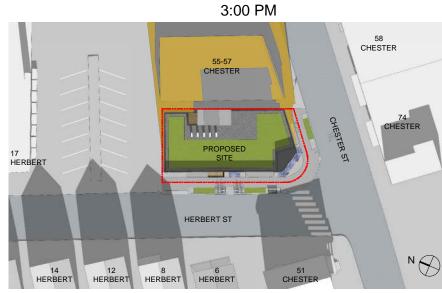

PROPOSED

9:00 AM 58 CHESTER CHESTER 74 CHESTER EXISTING HERBERT HERBERT ST N **EXISTING**



3:00 PM CHESTER CHESTER 74 CHESTER HERBERT HERBERT ST 6 HERBERT

EXISTING

ADDITIONAL SHADOW

SPRING / FALL EQUINOX

PLANNING

INTERIOR DESIGN

PETER QUINN ARCHITECTS LLC 259 ELM STREET, SUITE 301 SOMERVILLE, MA 02144 PH 617-354-3989



53 CHESTER ST

53 CHESTER STREET SOMERVILLE, MA 02144

PREPARED FOR

SOMERVILLE LLC

62 BLACK ROCK RD. COHASSET, MA 02025

SHADOW STUDY - SPRING/ FALL EQUINOX

SCALE AS NOTED REVISION DATE


REVIOION BATE	
PB SP/SPR REV-4	6 NOV 2024
PB SP/SPR REV-3	8 OCT 2024
PB SP/SPR REV-2	5 SEP 2024
PB SP/SPR REV-1	26 AUG 2024
PB SP/SPR	18 JAN 2024


REVIEWED BY

MARCH 21 SEPTEMBER 21






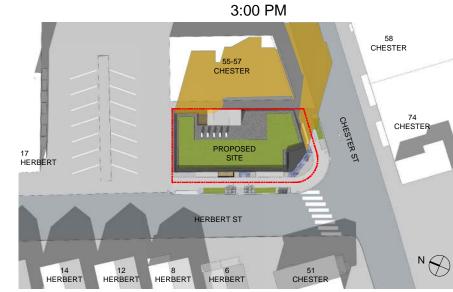

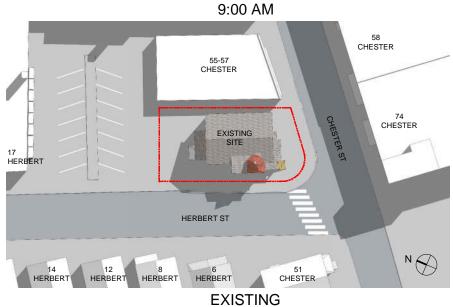



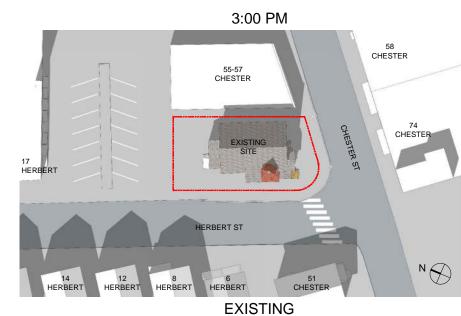

EXISTING

ADDITIONAL SHADOW

SUMMER JUNE 21

PLANNING INTERIOR DESIGN

PETER QUINN ARCHITECTS LLC 259 ELM STREET, SUITE 301 SOMERVILLE, MA 02144 PH 617-354-3989



53 CHESTER ST

53 CHESTER STREET SOMERVILLE, MA 02144

PREPARED FOR

G2 PAR SOMERVILLE LLC

62 BLACK ROCK RD. COHASSET, MA 02025

DRAWING TITLE

SHADOW STUDY

- SUMMER SCALE AS NOTED

REVISION	DATE
PB SP/SPR REV-4	6 NOV 2024
PB SP/SPR REV-3	8 OCT 2024
PB SP/SPR REV-2	5 SEP 2024
PB SP/SPR REV-1	26 AUG 2024

REVIEWED BY PQ



3:00 PM

QUINN ARCHI TECTS

ARCHITECTURE PLANNING INTERIOR DESIGN

PETER QUINN ARCHITECTS LLC 259 ELM STREET, SUITE 301 SOMERVILLE, MA 02144 PH 617-354-3989

SEAL



CONSULTANT

53 CHESTER ST

53 CHESTER STREET SOMERVILLE, MA 02144

PREPARED FOR

58 CHESTER

> 74 CHESTER

G2 PAR SOMERVILLE LLC

62 BLACK ROCK RD. COHASSET, MA 02025

DRAWING TITLE

SHADOW STUDY - WINTER

SCALE AS NOTED

	REVISION DATE	
F		
Г		
Р	B SP/SPR REV-4	6 NOV 2024
Р	B SP/SPR REV-3	8 OCT 2024
Р	B SP/SPR REV-2	5 SEP 2024
Р	B SP/SPR REV-1	26 AUG 2024
	D CD/CDD	10 1441 2024

10

SH-3

REVIEWED BY

PROPOSED

9:00 AM

58
CHESTER

CHESTER

FINANCE SITE

17
HERBERT

HERBERT

18
16
151
CHESTER

N

CHESTER

CHESTER

N

CHESTER

N

CHESTER

CHESTER

N

CHESTER

CHESTER

CHESTER

N

CHESTER

CHE

EXISTING

12:00 PM

58
CHESTER

55-57
CHESTER

74
CHESTER

17
HERBERT

HERBE

EXISTING

17
HERBERT

HERBERT

14
12
8
6
6
51
HERBERT

CHESTER

EXISTING

ADDITIONAL SHADOW

WINTER
DECEMBER 21