


1 EAST ELEVATION
SCALE: 1/8" = 1'-0"
0 4 8 16 24

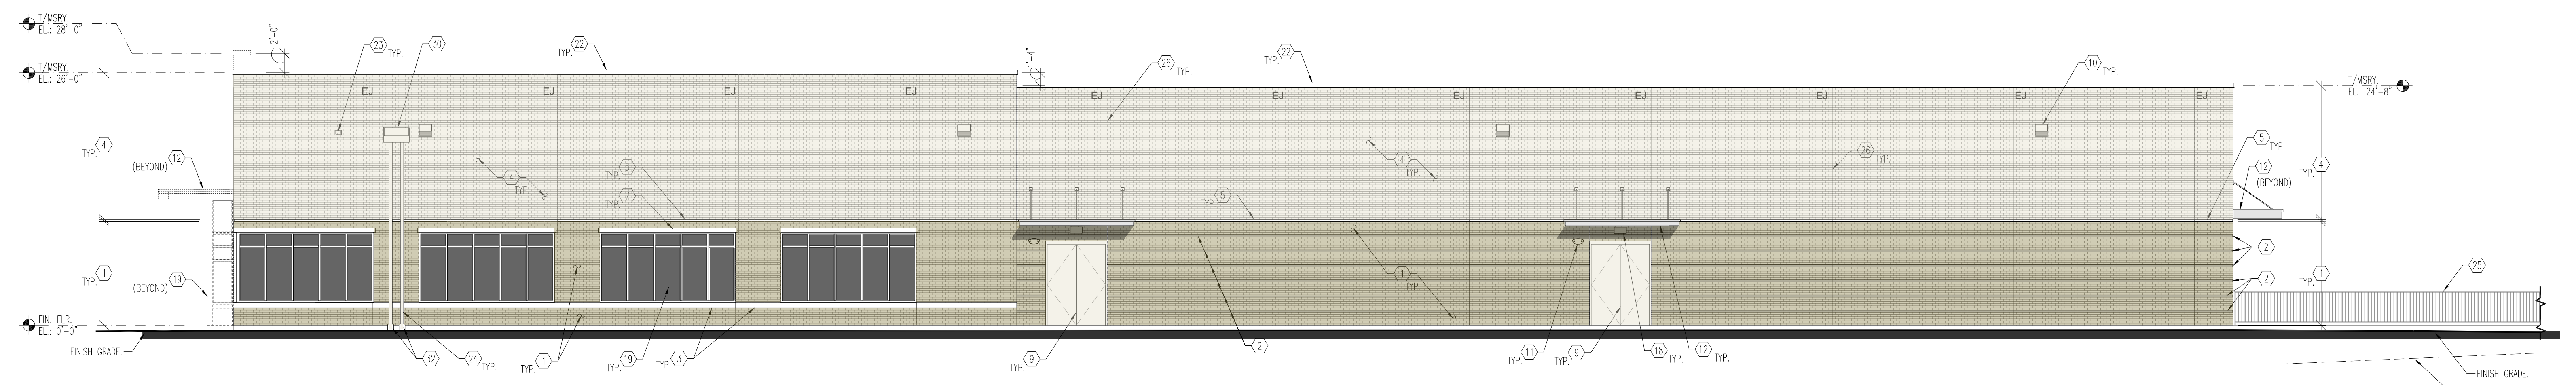

2 NORTH ELEVATION
SCALE: 1/8" = 1'-0"
0 4 8 16 24

SHEET NOTES

1. COORDINATE ALL OPENING SIZES WITH APPLICABLE TRADES AND FINAL APPROVED SUBMITTALS PRIOR TO CONSTRUCTING NEW WALLS.

KEY NOTES

- 1. FACE BRICK VENEER - MODULAR BRICK 3 5/8" x 2 1/4" x 7 5/8" IN RUNNING BOND - COLOR No. 2.
- 2. FACE BRICK VENEER - MODULAR BRICK 3 5/8" x 2 1/4" x 7 5/8" IN RUNNING BOND - COLOR No. 2 - ACCENT COURSE, RECESSED 1/2"
- 3. CONT. CAST STONE SILL AND BELT COURSE TYPE "A"
- 4. FACE BRICK VENEER - MODULAR BRICK 3 5/8" x 2 1/4" x 7 5/8" IN RUNNING BOND - COLOR No. 1
- 5. CONT. CAST STONE BELT COURSE TYPE "B"
- 6. FACE BRICK VENEER ACCENT PATTERN - MODULAR BRICK 3 5/8" x 2 1/4" x 7 5/8" - COLOR No. 3.
- 7. CAST STONE HEADER COURSE, TYPE "A"
- 8. PREFINISHED METAL SCUPPER WITH MTL. CONDUCTOR HEAD.
- 9. INSULATED H.M. DOOR (PTD.)
- 10. WALL PACK LIGHT FIXTURE
- 11. SELF CONTAINED WALL-MOUNTED EXTERIOR EMERGENCY LIGHT FIXTURE. - TYP. AT EACH EXTERIOR DOOR.
- 12. PREFIN. ALUM. CANOPY
- 13. CANOPY DOWNSPOUT
- 14. PREFABRICATED GALV. STEEL RAIN HOOD W/ INTEGRAL GUTTER, 3'-0" x 14'-0" LONG. - TYP. AT EACH MASONRY OPENING FOR NEW AND FUTURE DUCTWORK PORTALS
- 15. OUTLINE OF MECH. EQUIPMENT
- 16. MECH. DUCTWORK OPENING
- 17. PREFINISHED METAL INFILL PANELS
- 18. WALL-MOUNTED EXTERIOR LIGHT
- 19. ALUM. STOREFRONT GLAZING SYSTEM
- 20. ALUM. STOREFRONT DOOR
- 21. INSULATED SECTIONAL OVERHEAD DOOR
- 22. PREFINISHED ALUM. COPING SYSTEM
- 23. OVERFLOW SCUPPER
- 24. PREFIN. MTL. DOWNSPOUT LEADER
- 25. GALV. STL. PIPE GUARDRAIL W/ BALLUSTERS AT 4' O.C. - PTD.
- 26. VERT. MASONRY EXPANSION JOINT. (EJ)
- 27. DUCT PENETRATION THROUGH EXTERIOR MASONRY CAVITY WALL.
- 28. PREFIN. METAL LOUVER
- 29. PREFIN. METAL SILL FLASHING
- 30. PREFIN. METAL SCUPPER AND CONDUCTOR HEAD WITH (2) 4" x 6" DOWNSPOUTS
- 31. PIPING PORTAL
- 32. DOWNSPOUT BOOT
- 33. DUCK LEVELER
- 34. DUCK BUMPER GUARDS
- 35. EXPOSED CONC. FOUNDATION WALL.

REV	DESCRIPTION	DATE
1	-	XXXXXXXX
2	-	XXXXXXXX
3	-	XXXXXXXX
4	-	XXXXXXXX
5	-	XXXXXXXX
6	-	XXXXXXXX
7	-	XXXXXXXX
8	-	XXXXXXXX
9	-	XXXXXXXX

NETWORK COMPLIANCE SUBMITTALS	DATE
PRELIMINARY SUBMISSION	10/1/21
30% SUBMISSION	XXXXXXXX
60% SUBMISSION	12/20/21
90% SUBMISSION	XXXXXXXX
100% SUBMISSION	XXXXXXXX
CONSTRUCTION DESIGN SUBMISSION	XXXXXXXX
RECORD SET (AS-BUILTS)	XXXXXXXX

PROJECT NO: 2137	STAMP
CAD DWG FILE:	
DESIGNED BY: PM	
DRAWN BY: JT	
CHECKED BY: PM	
COPYRIGHT:	

SHEET TITLE
BUILDING ELEVATIONS

SHEET NUMBER
A210