





STOUT HERITAGE PARKWAY PLAINFIELD, INDIANA HAVEN HOMES

08.30.19 | Revised PUD SUBMITTAL

SHEET TITLE

**ELEVATIONS BLDG B2** 

A202 SHEET NO.

BUILDING HEIGHT TRUSS BEARING 109'-8 5/8" FIN. LEVEL 2 100'-0" FIN. LEVEL 1



SCALE: 1" = 20'



04: SIDE ELEVATION

SCALE: 1" = 20'

RATIO OF MATERIALS:

FIBER CEMENT PANELS = 39%

FIBER CEMENT LAP SIDING = 26%

RATIO OF MATERIALS:

RATIO OF MATERIALS: BRICK

FIBER CEMENT PANELS = 50% FIBER CEMENT LAP SIDING = 24%

129'-8"

**EXTERIOR ELEVATION KEY NOTES** 

BRICK VENEER
VINYL WINDOWS - SEE WINDOW SCHEDULE FIBER CEMENT PANELS, WITH METAL REVEAL 7. FIBER CEMENT HORIZONTAL LAP SIDING

PROVIDE 1X4 FIBER CEMENT TRIM BOARDS AT ALL CORNERS WHERE LAP SIDING OCCURS. PROVIDE METAL REVEAL TRIM PIECES AT ALL

ASPHALT DIMENSIONAL SHINGLES JOINTS OF FIBER CEMENT PANEL.

OUTSIDE CORNERS OF FIBER CEMENT PANELS.

FIBER CEMENT TRIM

GENERAL NOTE:

RATIO OF MATERIALS:

FIBER CEMENT PANELS = 39% FIBER CEMENT LAP SIDING = 34%


03: SIDE ELEVATION

SCALE: 1" = 20'

FIBER CEMENT PANELS = 40%

FIBER CEMENT LAP SIDING = 26%

BRICK

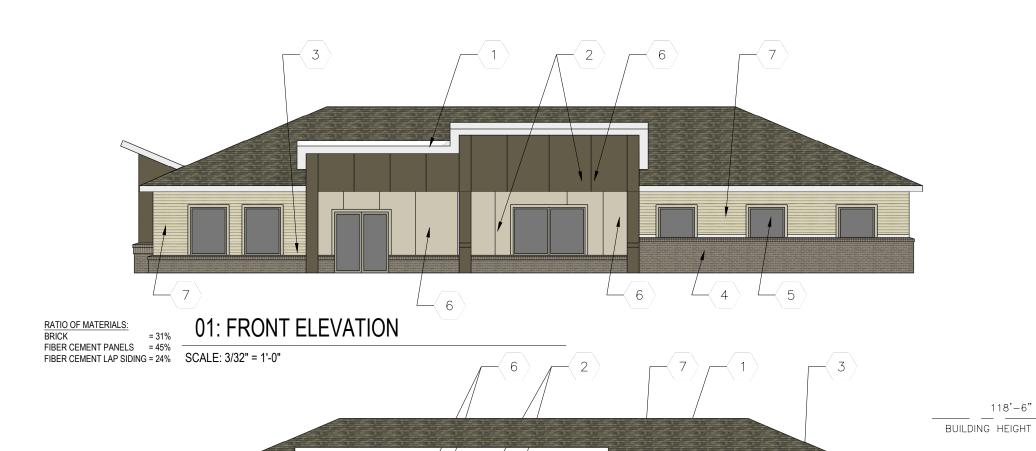

## **EXTERIOR ELEVATION KEY NOTES**

- ASPHALT DIMENSIONAL SHINGLES
   JOINTS OF FIBER CEMENT PANEL.
   FIBER CEMENT TRIM
   BRICK VENEER

- VINYL WINDOWS SEE WINDOW SCHEDULE
   FIBER CEMENT PANELS, WITH METAL REVEAL
   FIBER CEMENT HORIZONTAL LAP SIDING

### GENERAL NOTE:

PROVIDE 1X4 FIBER CEMENT TRIM BOARDS AT ALL CORNERS WHERE LAP SIDING OCCURS. PROVIDE METAL REVEAL TRIM PIECES AT ALL OUTSIDE CORNERS OF FIBER CEMENT PANELS.

### RATIO OF MATERIALS:

FIBER CEMENT PANELS = 39%

FIBER CEMENT LAP SIDING = 26%

# HAVEN HOMES

STOUT HERITAGE PARKWAY PLAINFIELD, INDIANA

08.30.19 | Revised PUD SUBMITTAL

MERIC

**ELEVATIONS** BLDG B3

A203

# 02: REAR ELEVATION

FIBER CEMENT PANELS = 36% FIBER CEMENT LAP SIDING = 22%

RATIO OF MATERIALS:



FIBER CEMENT LAP SIDING = 27%

FIBER CEMENT PANELS = 39%

04: SIDE ELEVATION

SCALE: 3/32" = 1'-0"

FIBER CEMENT PANELS = 39% FIBER CEMENT LAP SIDING = 26%

L 5



109'-9 7/8" TRUSS BEARING

100'-0" FIN. LEVEL 1

03: SIDE ELEVATION (MAIN ENTRY)

SCALE: 3/32" = 1'-0"