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Date	Issue
03-28-25	Issued for Bid-Permit

Drawn By: MCG

Project No.: 25061.10

SPORTING GOODS **STORE # 222**

DICK'S
MONADNOCK MARKETPLACE
42 ASH BROOK ROAD
KEENE, NH 03431




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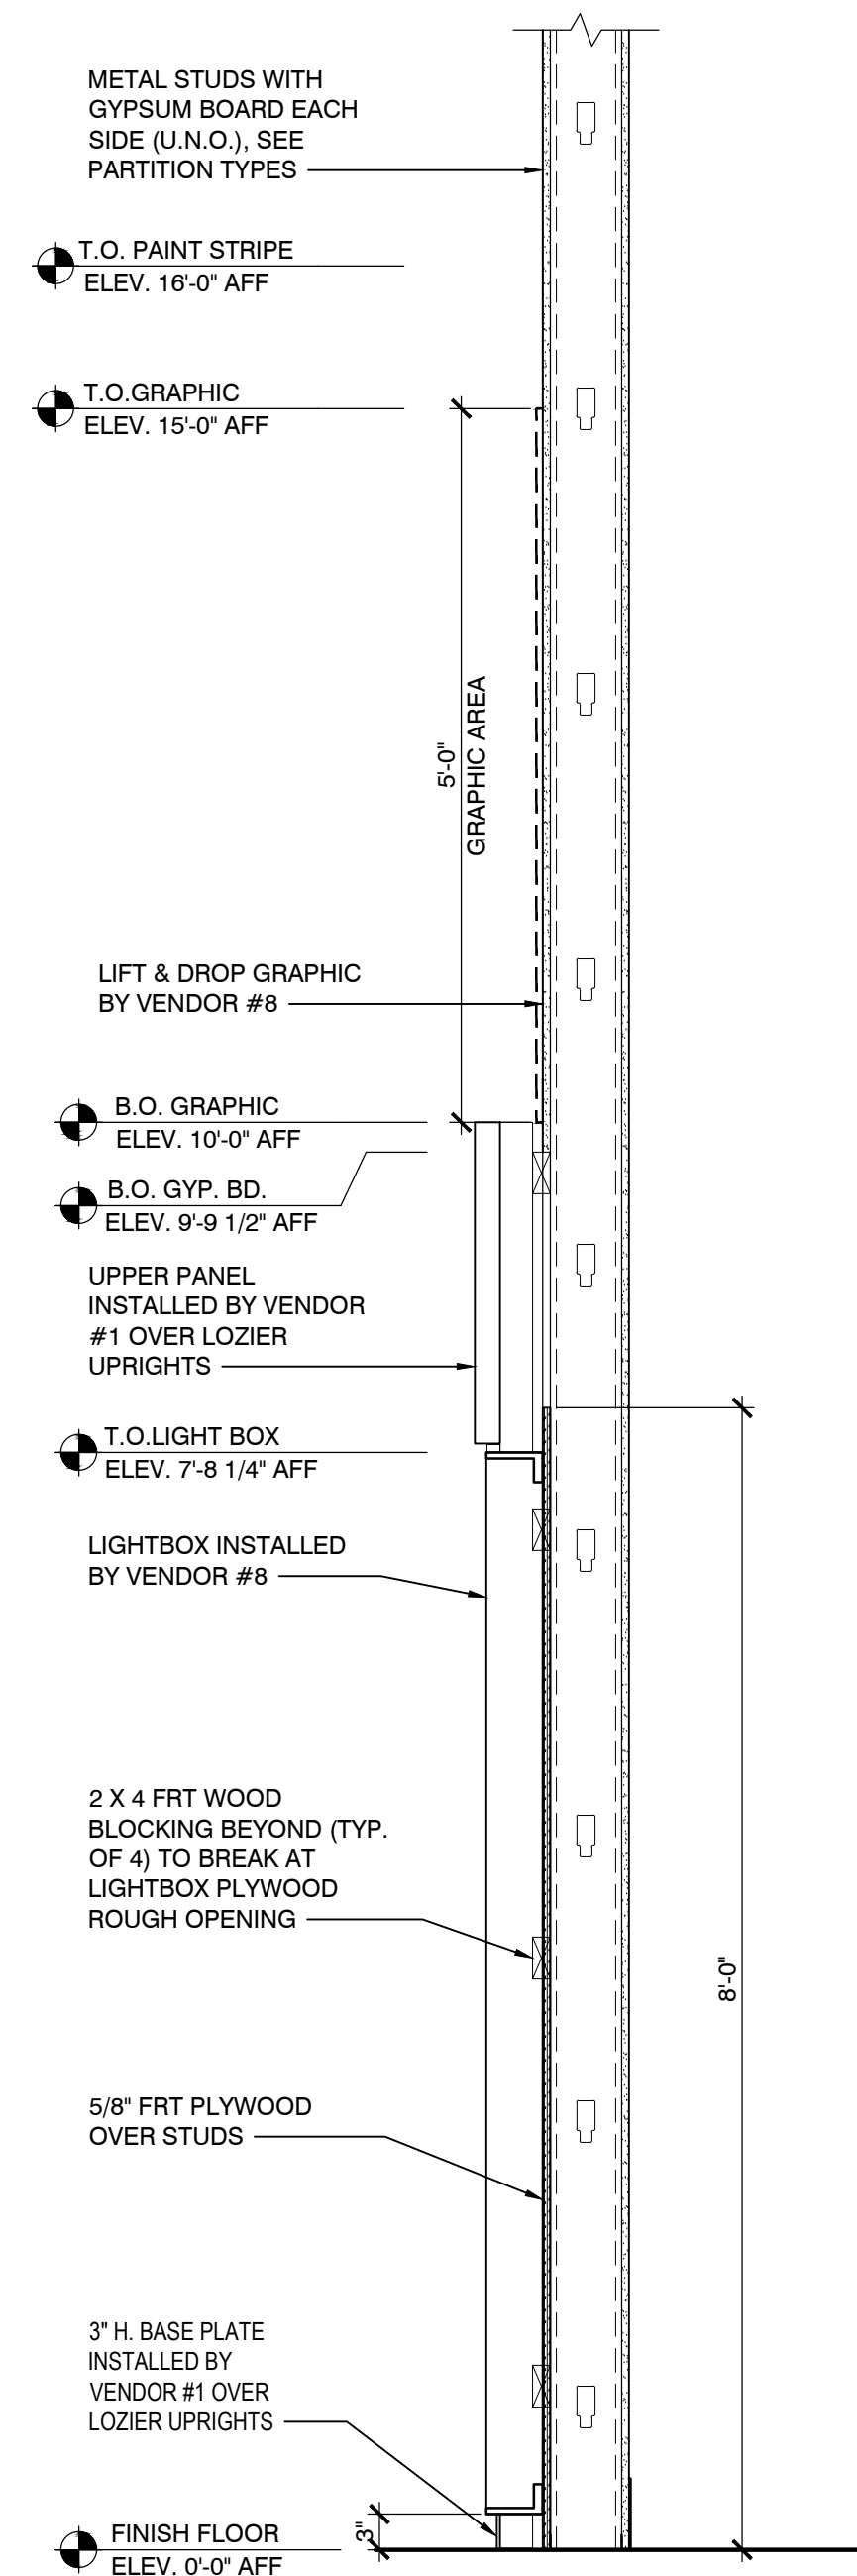
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FLOOR AND BLOCKING DETAILS

A1.0a




LIGHTBOX BLOCKING DETAIL

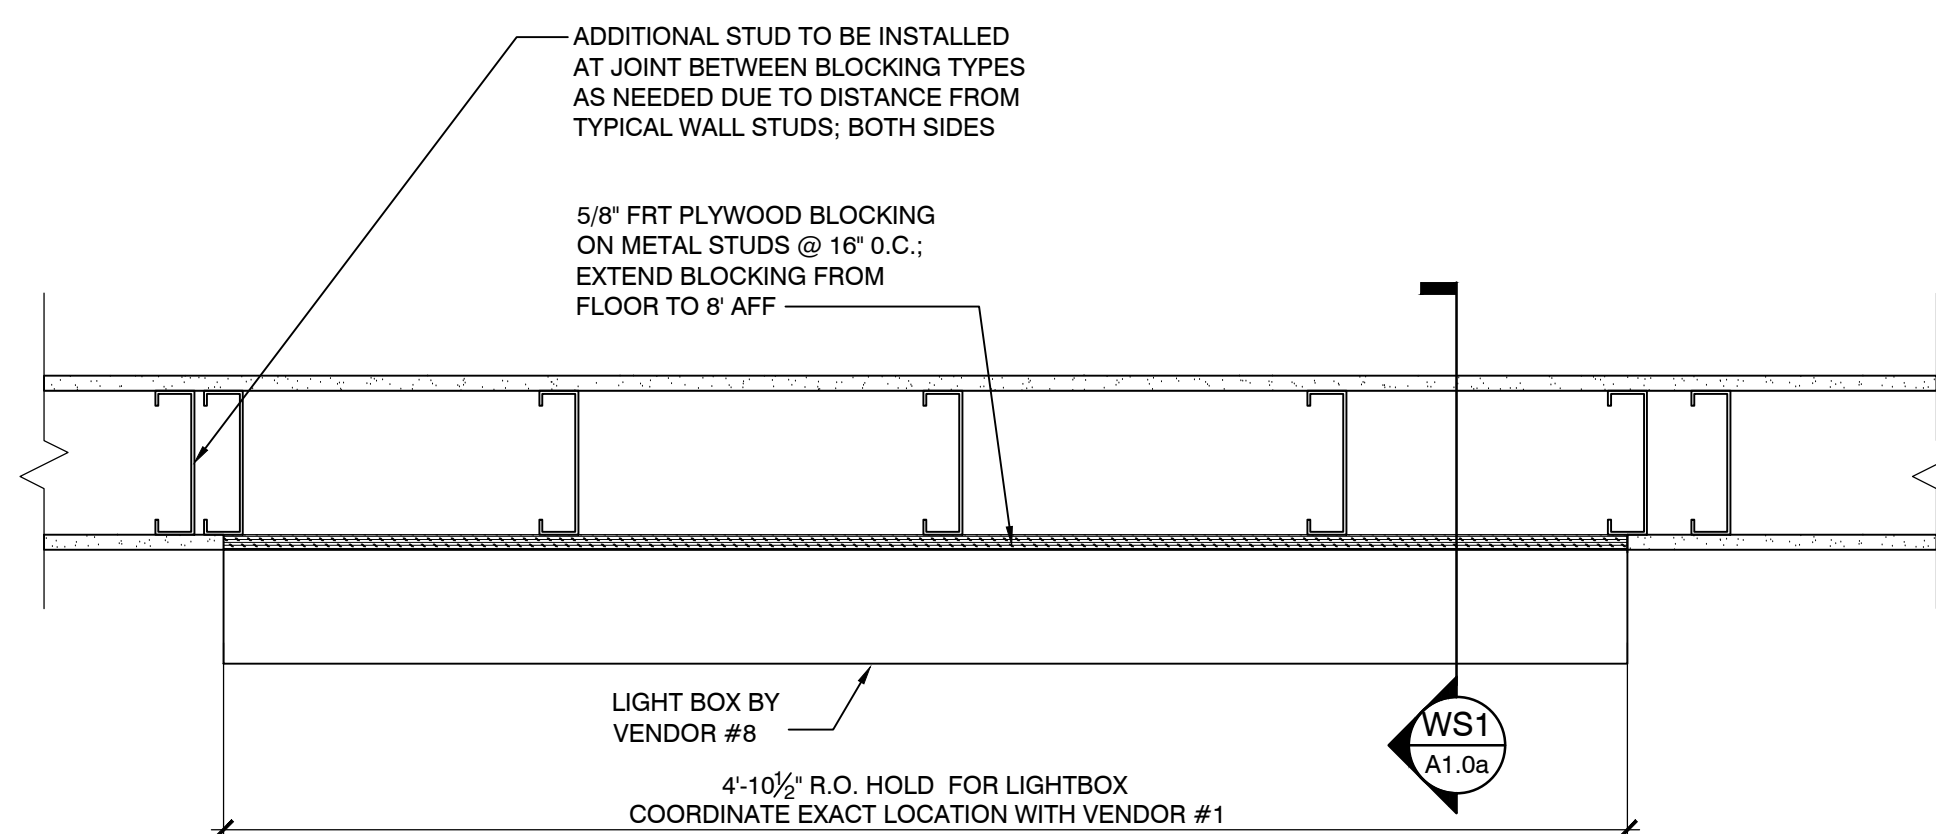

WALL SECTION DETAIL



SCALE
3/4" = 1' - 0"

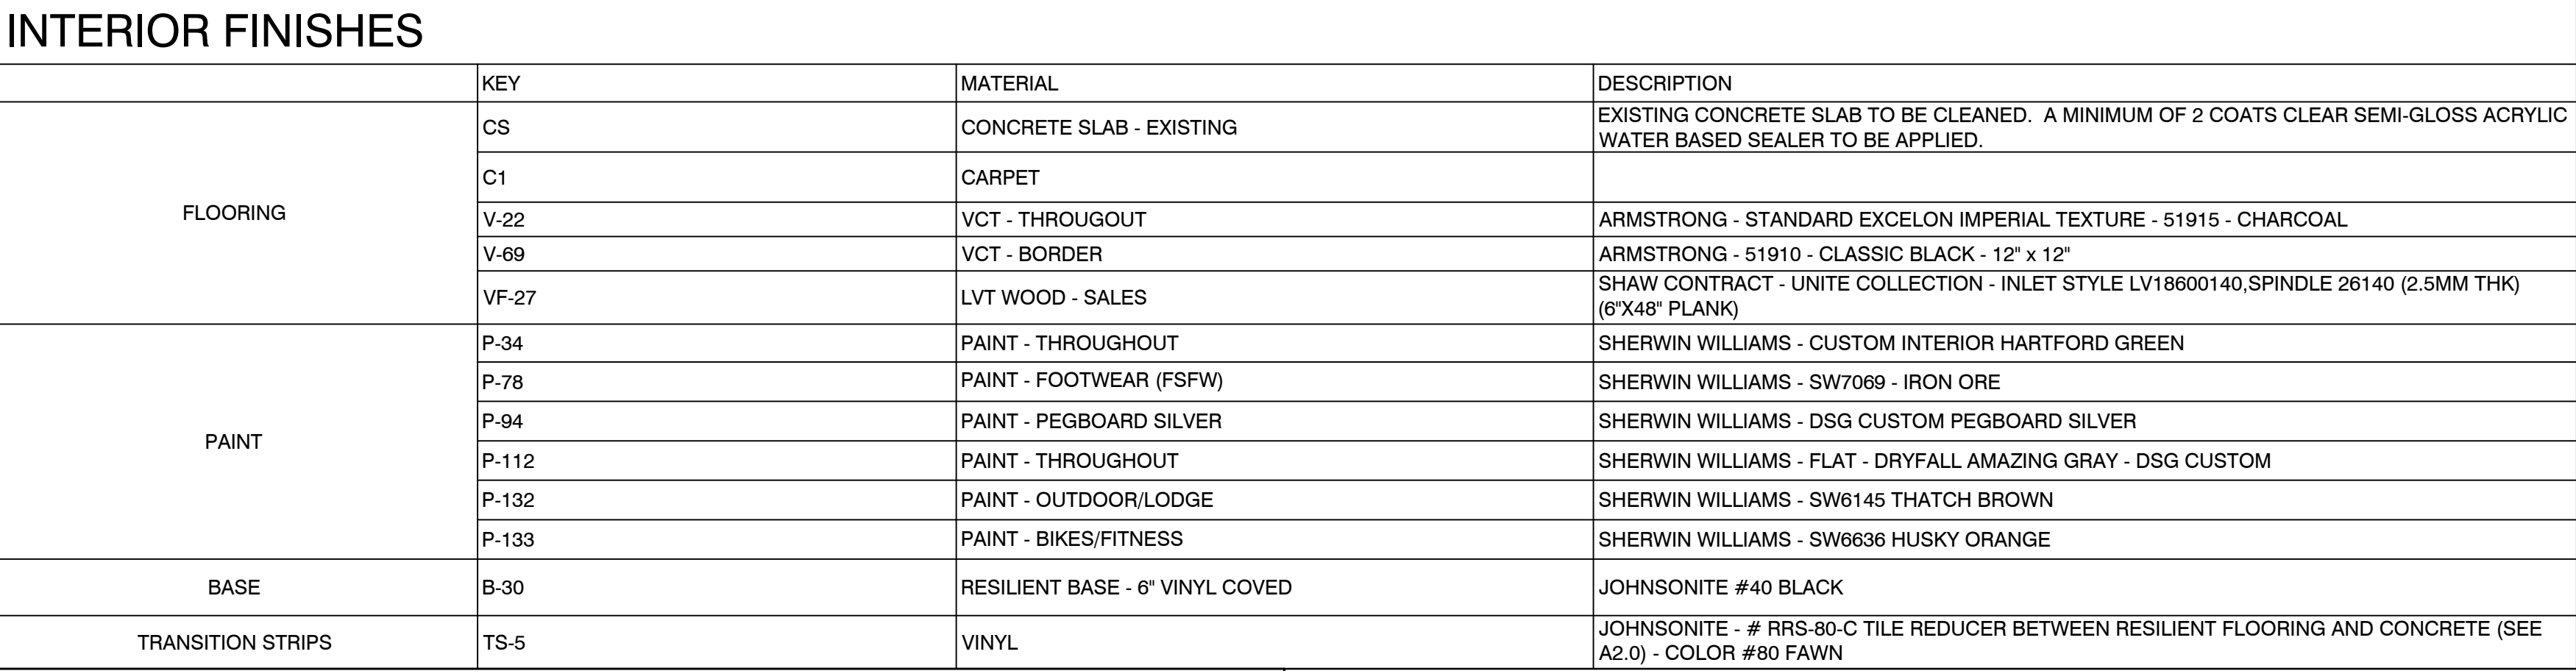

NOTES

1. AS AN ALTERNATE FOR PLASTIC LAMINATES, THE GENERAL CONTRACTOR MAY PROVIDE THERMOFUSED MELAMINE PANEL AS MFRD BY VENDOR #1. ALL PANEL COLORS MUST MATCH THOSE OF THE PLASTIC LAMINATE COLORS LISTED IN FINISH SCHEDULE. ALL PLASTIC LAMINATES AND MELAMINE FINISHES ARE MATTE (UNLESS OTHERWISE NOTED)
2. SEE DETAILS OF TRANSITION STRIPS ON THIS SHEET.
3. TOUCH-UP PAINT AT ALL EXPOSED CEILING AREAS TO MATCH EXIST. IN A FLAT FINISH. ALL EXPOSED NEW DUCTWORK, WIRING, CABLES, ELECTRICAL BOXES, ETC. IN THESE AREAS PAINTED TO MATCH.
4. ALL EDGES OF ALL TRIM BOARDS AT EDGES OF SLATWALL THROUGHOUT STORE ARE TO BE PAINTED BLACK. ALL OTHERS TO MATCH FINISH ON FACE OF TRIM BOARDS.
5. INSTALLATION OF SLATWALL TO ADHERE TO MANUFACTURERS RECOMMENDATIONS AND MAINTENANCE SPECIFICATIONS.
6. NO COLOR OR MATERIAL SELECTIONS (INCLUDING FLOORING, CARPETING, PAINT, PLASTIC LAMINATE, METAL FINISHES, ETC.) ARE TO BE SUBSTITUTED WITHOUT PRIOR WRITTEN APPROVAL OF DICK'S.
7. REFER TO SPECIFICATIONS FOR PAINT FINISHES OF ALL MATERIALS AND SURFACES.
8. PAINT ALL EXIST. WALL LOUVERS TO MATCH ADJACENT WALL FINISHES.
9. PREPARE EXISTING CONCRETE SLABS FOR INSTALLATION OF NEW WOOD, RESILIENT TILE, CARPET AND EXPOSED CONCRETE FLOORS. GRIND OFF ALL HIGH SPOTS, Holes AND CRACKS WITH CEMENT-BASED, POLYMER MODIFIED, SELF LEVELING PRODUCT THAT CAN BE APPLIED IN THICKNESSES FROM 1/8" AND THAT CAN BE FEATHERED AT EDGES TO MATCH ADJACENT FLOOR ELEVATIONS. COMPRESSIVE STRENGTH NOT LESS THAN 4000 PSI.
10. ALL TRIM TOUCH-UP TO MILLWORK IS BY GENERAL CONTRACTOR.
11. REFER TO THE A12 SHEETS FOR EXTENT OF BASE B-30.
12. G.C. TO PAINT ALL EXPOSED SALES FLOOR CONDUIT, INCLUDING DROPS FOR BA & CCTV. CONDUIT PAINT COLOR TO MATCH ADJACENT SURFACE WALL, CEILING, COLUMN, ETC.) DROPS SUSPENDED FROM CEILING ON SALES FLOOR AWAY FROM A VERTICAL SURFACE SHALL BE PAINTED TO MATCH CEILING.
13. PROVIDE 4" HIGH 3/4" PLYWOOD WAINSCOT IN STOCK ROOM AROUND PERIMETER WHERE THERE IS NO SHELVING OR RACKING ON WALLS. REFER TO A11.0 FUTURE PLAN FOR RACKING LOCATIONS.


NOTE: REFER TO SPECIFICATION MANUAL FOR ALL PROTOTYPICAL HARDWARE SETS NOT SHOWN.

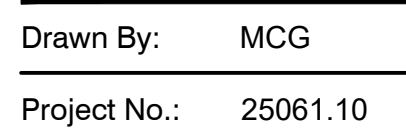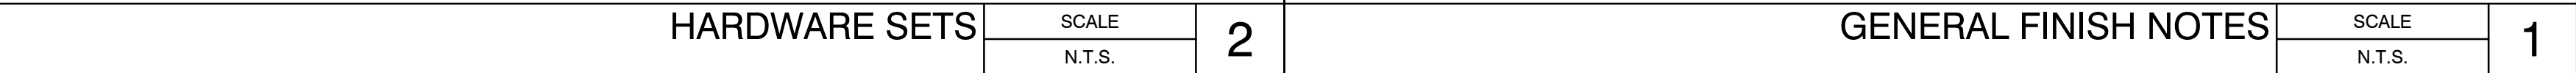

- EXISTING PENDANT HID HI-BAY LIGHT FIXTURE
- RELOCATED PENDANT HID HI-BAY LIGHT FIXTURE (REFER TO ELECTRICAL) MOUNTED TO MATCH EXISTING
- EXISTING TRACK LIGHTS TO REMAIN, REFER TO ELECTRICAL
- RELOCATED TRACK AND TRACK LIGHT HEADS; MOUNT BOTTOM TO MATCH EXISTING (REFER TO ELECTRICAL)
- SURFACE MOUNTED EXIT SIGN (REFER TO ELECTRICAL)
- 4'-0" LED LINEAR FIXTURE, PENDANT MOUNTED U.N.O. (REFER TO ELECTRICAL)

SYMBOL LEGEND


SCALE
NO SCALE

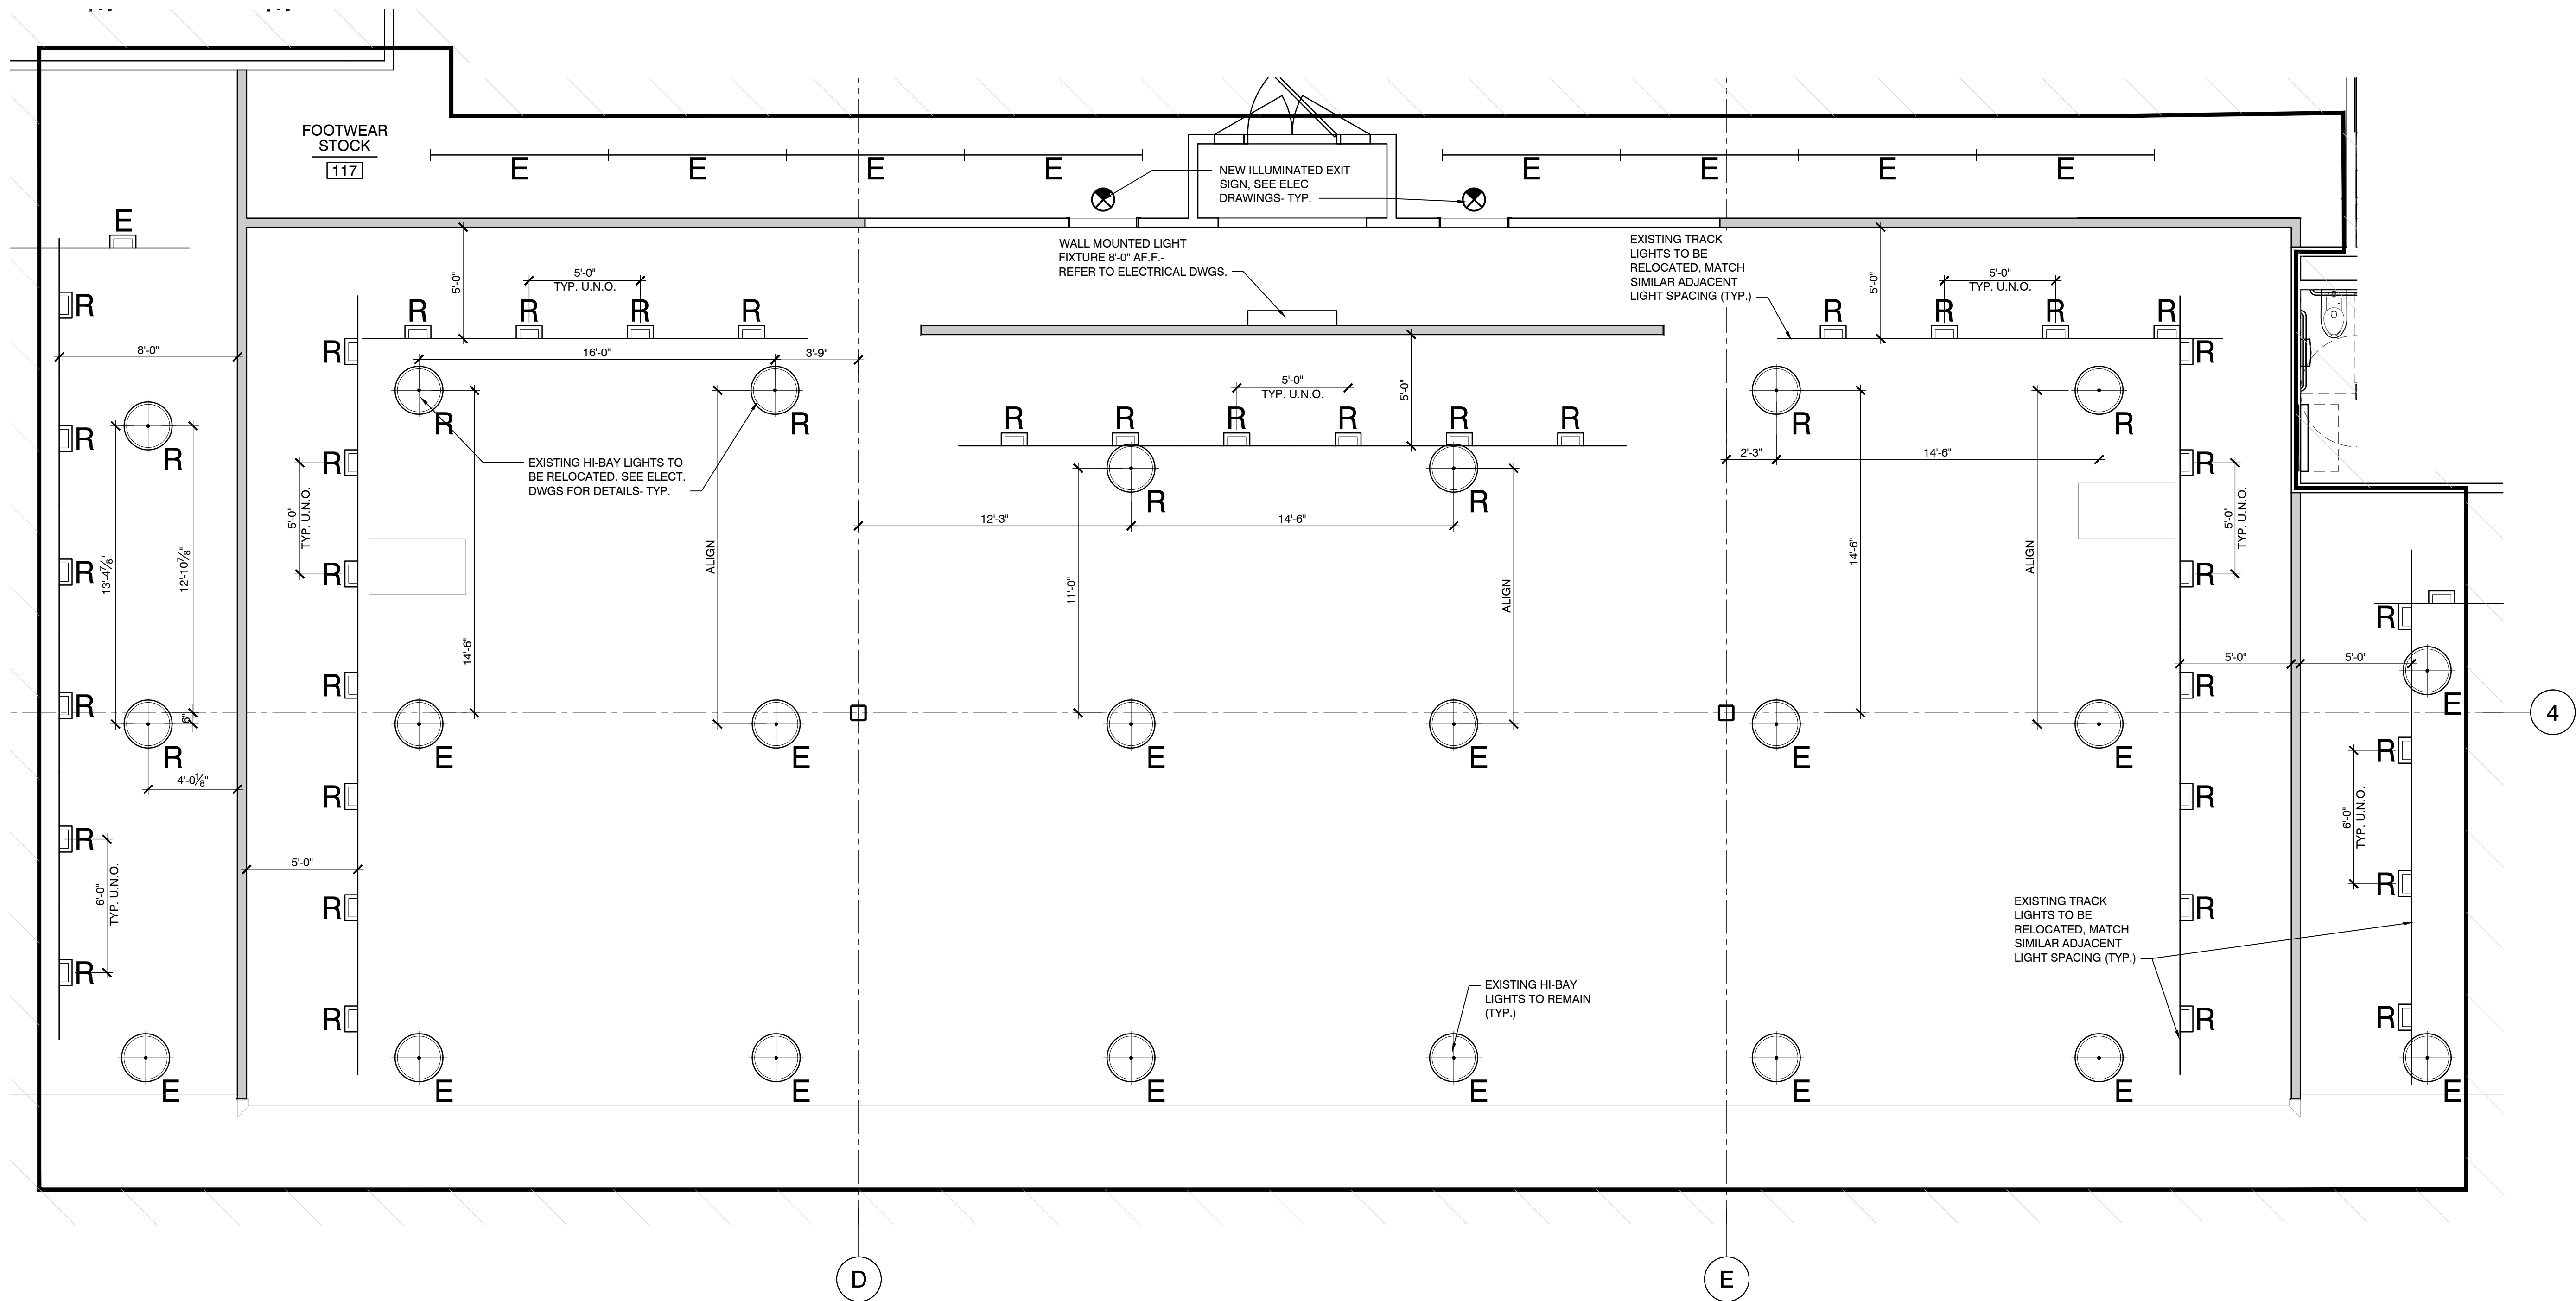

NOTE:
G.C. TO COORDINATE NUMBER OF EXISTING TRACK LIGHT HEADS TO BE RELOCATED IN FIELD. COORDINATE NEW WORK WITH VENDOR #18.

NOTE:
G.C. TO COORDINATE NEW WORK WITH VENDOR #18 TO REFURBISH OR REPLACE ANY DAMAGED, DISCOLORED, OR BROKEN LIGHT FIXTURES, LENSES, BALLASTS, ETC. AND ANY RE-LAMPING REQUIREMENTS

LEGEND
APPROXIMATE AREA OF NEW WORK
NO WORK IN THIS AREA

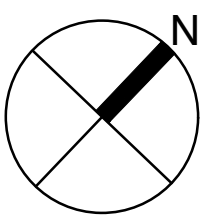

ENLARGED REFLECTED CEILING PLAN
FOOTWEAR

SCALE
1/4" = 1' - 0"

RCP1

Drawn By: MCG
Project No.: 25061.10

DICK'S SPORTING GOODS STORE # 222
MONADNOCK MARKETPLACE
42 ASH BROOK ROAD
KEENE, NH 03431

**With exception of the National Account Vendors that DSG is purchasing directly from as noted on the vendor list, DSG is purchasing all other goods and services from National Account Vendors. The National Account Vendors are required to coordinate, schedule and supervise all National Account Vendors as well as their subcontractors. The Tenant (Dick's Sporting Goods) has no scope of work and/or responsibility shown in these plans and/or specifications. *

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REFLECTED
CEILING PLAN
A3.0

FIXTURE NOTES


ALL FIXTURING SHOWN TO BE PURCHASED BY G.C. FROM VENDOR #1 AND VENDOR #1 TO INSTALL (UNLESS NOTED OTHERWISE.)

ALL TRIM SHOWN AGAINST SLATWALL IS TO BE PURCHASED AS PART OF THE VENDOR 1 PACKAGE.

INSTALLATION OF FINISH FLOORING MUST BE COMPLETE BEFORE PERMANENT FIXTURES AND CASEWORK ARE INSTALLED (THIS INCLUDES PORTAL WALLS). THE INTENTION IS THAT FINISH FLOORING RUN UNDER FIXTURES AND CASEWORK, AND TIGHT TO WALLS. FAILURE TO DO SO WILL RESULT IN THE GC AND/OR FLOORING VENDOR TO RETURN TO ADHERE TO THIS REQUIREMENT AT NO COST TO TENANT.

GENERAL NOTES AND SYMBOL LEGEND

SCALE	-
1/4" = 1' - 0"	

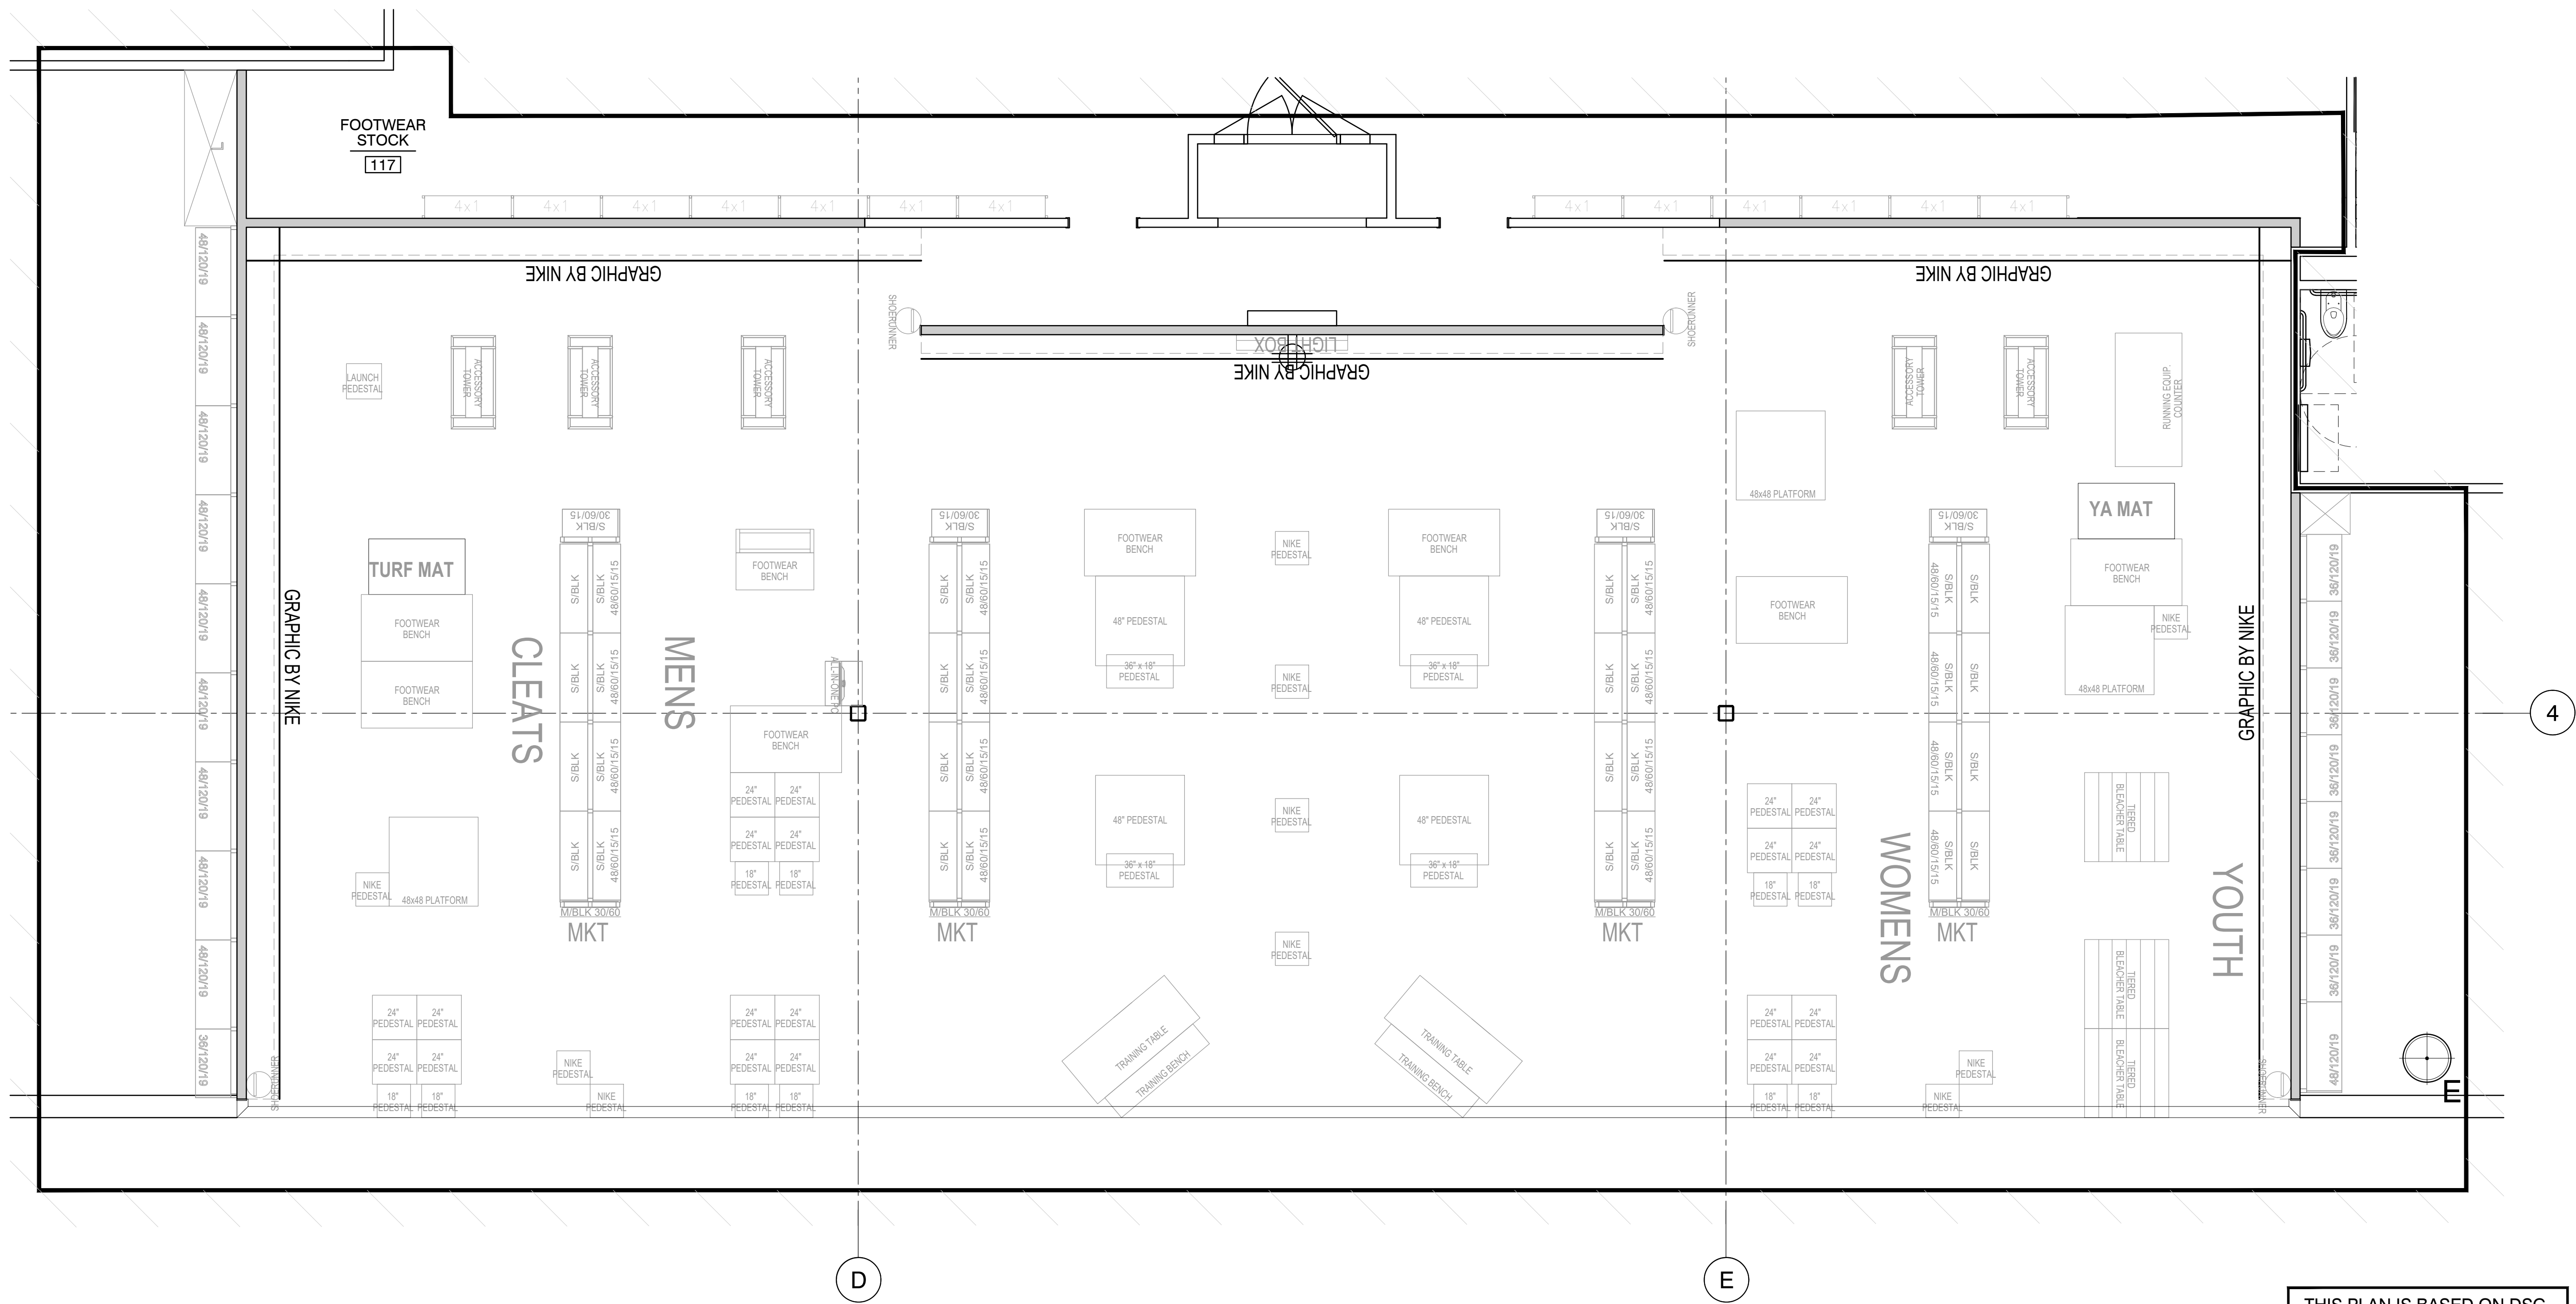

THIS PLAN IS BASED ON DSG
FIXTURE PLAN DATED 02-24-25

LEGEND	APPROXIMATE AREA OF NEW WORK
	NO WORK IN THIS AREA

ENLARGED FLOOR PLAN
FOOTWEAR

SCALE
1/4" = 1' - 0"

FP1

Drawn By: MCG
Project No.: 25061.10




DICK'S SPORTING GOODS STORE # 222
MONADNOCK MARKETPLACE
42 ASH BROOK ROAD
KEENE, NH 03431

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FIXTURE PLAN
A11.0

INTERIOR FINISH SCHEDULE	
(P-2)	PAINT - RED BAY (DSG) RED
(P-5)	PAINT - FLAT WHITE
(P-12)	PAINT - LOUISBURG GREEN
(P-78)	PAINT - IRON ORE
(P-169)	PAINT - TRICORN BLACK (SATIN)
(B-30)	6" VINYL COVE - BLACK



FINISH SCHEDULE
SCALE
1/4" = 1' - 0"

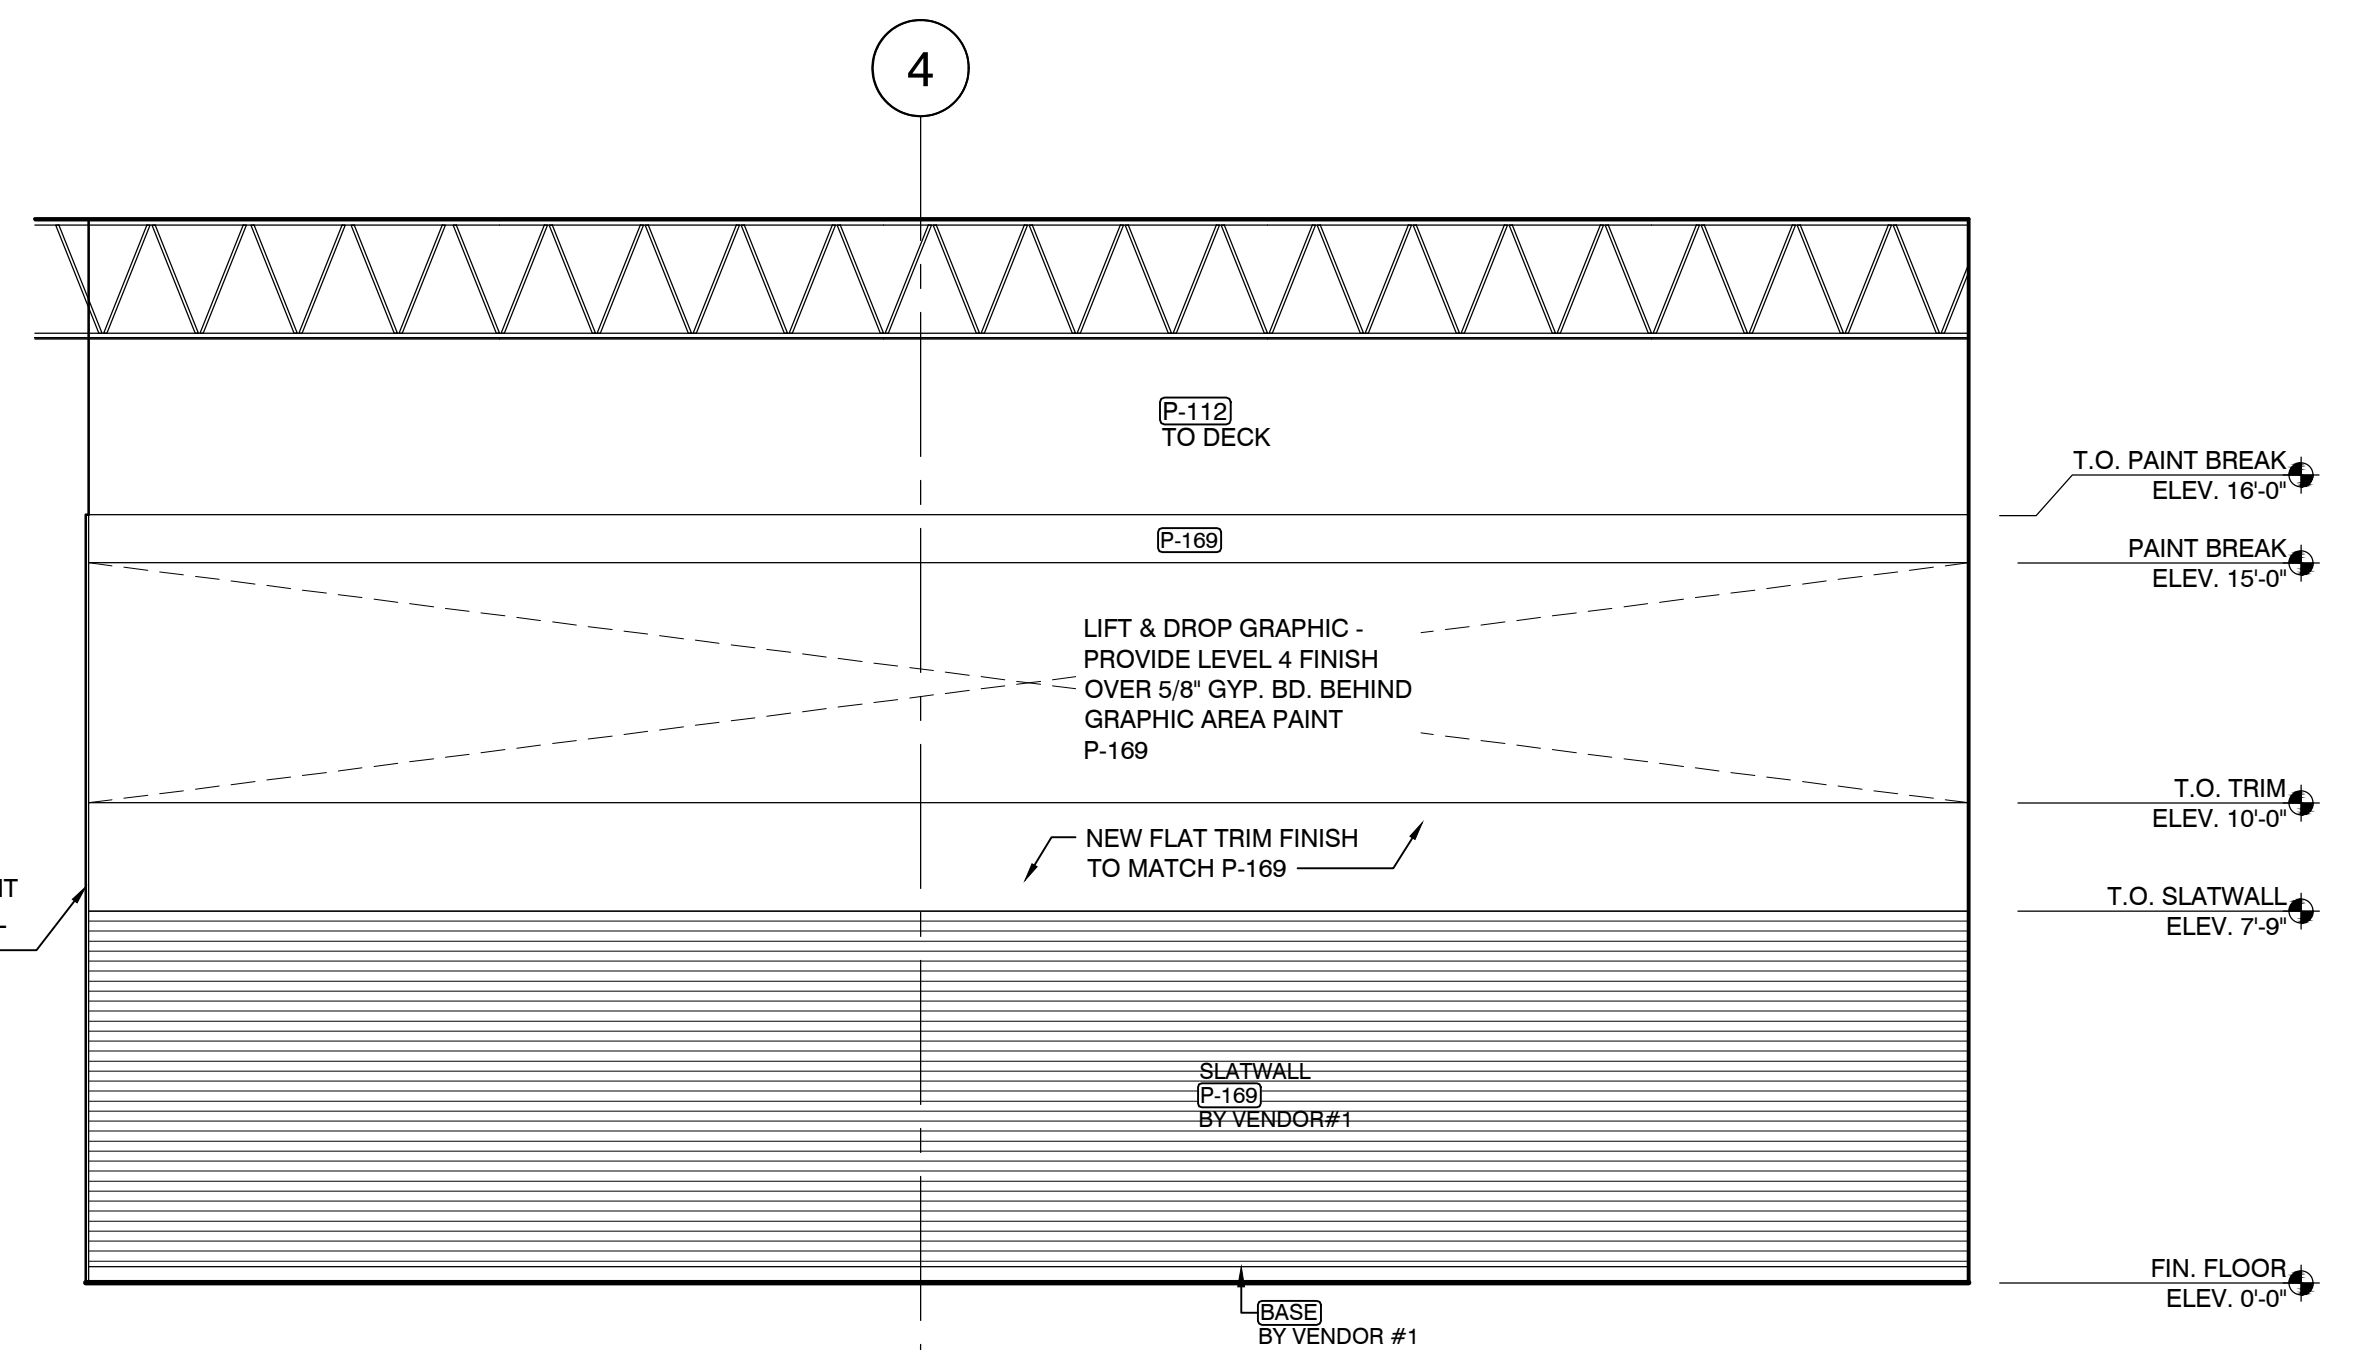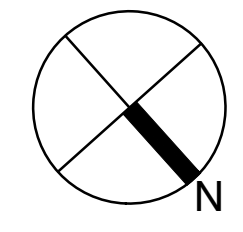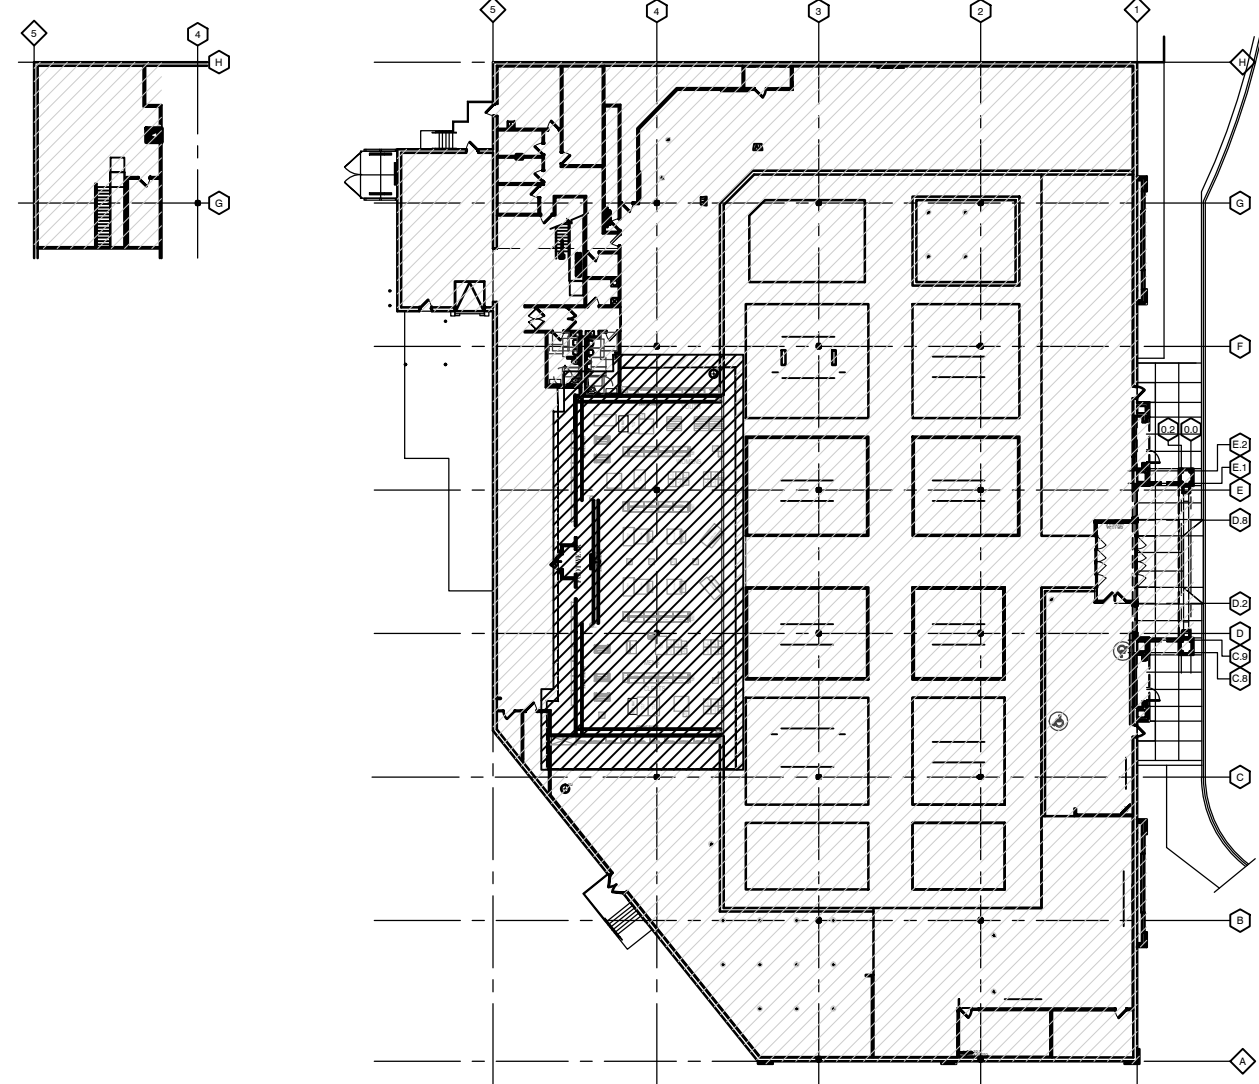FS


KEY PLAN
SCALE
NTS

KP1

INTERIOR ELEVATION
FOOTWEAR

SCALE
1/4" = 1' - 0"


E5

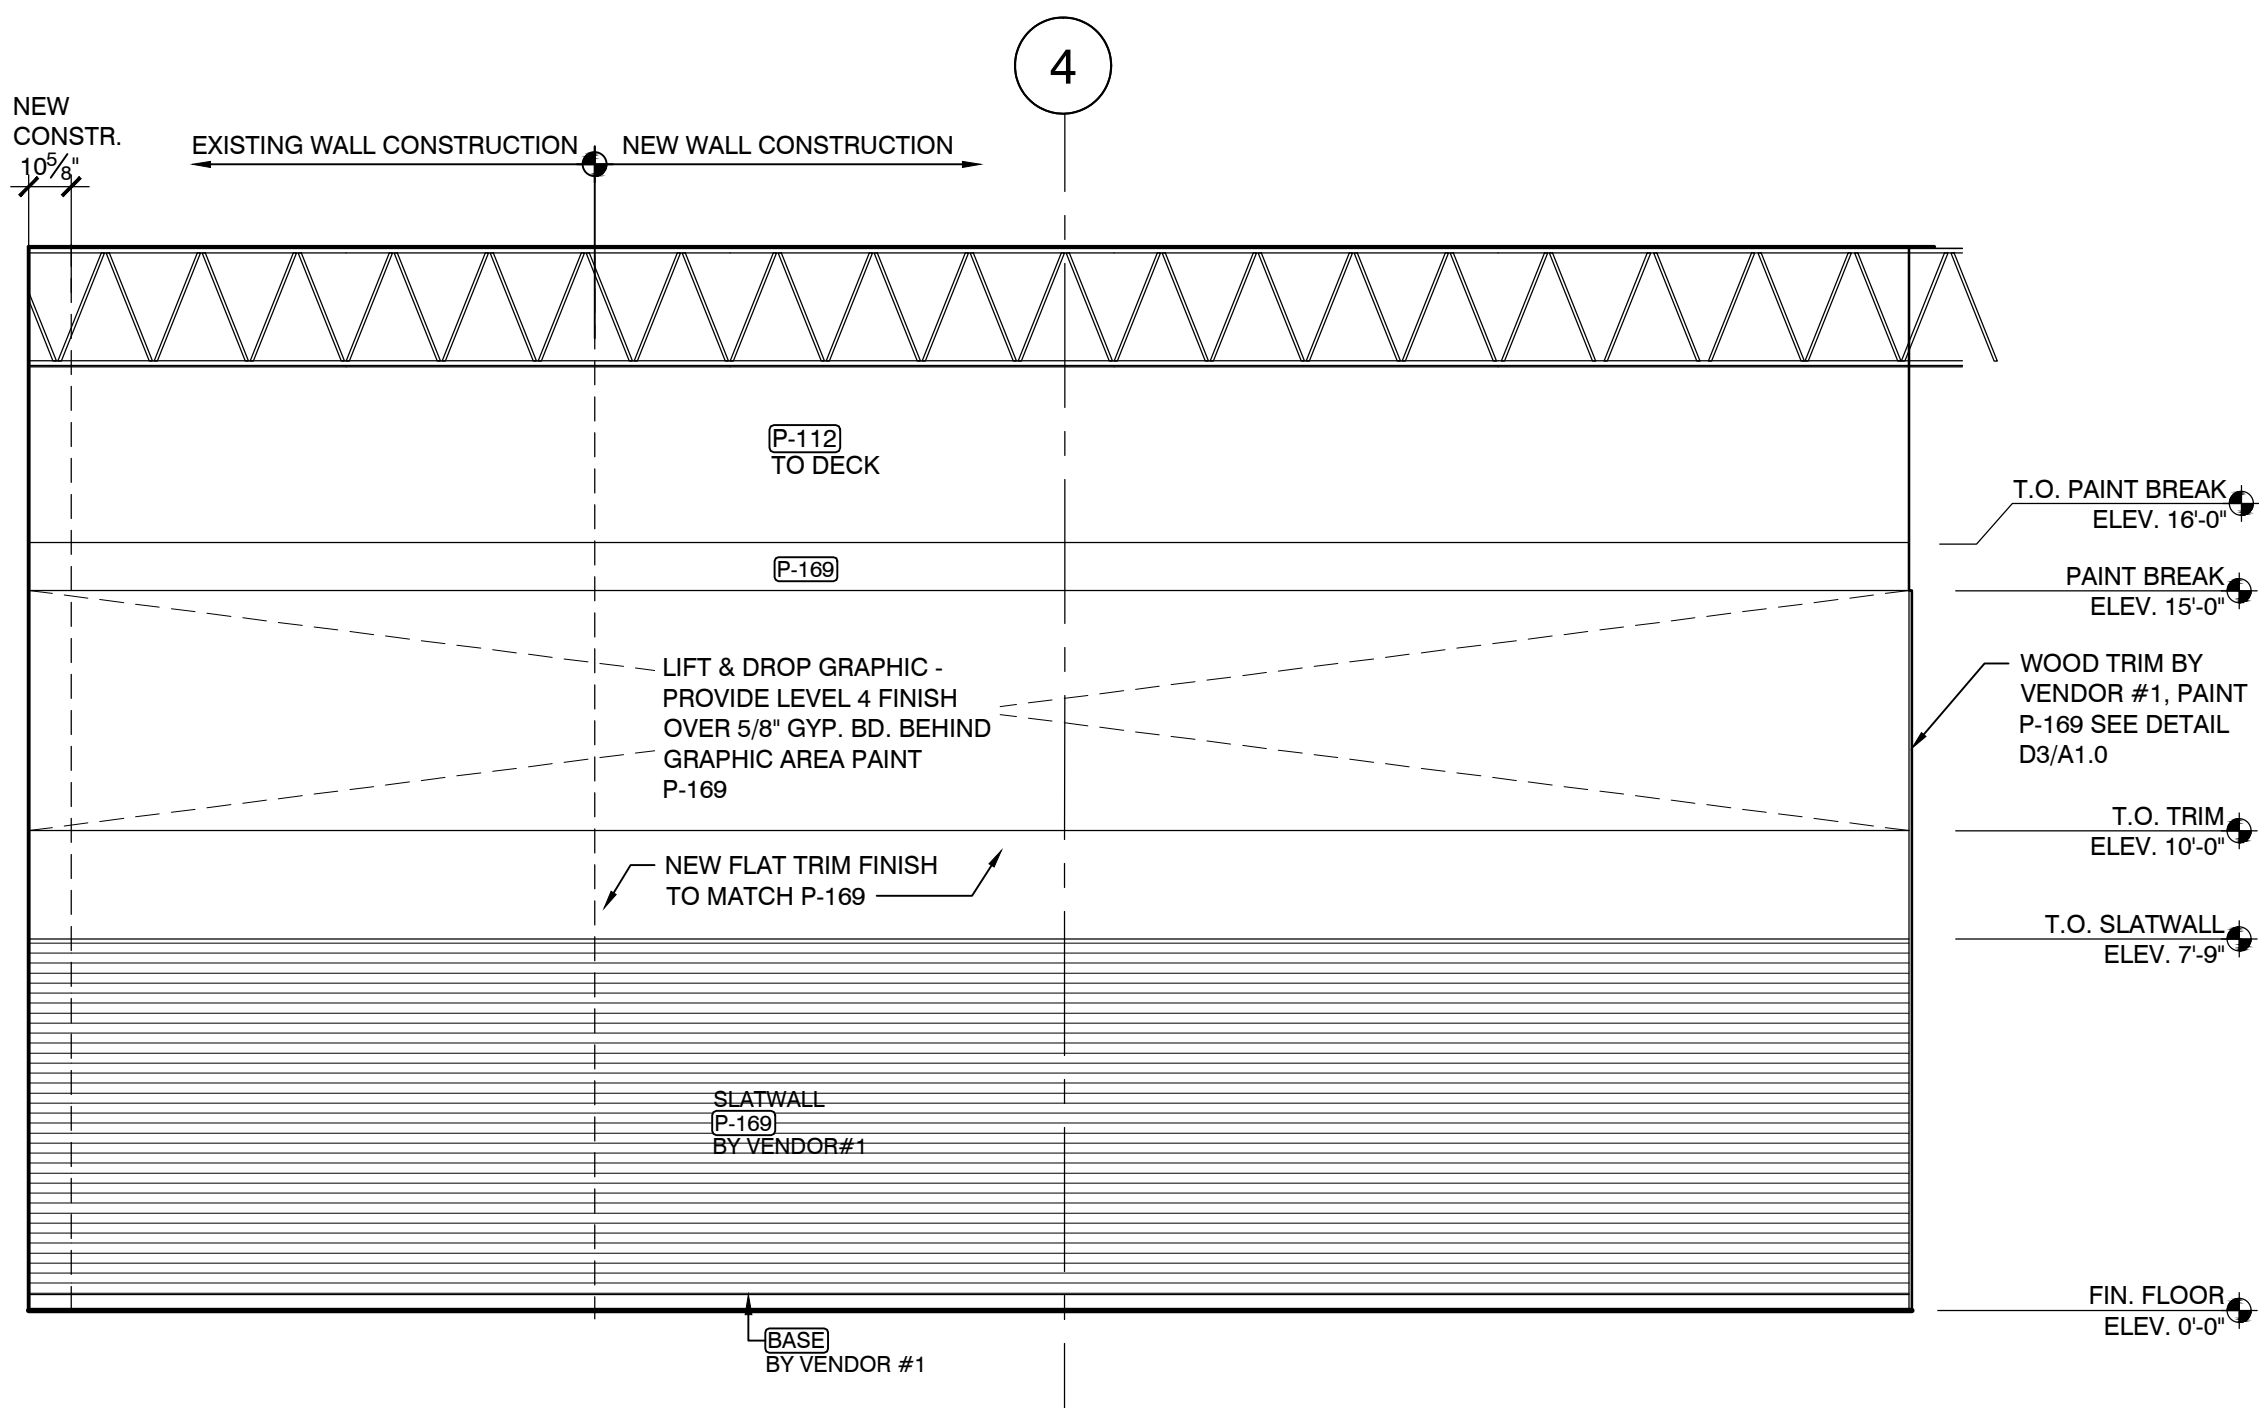

INTERIOR ELEVATION
FOOTWEAR

SCALE
1/4" = 1' - 0"


E4

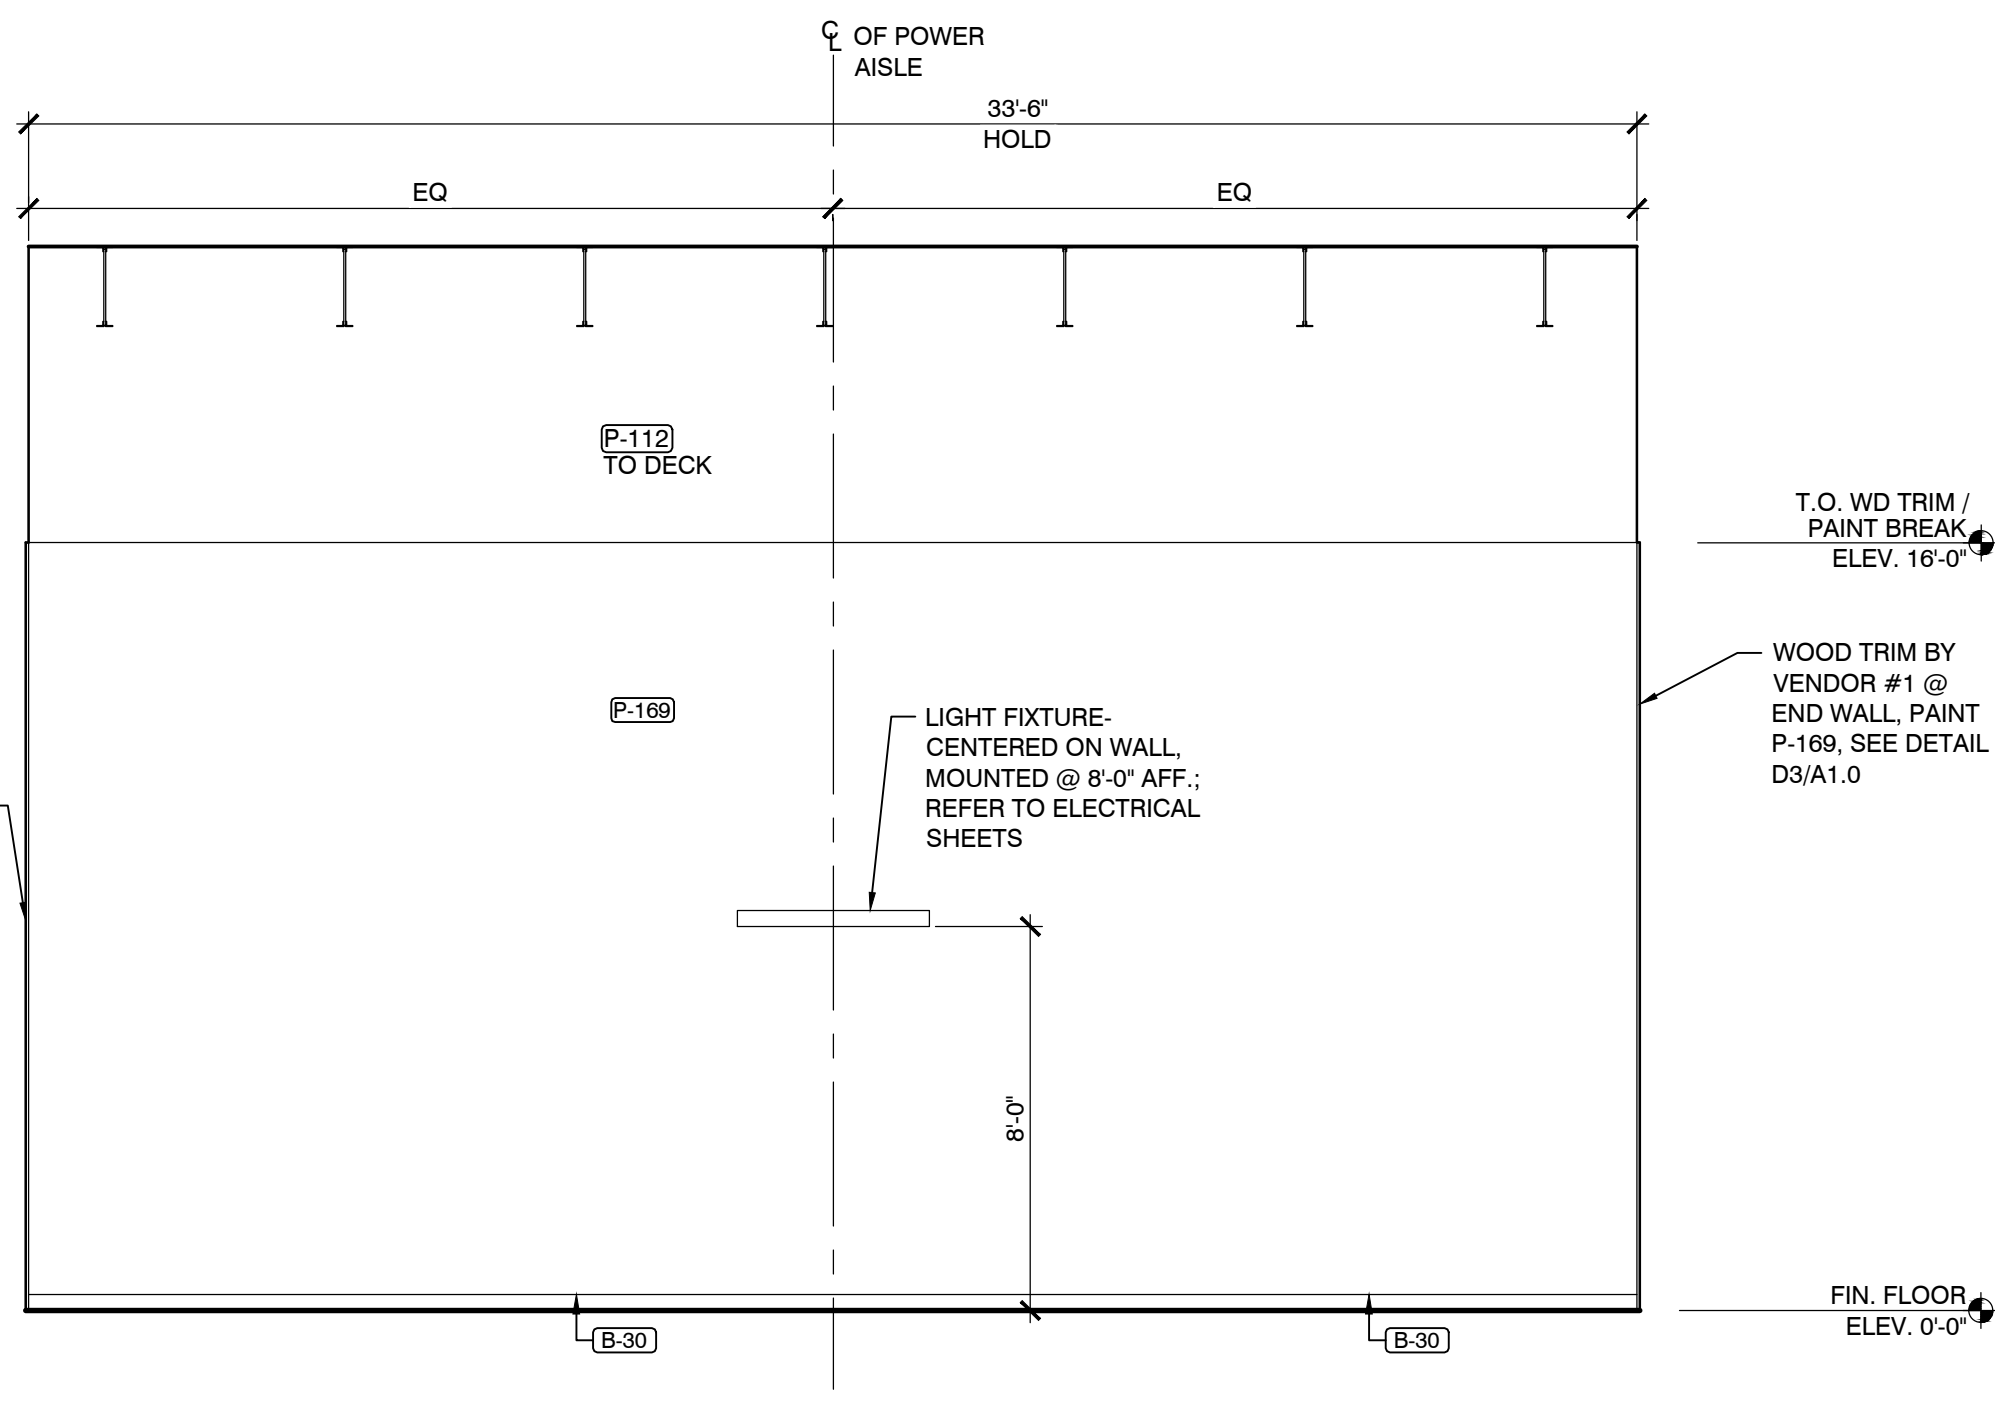

INTERIOR ELEVATION
FOOTWEAR

SCALE
1/4" = 1' - 0"


E3

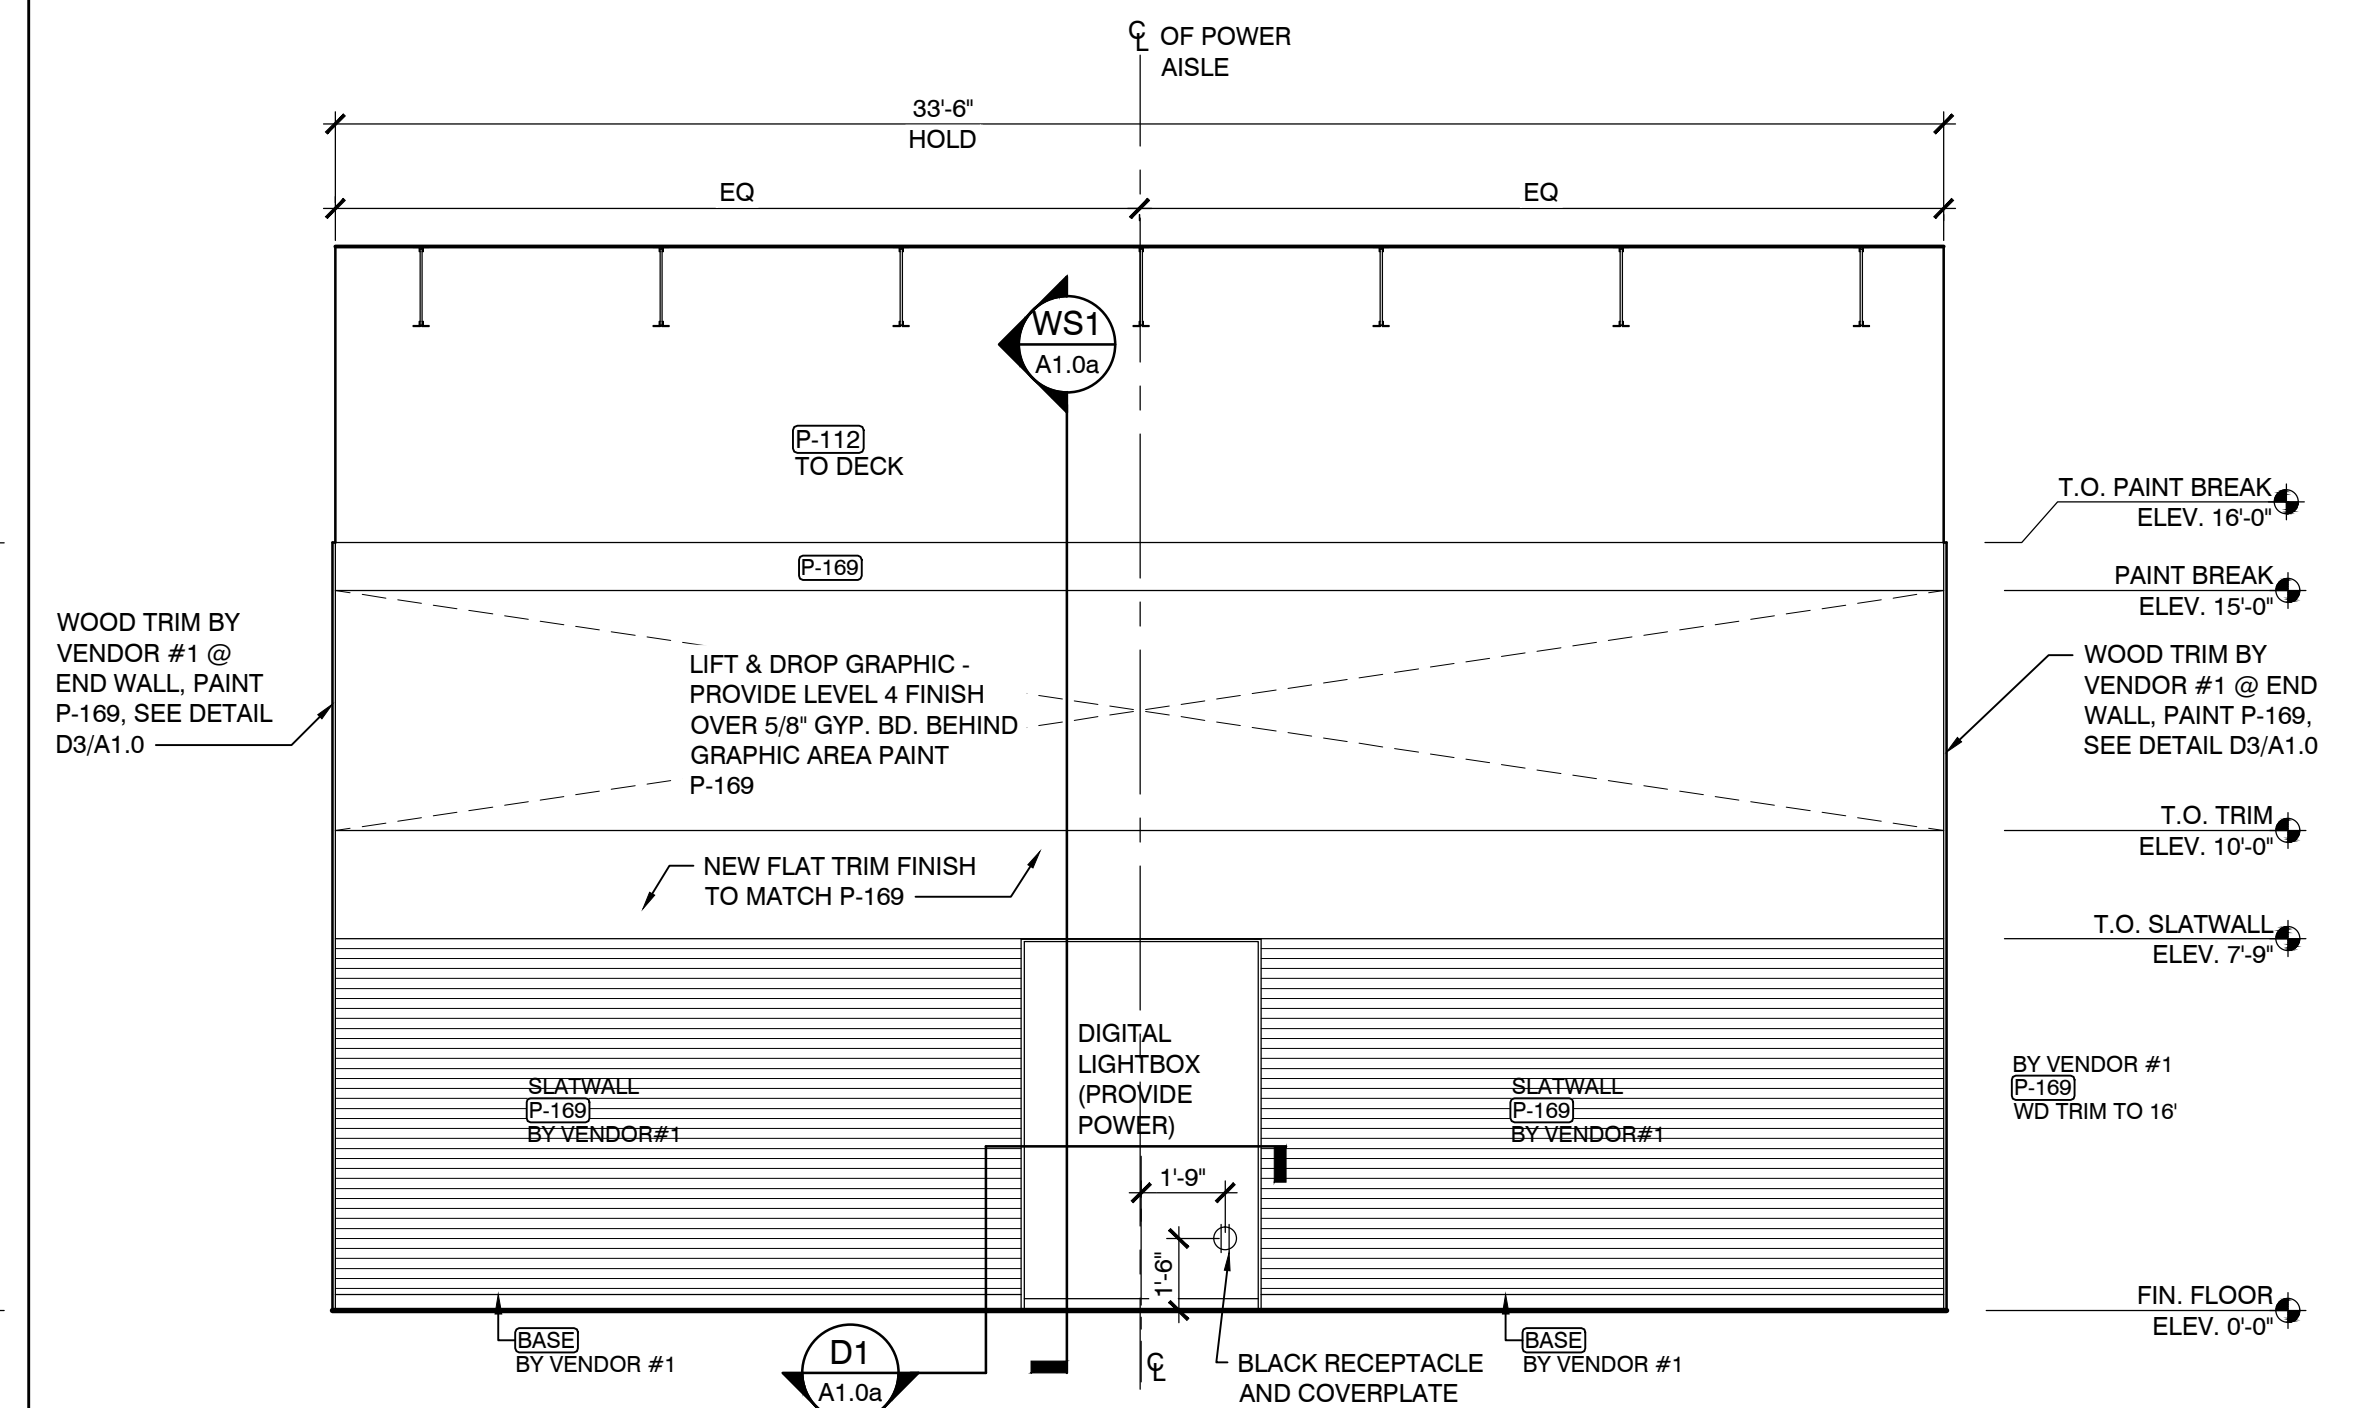

INTERIOR ELEVATION
FOOTWEAR

SCALE
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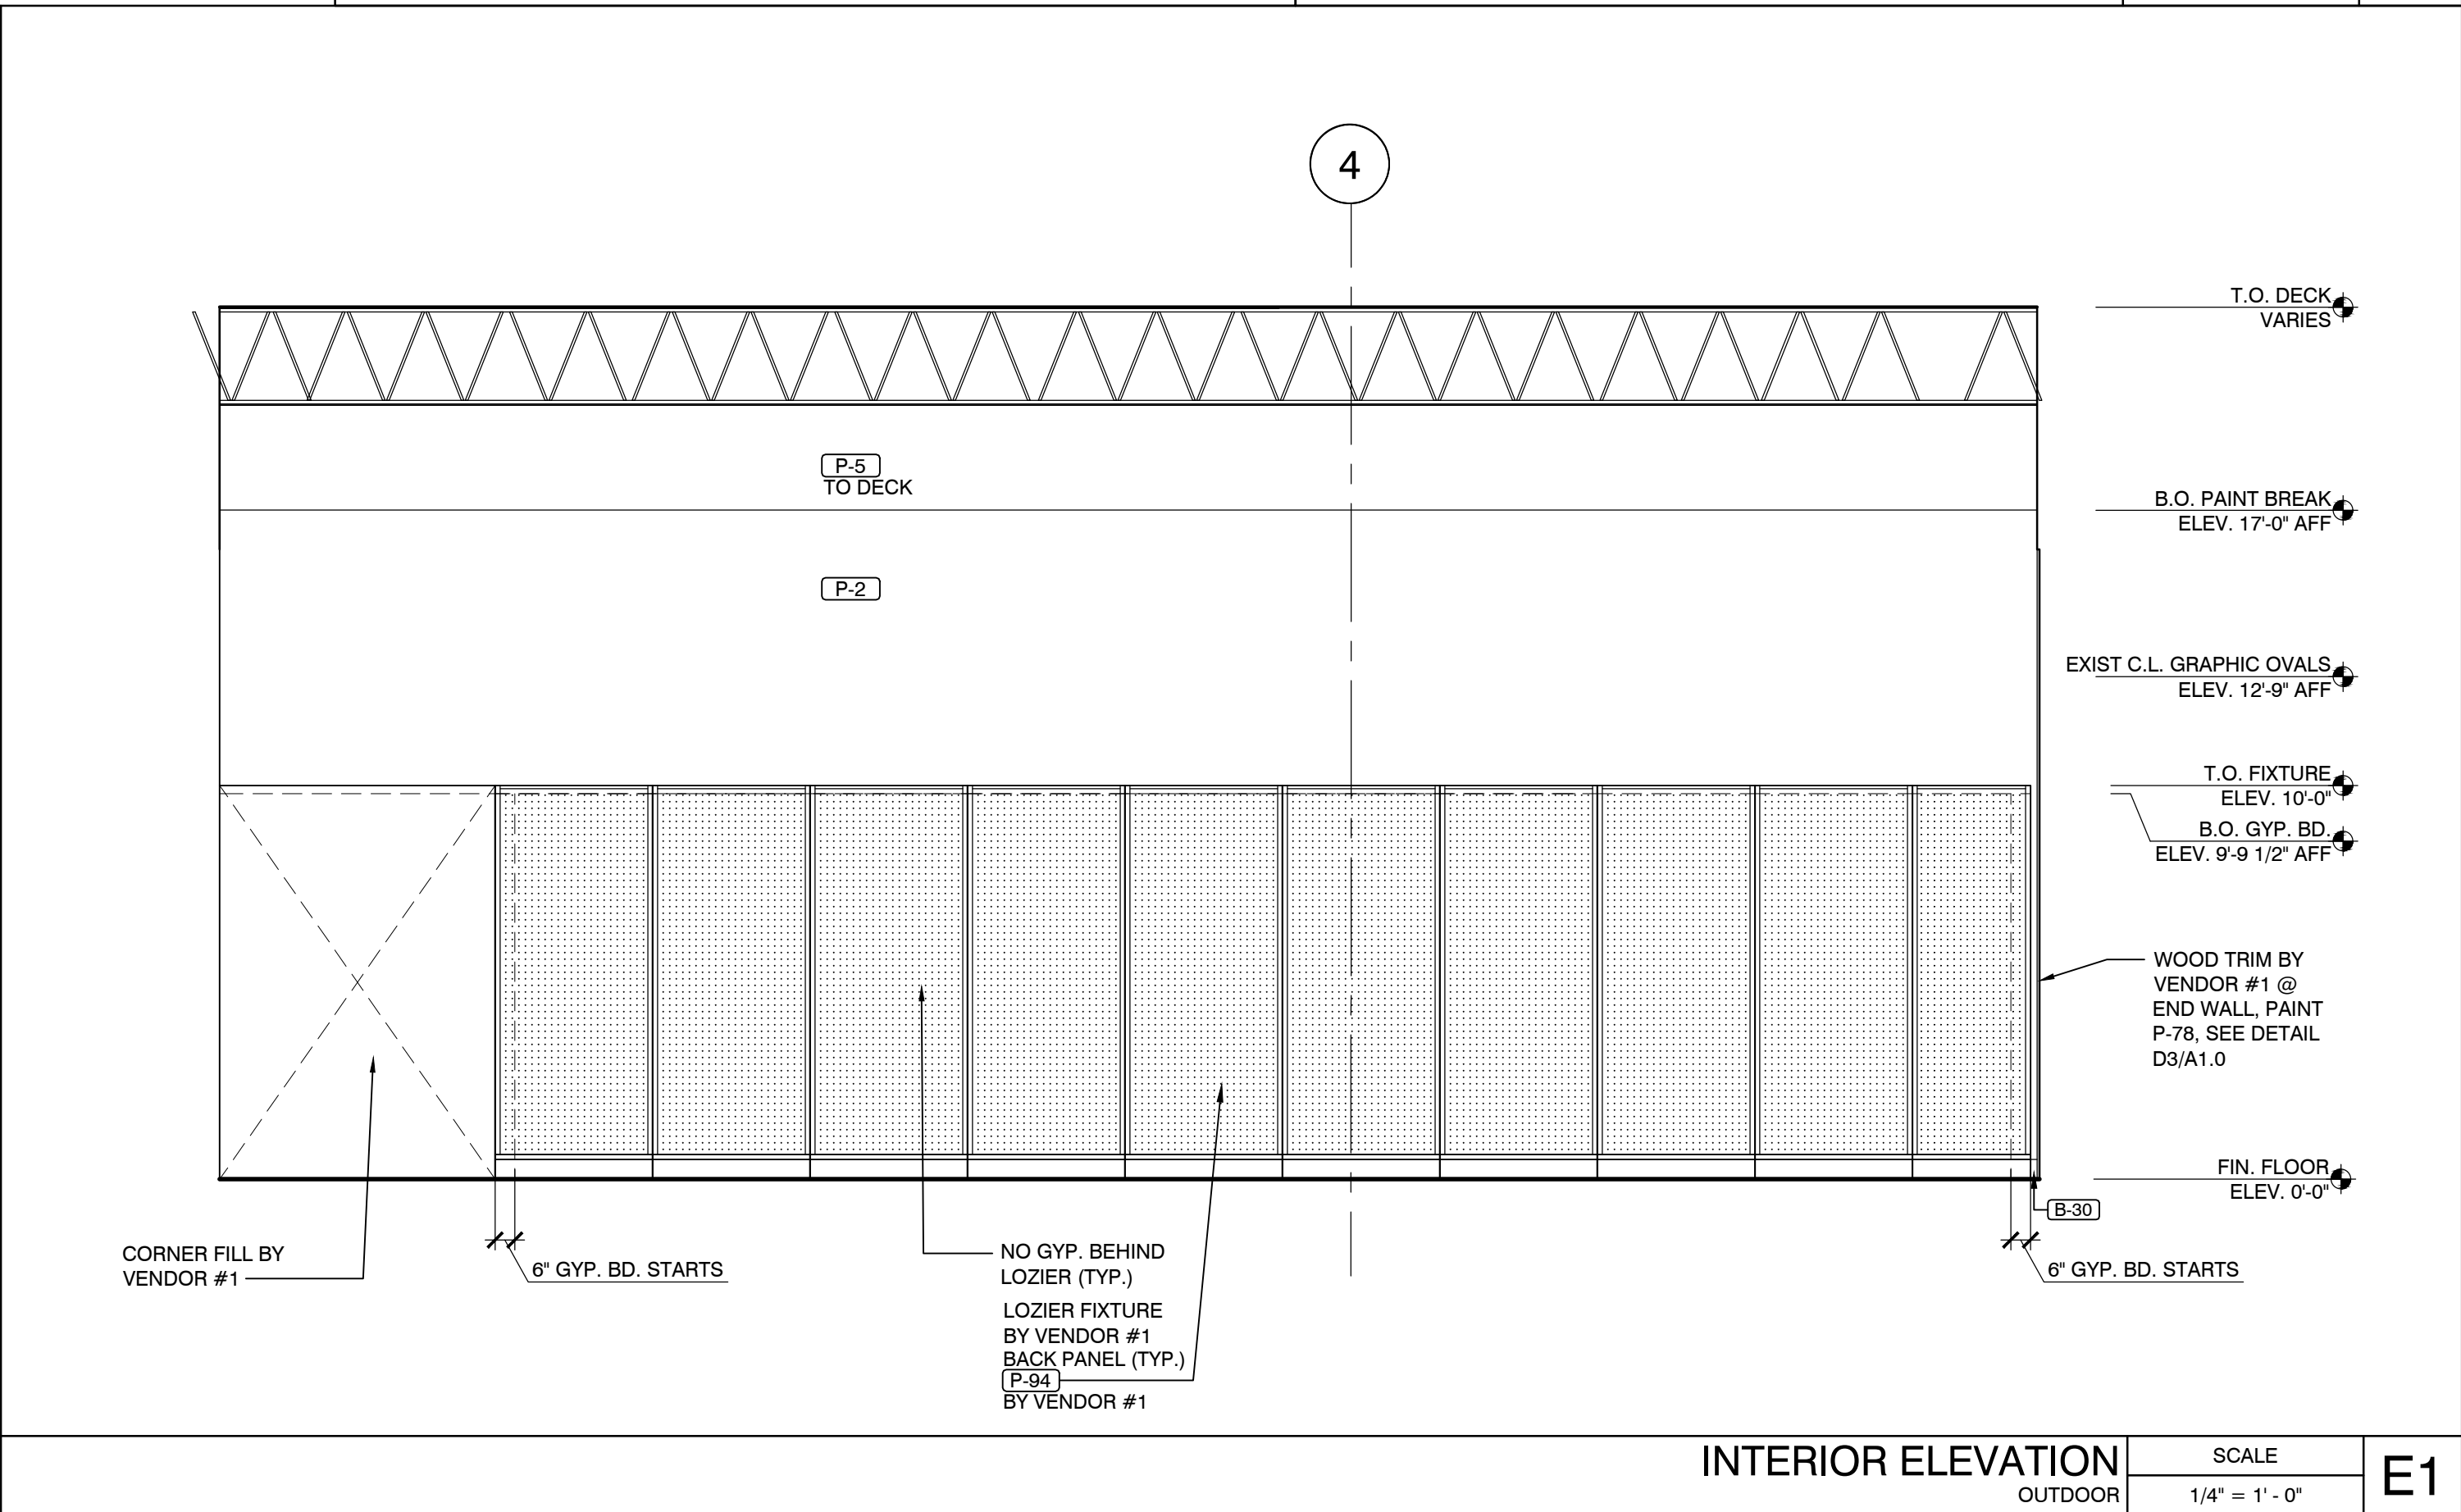
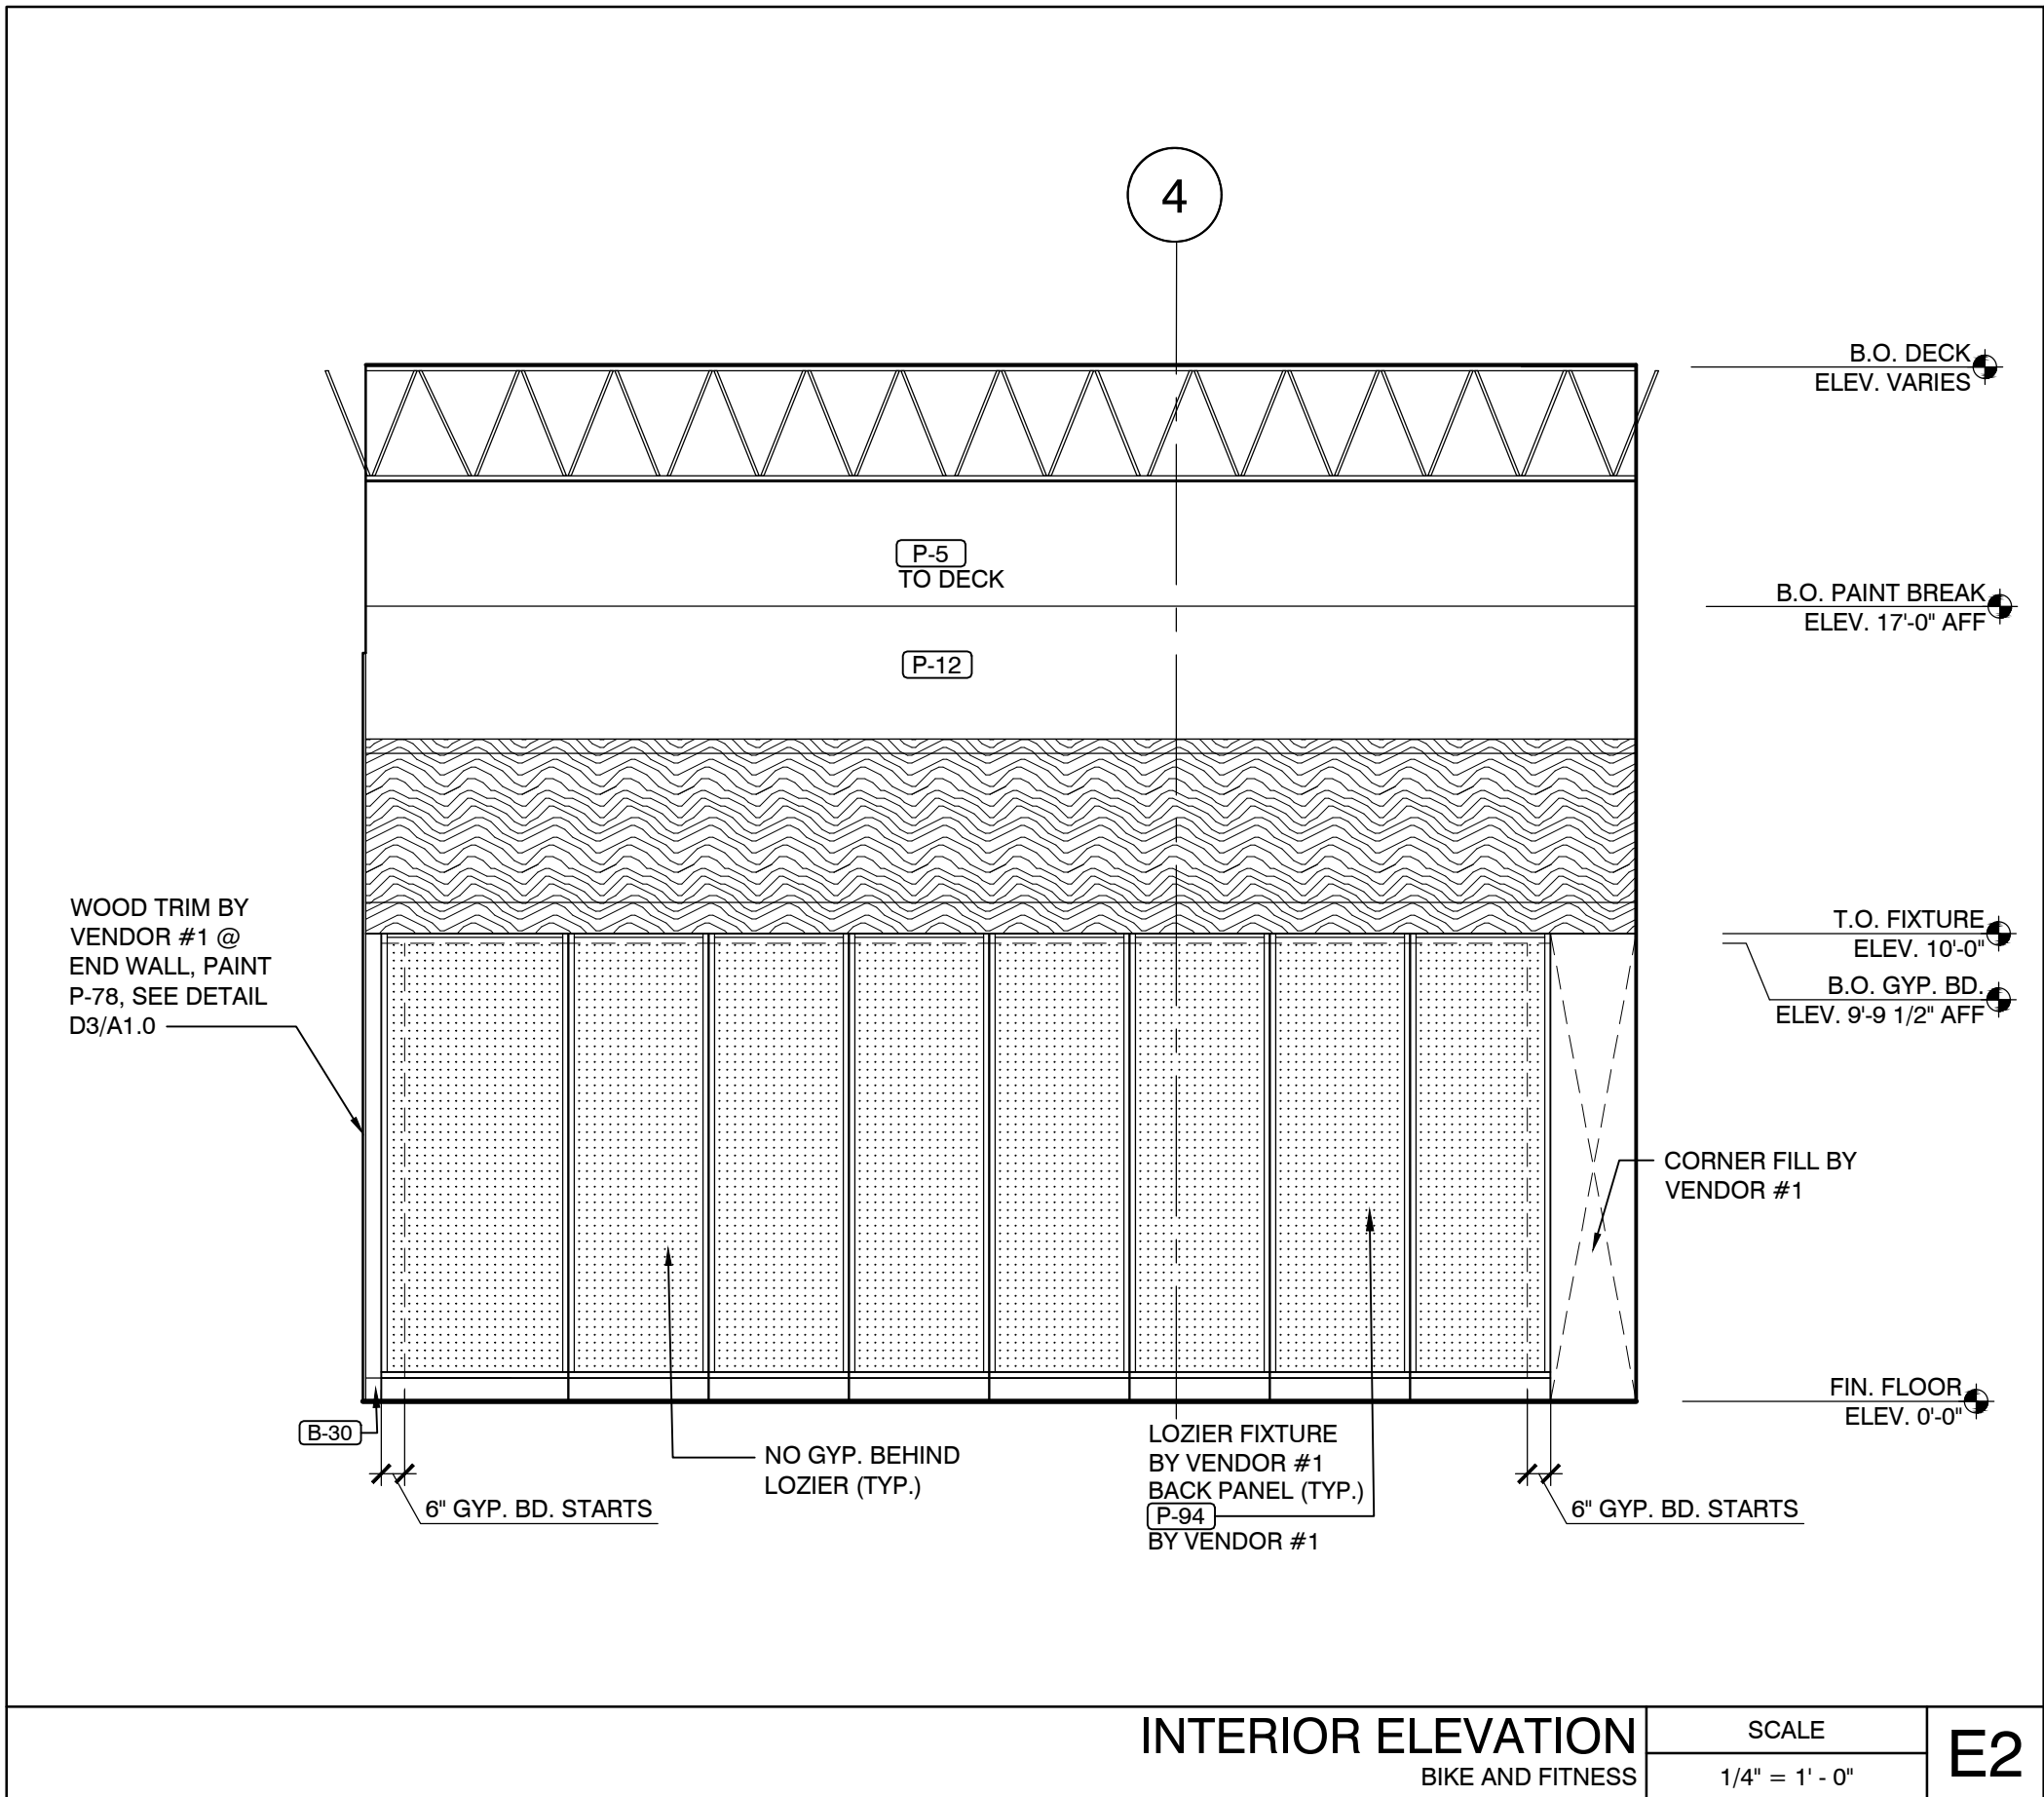
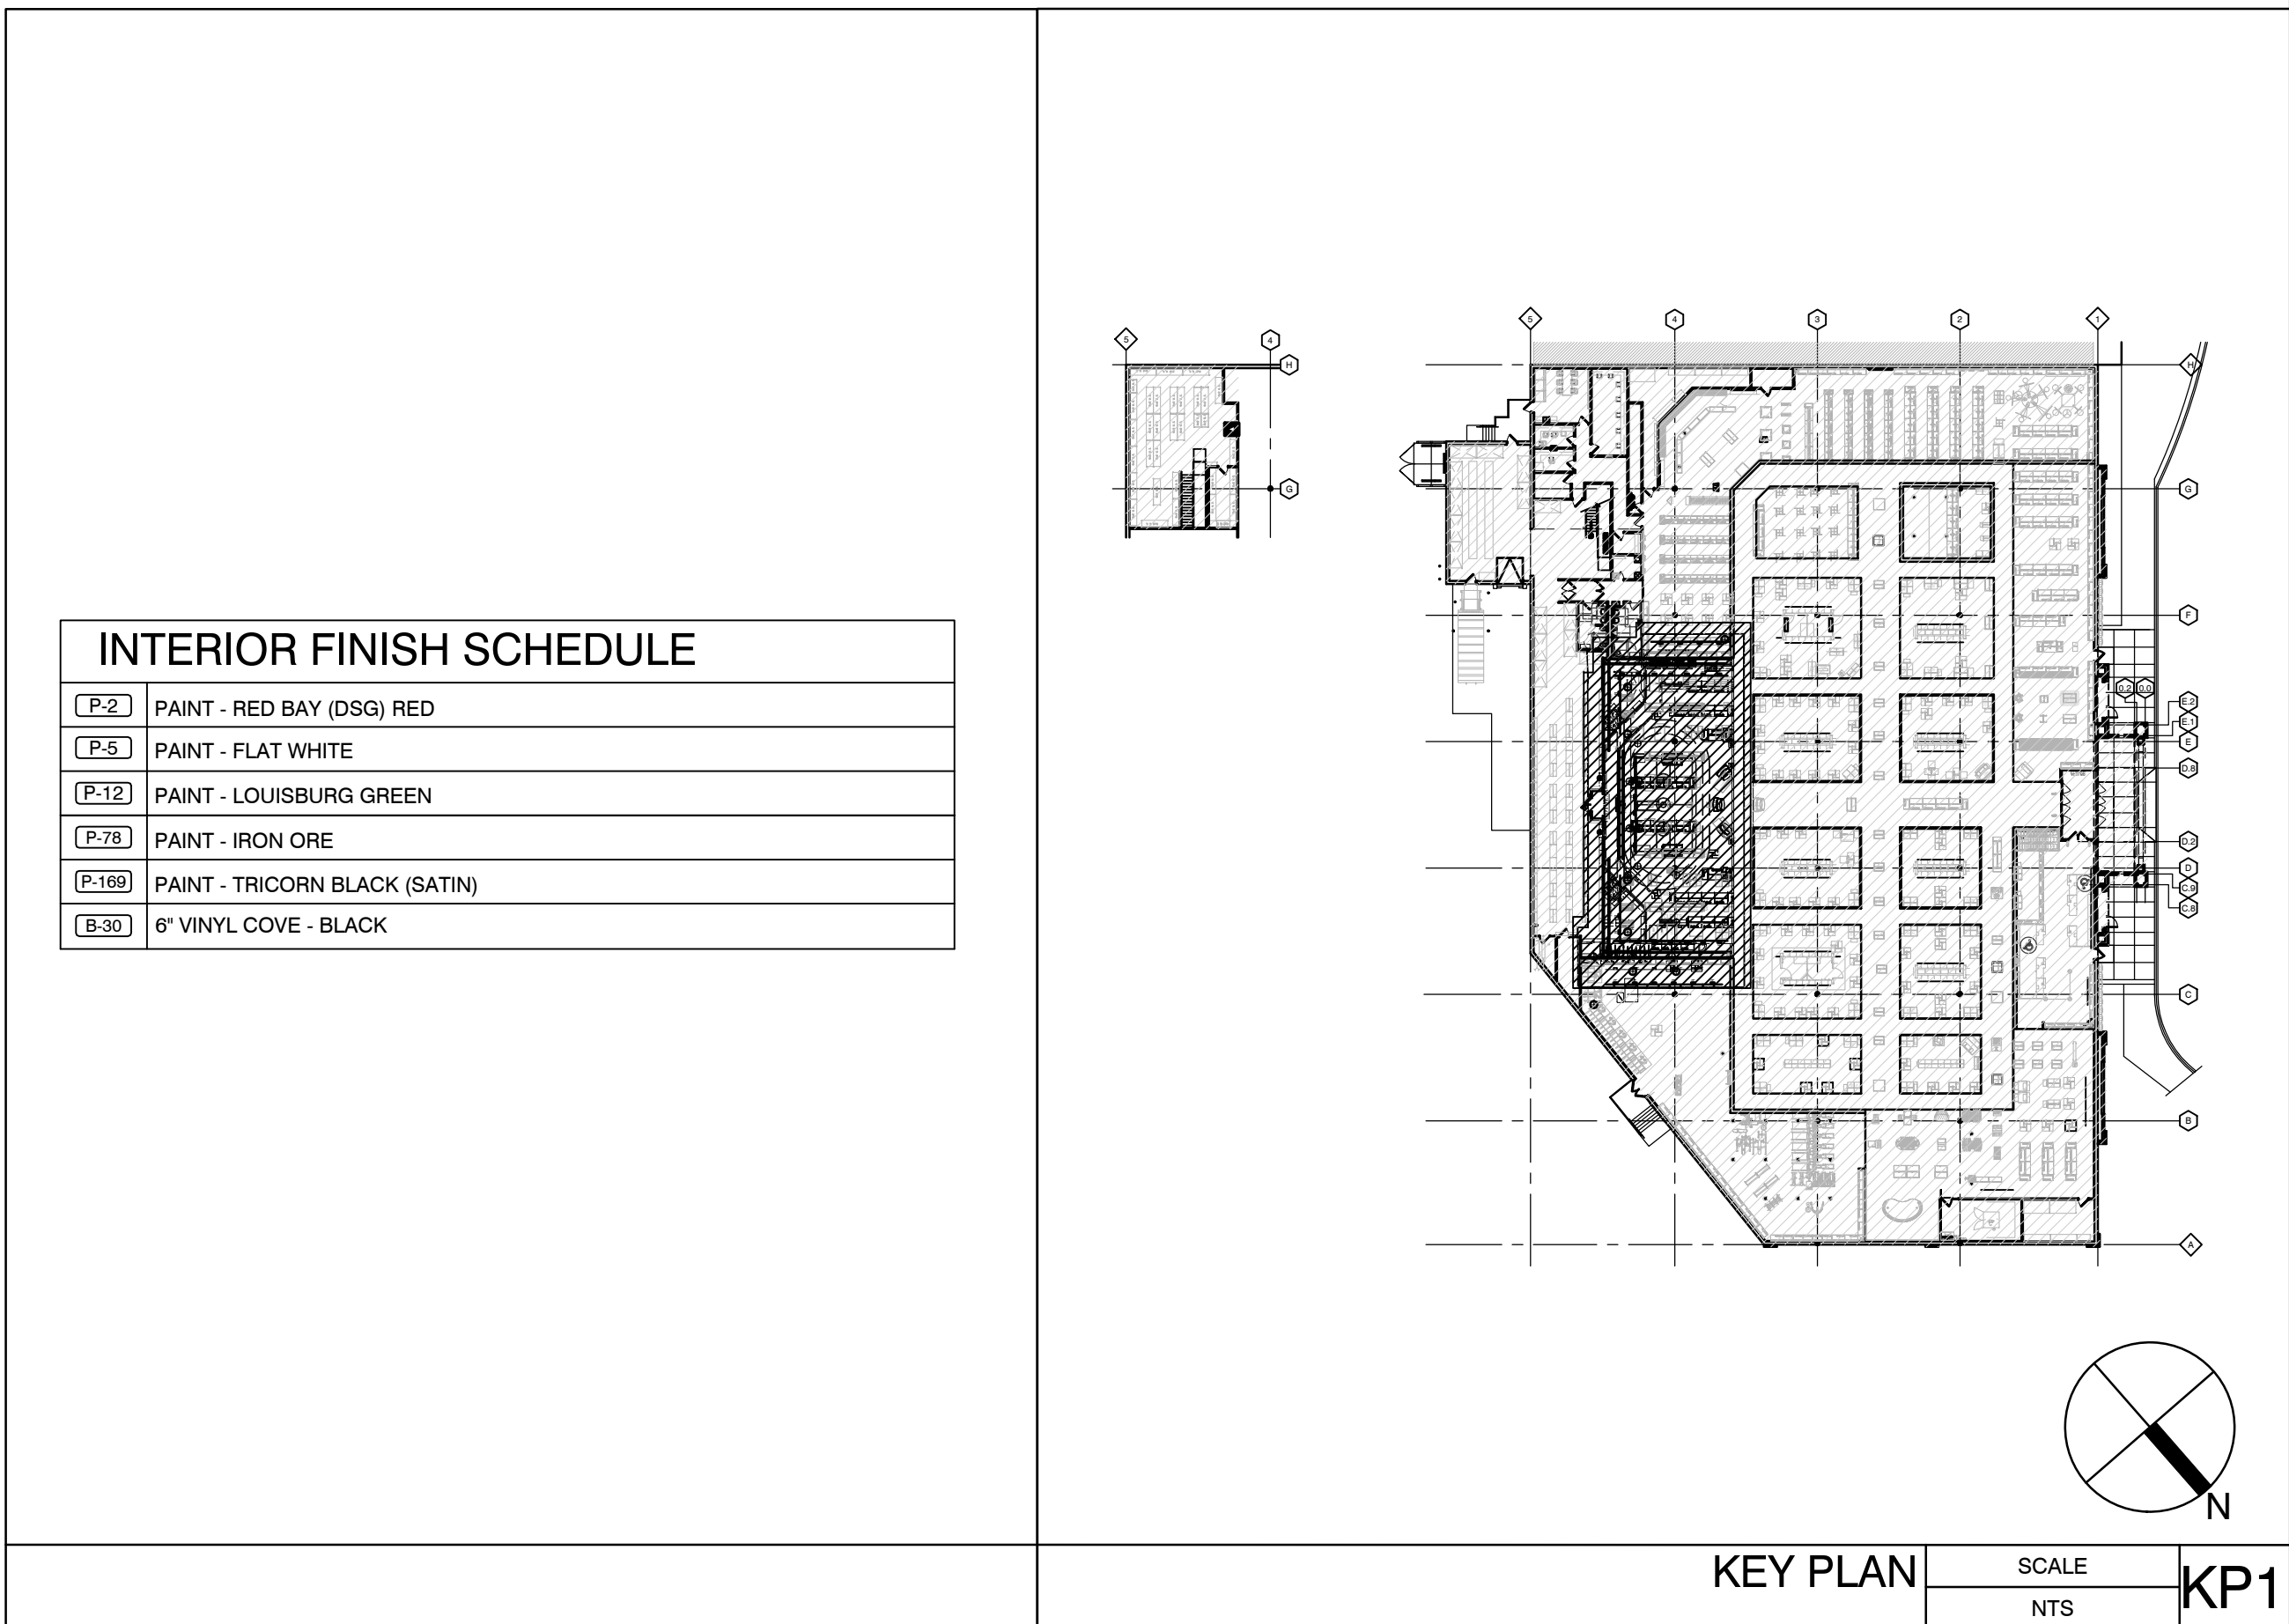
E2

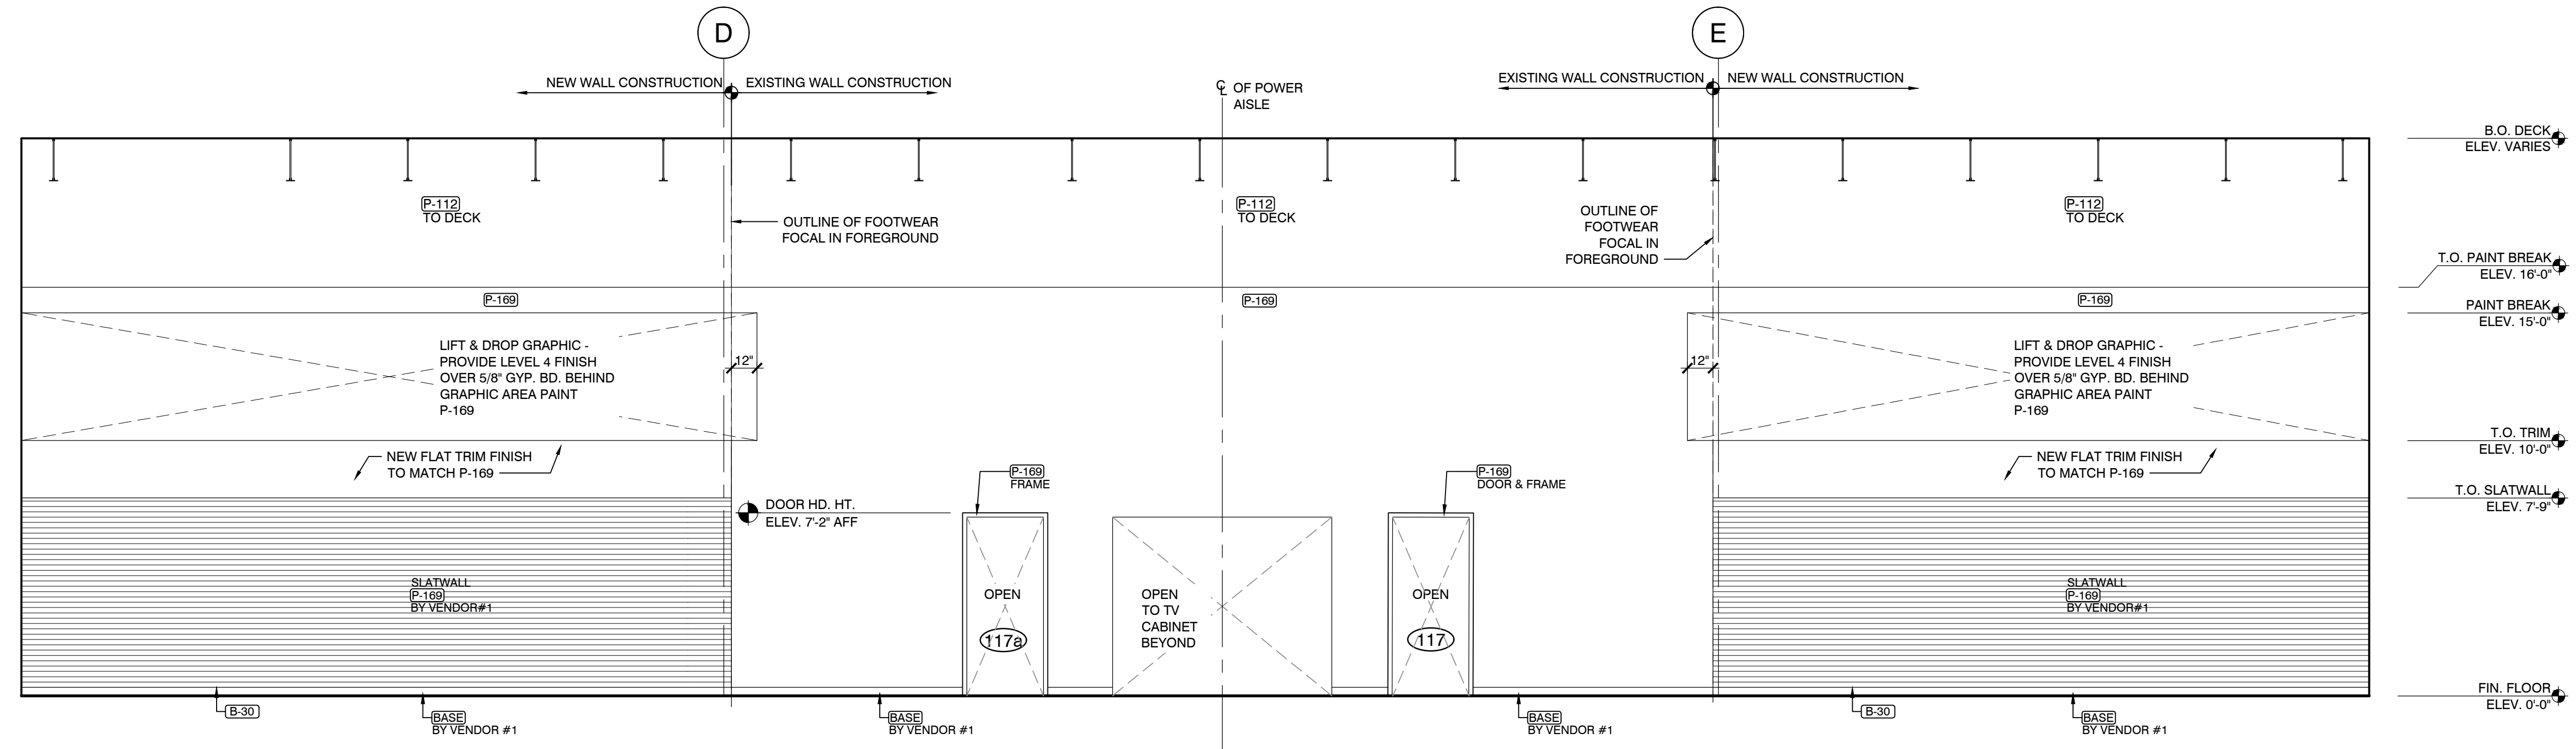

INTERIOR ELEVATIONS
FOOTWEAR

SCALE
1/4" = 1' - 0"

E1




1. DEMOLITION PLAN SHOWS APPROXIMATE LAYOUT OF EXISTING BUILDING AND IS NOT INTENDED TO REPRESENT AS-BUILT CONDITIONS. G.C. IS REQUIRED TO VISIT SITE AND BECOME FAMILIAR WITH ACTUAL CONDITIONS WHEN BIDDING THE WORK.
2. PRIOR TO ANY DEMOLITION WORK, CONTRACTOR MUST FIELD VERIFY ALL EXISTING MECHANICAL, PLUMBING AND ELECTRICAL WORK LOCATED IN THE TENANT SPACE WHICH AFFECTS THE ADJACENT TENANT SPACES. THE LANDLORD AND THE ADJACENT TENANTS MUST BE NOTIFIED PRIOR TO SHUTDOWN OF ANY SHARED MECHANICAL, PLUMBING AND ELECTRICAL SYSTEMS. 72 HOUR NOTICE REQUIRED.
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5. PROTECT FROM DAMAGE ALL EXISTING FINISH WORK TO REMAIN IN PLACE AND WHICH BECOMES EXPOSED DURING DEMOLITION OPERATIONS.
6. PROVIDE ALL NECESSARY SHORING, BRACING, AND SUPPORT TO PREVENT MOVEMENT, SETTLEMENT, OR COLLAPSE OF STRUCTURE OR ELEMENT TO BE DEMOLISHED, AND ADJACENT STRUCTURE OR ELEMENT SHOWN TO REMAIN. SHORING AND BRACING SHALL BE DESIGNED BY CONTRACTOR'S PROFESSIONAL ENGINEER LICENSED IN THE APPLICABLE JURISDICTION.
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8. SALVAGE MATERIAL AS REQUIRED FOR PATCHING AND INFILL (SEE DRAWINGS FOR NEW WORK). SALVAGE MATERIAL SHALL BE CLEANED AND STORED IN AREAS AWAY FROM THE DEMOLITION OR UNTIL NEEDED.
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15. G.C. TO COORD. DEMOLITION OF ALL EXISTING SYSTEMS WITH NEW SYSTEMS AND READ THIS DRAWING IN CONJUNCTION WITH ALL MECH, ELECT, PLUMBING AND FIRE PROTECTION DWGS. FOR COMPLETE SCOPE OF DEMOLITION WORK, TYP.

DEMOLITION NOTES

DATE	ISSUE
03-28-25	Issued for Bid-Permit

SCALE	DETAIL
NTS	NTS


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DEMOLITION COORDINATION NOTE:
G.C. TO COORDINATE FINAL CONSTRUCTION AND LOCATION OF TEMPORARY TALL GONDOLA TEMPORARY BARRIER ENCLOSURE W/ DSG PM

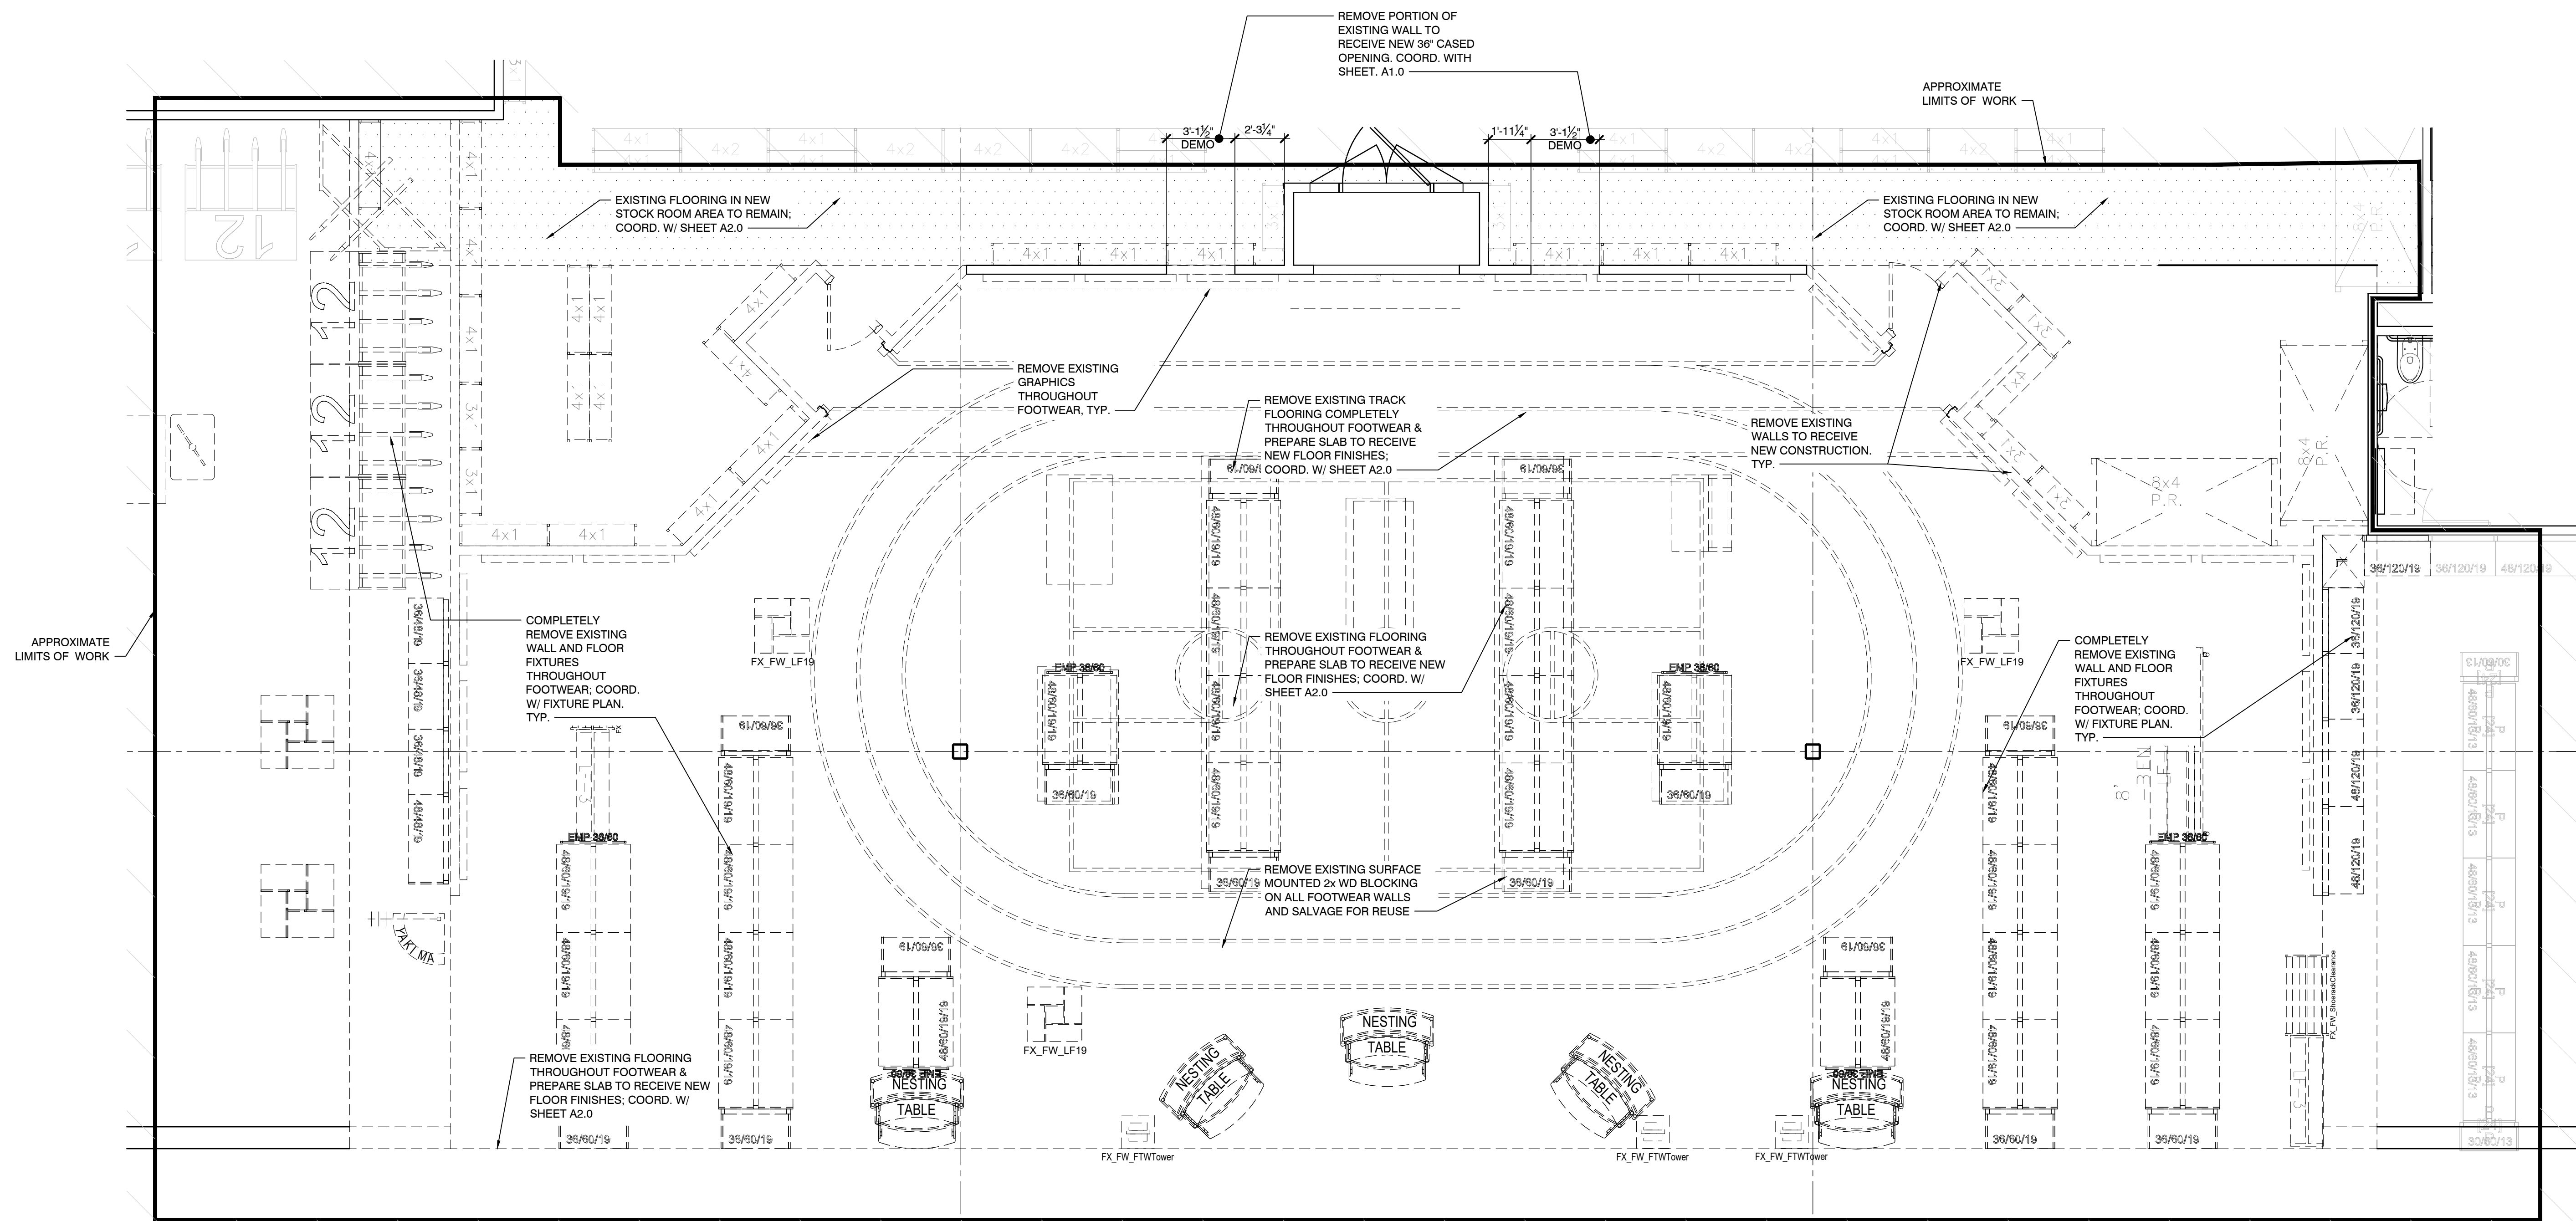DEMOLITION COORDINATION NOTE:
G.C. TO COORDINATE DIRECTLY WITH DSG CONSTRUCTION MANAGER REGARDING SALVAGING OF ALL DEMOLISHED RACKING AND FIXTURE MATERIALS. STORE SALVAGED MATERIAL IN LOCKABLE WEATHERPROOF STORAGE CONTAINER, IN AN APPROVED LOCATION ON SITE, AS DIRECTED BY DSG CONSTRUCTION MANAGER OR LANDLORD. COORDINATE ANY FUTURE MATERIAL RE-USE WITH DSG CONSTRUCTION MANAGER.

LEGEND
APPROXIMATE AREA OF NEW WORK
NO WORK IN THIS AREA



DEMOLITION FLOOR PLAN
FOOTWEAR

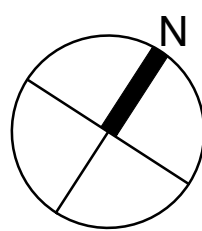SCALE
1/4\" = 1' - 0"

DP1

Drawn By: MCG
Project No.: 25061.10

STORE # 222
DICK'S SPORTING GOODS

MONADNOCK MARKETPLACE
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DEMOLITION
FLOOR PLAN
D1.0

- DEMOLITION PLAN SHOWS APPROXIMATE LAYOUT OF EXISTING BUILDING AND IS NOT INTENDED TO REPRESENT "AS-BUILT" CONDITIONS. G.C. IS REQUIRED TO VISIT SITE AND BECOME FAMILIAR WITH ACTUAL CONDITIONS WHEN BIDDING THE WORK.
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- | | |
|--|---|
| | EXISTING PENDANT HI-BAY LIGHT FIXTURES TO REMAIN |
| | EXISTING TRACK LIGHTS REMAIN |
| | EXISTING SURFACE MOUNTED EGRESS FIXTURE TO REMAIN |
| | EXISTING TRACK LIGHTS TO BE REMOVED & RELOCATED; COORD. W/ SHEET A3.0, TYP. |
| | EXISTING PENDANT HI-BAY LIGHT FIXTURES TO BE REMOVED & RELOCATED; COORD. W/ SHEET A3.0, TYP. |
| | EXISTING SURFACE MOUNTED EGRESS FIXTURE TO BE REMOVED AND RELOCATED; COORD. W/ SHEET A3.0, TYP. |

SYMBOL LEGEND


SCALE
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DEMOLITION NOTES


SCALE
NTS

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NOTE: OVERLAPPING LIGHT FIXTURES ARE LOCATED AT DIFFERENT HEIGHTS

- | LEGEND | |
|--------|------------------------------|
| | APPROXIMATE AREA OF NEW WORK |
| | NO WORK IN THIS AREA |

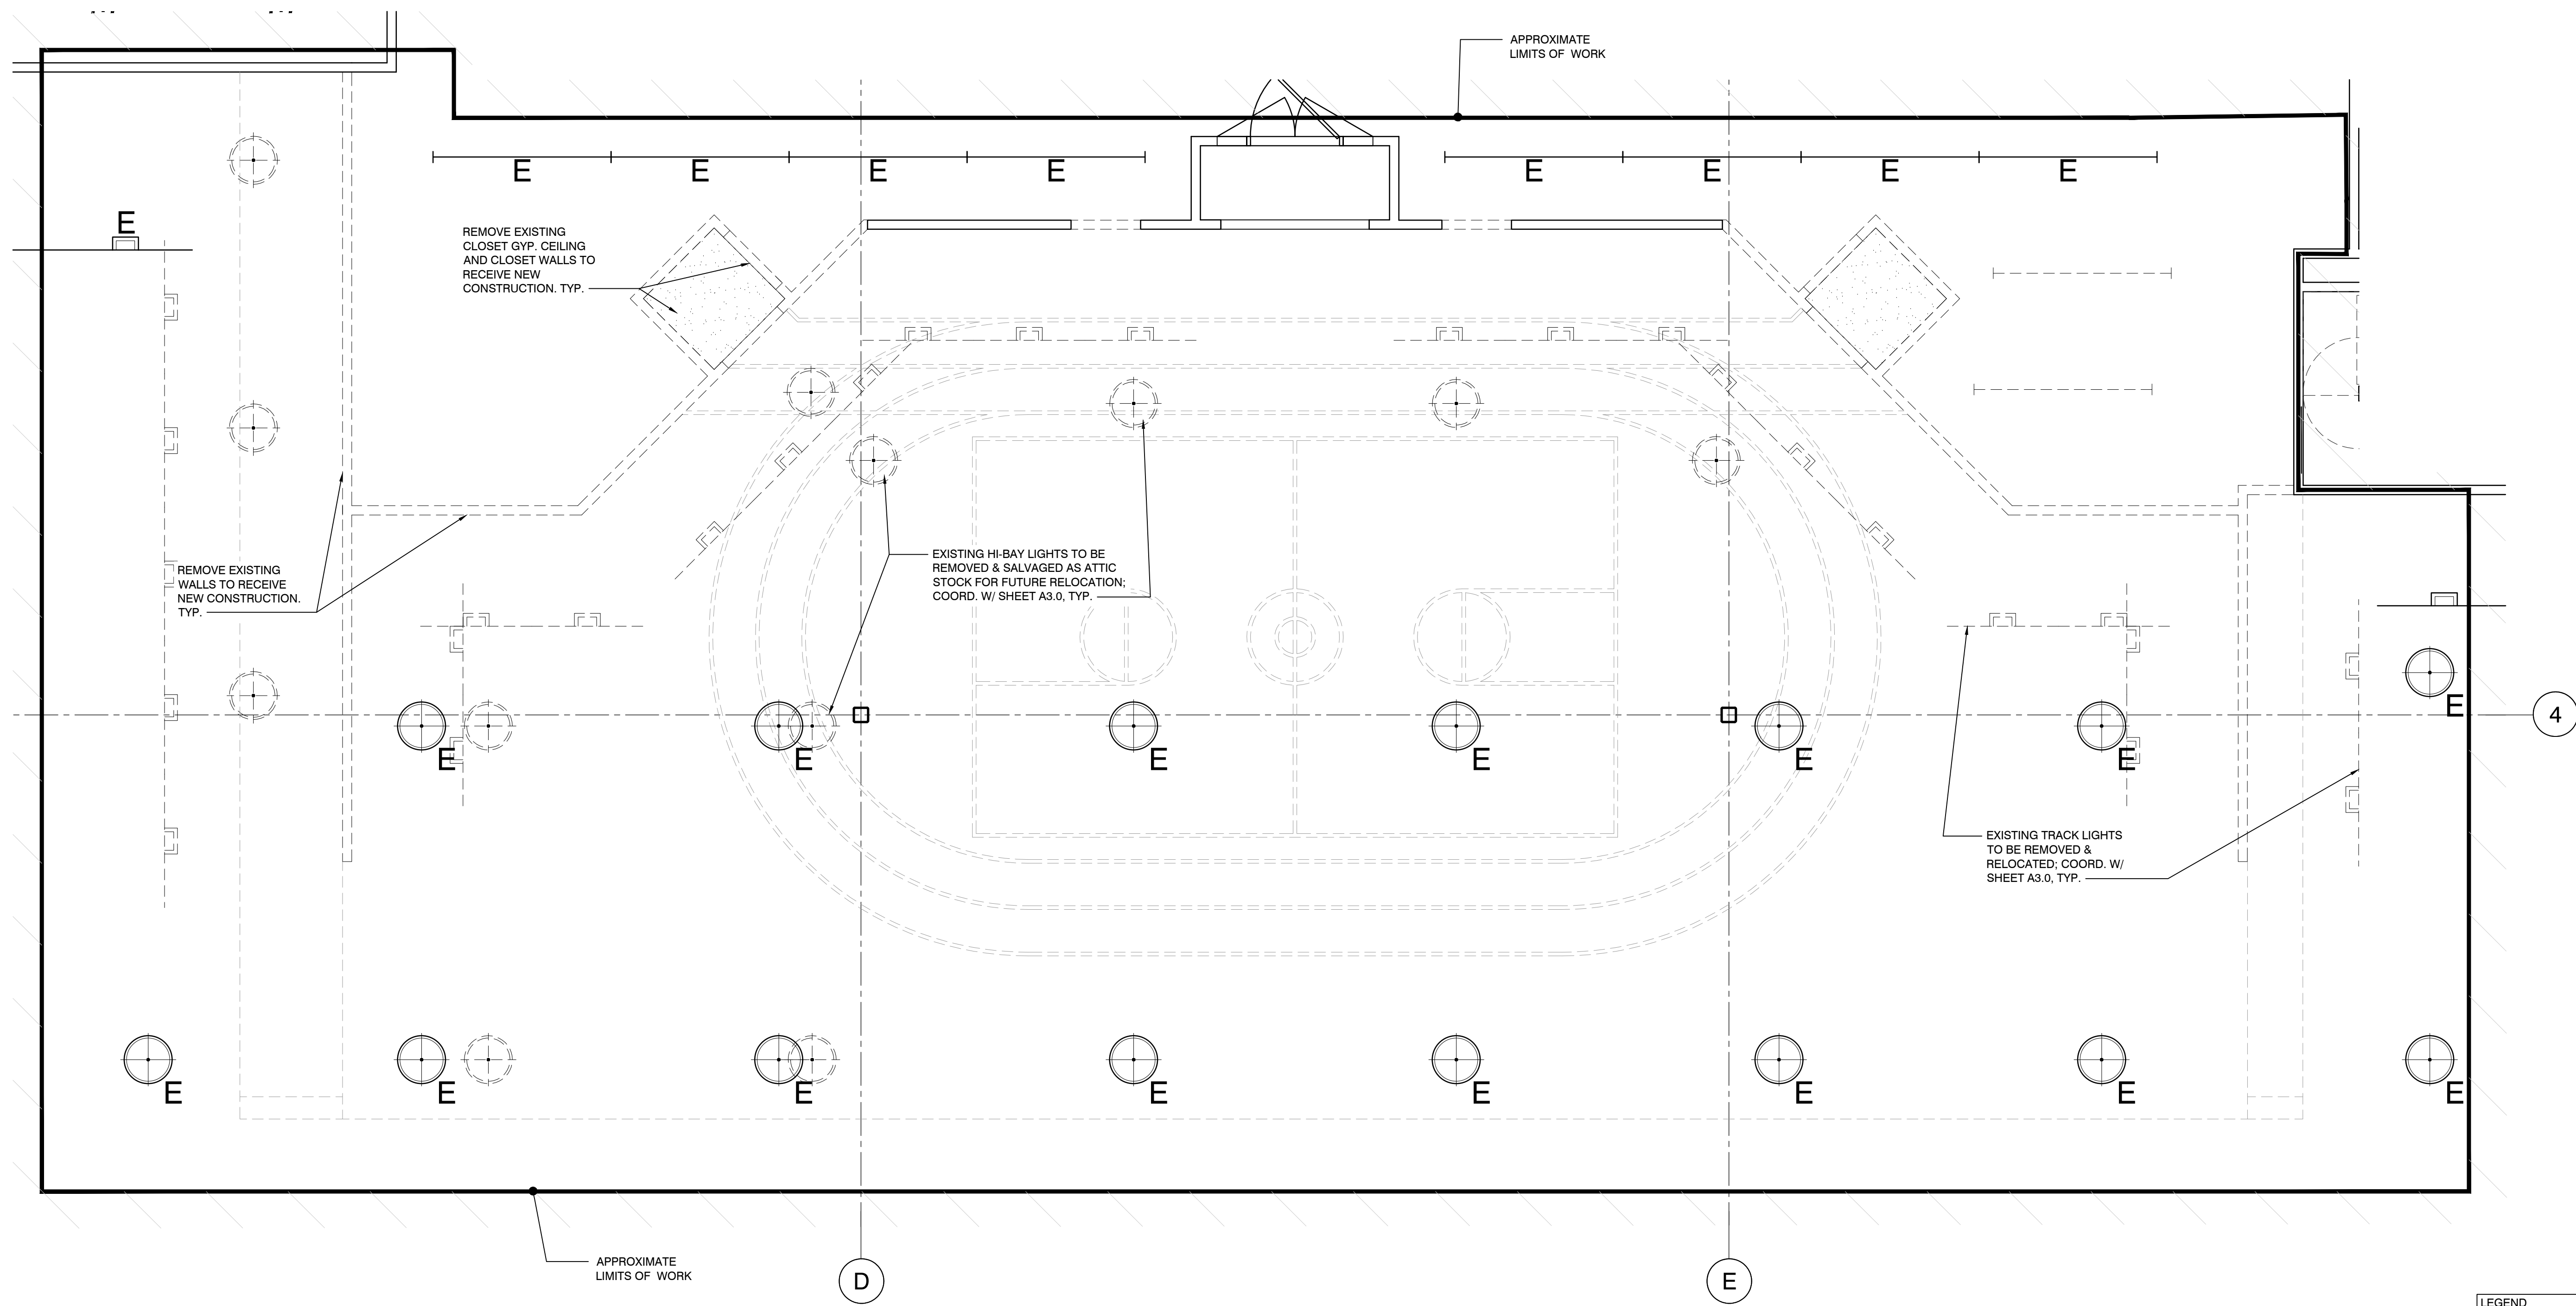

DEMOLITION CEILING PLAN
FOOTWEAR

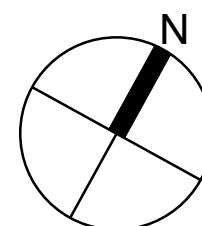SCALE
1/4" = 1'-0"

DP1

I. Code Data:

- A. 2021 International Building Code
B. 2021 New Hampshire Mechanical Code
C. 2021 New Hampshire Plumbing Code
D. 2020 New Hampshire Electrical Code/NFPA 70
E. 2021 New Hampshire Fire Code
F. 2021 Existing Building Code of the New Hampshire

II. Occupancy Group:

- A. Mercantile (M) Section 309
B. Storage (S-1) Section 311

Note: Mixed Occupancies for the purpose of later defined Non-Separated Uses Allowing No Rated Separation of Stock Rooms. (506.3)

III. Construction Type:

- A. II-B (Table 601) (Existing - No change)

IV. Fire Suppression System:

- A. Fully sprinklered (903.2.7)
B. Manual Fire alarm system not required for Group M occupancies (907.2.7) less than 500 occupants above grade exit discharge or where building is equipped throughout with an automatic sprinkler system installed in accordance with Section 903.3.1.1

EXISTING SPRINKLER TO REMAIN AS-IS IN AREAS UNAFFECTED BY CONSTRUCTION. SPRINKLER SYSTEM TO BE MAINTAINED AND KEPT IN WORKING ORDER DURING DEMOLITION AND NEW WORK.

FIRE ALARM SYSTEM SHALL REMAIN IN SERVICE DURING CONSTRUCTION. TAKE NECESSARY PRECAUTIONS TO PREVENT FALSE ALARMS DURING WORK HOURS.

V. Existing Exit Capacity:

- A. Number of Exits: 5 existing exits (No change)

Affected Area (Within limits of new work)

Existing Area:

Storage: ± 889
Mercantile: ± 4,317 sf
Total: ± 5,206 sf

Proposed Area:
Storage: ± 493
Mercantile: ± 4,743 sf
Total: ± 5,236 sf

The new layout reduces the Mercantile Area and increases the Storage Area, thereby reducing the occupant load due to the lesser occupant load factor for accessory Storage occupancy.

VI. Occupant Load (Table 1004.5)

SECTION 1003 - GENERAL MEANS OF EGRESS.
(REFER TO TABLE 1004.5 for maximum floor area allowances per occupant.)


SALES FLOOR = 60 ± 1 GROSS/OCCUPANT (4,743 ± 1) =	79 OCCUPANTS
STORAGE/RECEIVING = 30 ± 1 GROSS/OCCUPANT (493 ± 1) =	2 OCCUPANTS
5,236 TOTAL ± 1	81 OCCUPANTS TOTAL

NOTE:
IN SUMMATION, THE ALTERATIONS REDUCE THE OCCUPANT LOAD AND DO NOT AFFECT THE EXISTING EGRESS AND EXISTING PLUMBING FIXTURE CALCULATIONS OR REQUIREMENTS.


LEGEND
— APPROXIMATE AREA OF NEW WORK
NO WORK IN THIS AREA



TENANT
DICK'S SPORTING GOODS
345 COURT STREET
CORAOPOLIS, PA 15108

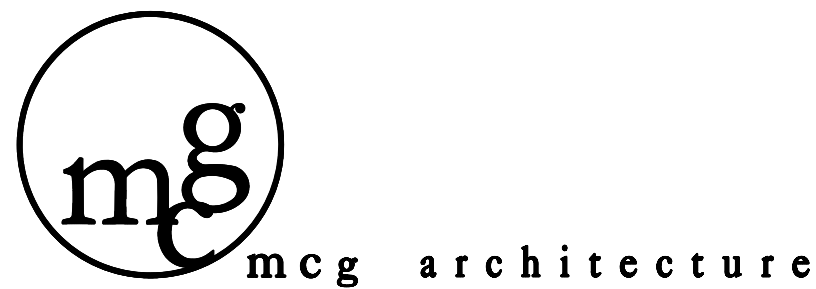

ARCHITECT
MCG ARCHITECTURE
7100 E. PLEASANT VALLEY ROAD, SUITE 320
CLEVELAND, OH 44131
CONTACT: TYLER KAMCZYC
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MEP ENGINEER
MCHENRY & ASSOCIATES, INC.
25001 EMERY ROAD, SUITE #200
WARRENSVILLE HEIGHTS, OHIO 44128
CONTACT: MATT DAVIS
PHONE: (216) 292-4696
FAX: (216) 292-5874
E-MAIL: mdavis@mchenryassociates.com

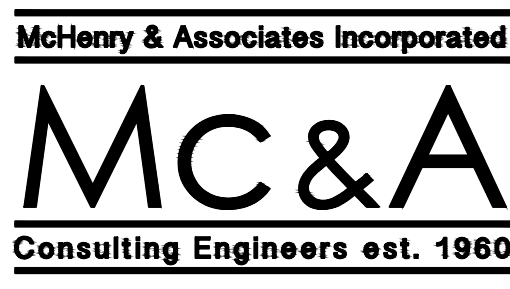MONADNOCK MARKETPLACE

42 ASH BROOK ROAD
KEENE, NH 03431
STORE #222

SCOPE OF WORK

THIS PROJECT IS A MINOR SPACE OPTIMIZATION REMODEL OF THE EXISTING FOOTWEAR DEPARTMENT. THIS REMODEL AFFECTS APPROXIMATELY ±5,206 S.F. OF AN APPROXIMATELY ±48,266 S.F. STORE.


SCOPE INCLUDES DEMOLITION, CONSTRUCTION OF NEW NON-LOAD BEARING PARTITIONS, MINOR ELECTRICAL WORK, AND MINOR HVAC WORK. NO STRUCTURAL WORK IS INVOLVED IN THE SCOPE OF WORK.

DEMOLITION IS LIMITED TO REMOVAL AND RELOCATION (WHERE NOTED) OF EXISTING GRAPHICS, FIXTURES, AND LIGHTING. NEW WORK IS TO INCLUDE ADDITION OF NON-LOAD BEARING PARTITIONS AND NEW FINISHES THROUGHOUT FOOTWEAR DEPARTMENT. THE EXISTING HVAC SYSTEM IS TO REMAIN WITH MINOR ALTERATIONS.

DEMOLITION COORDINATION NOTE:

G.C. TO COORDINATE DIRECTLY WITH DSG CONSTRUCTION MANAGER REGARDING SALVAGING OF ALL DEMOLISHED RACKING AND FIXTURE MATERIALS. STORE SALVAGED MATERIAL IN LOCKABLE WEATHERPROOF STORAGE CONTAINER, IN AN APPROVED LOCATION ON SITE, AS DIRECTED BY DSG CONSTRUCTION MANAGER OR LANDLORD. COORDINATE ANY FUTURE MATERIAL RE-USE WITH DSG CONSTRUCTION MANAGER.

GRAPHIC SYMBOLS

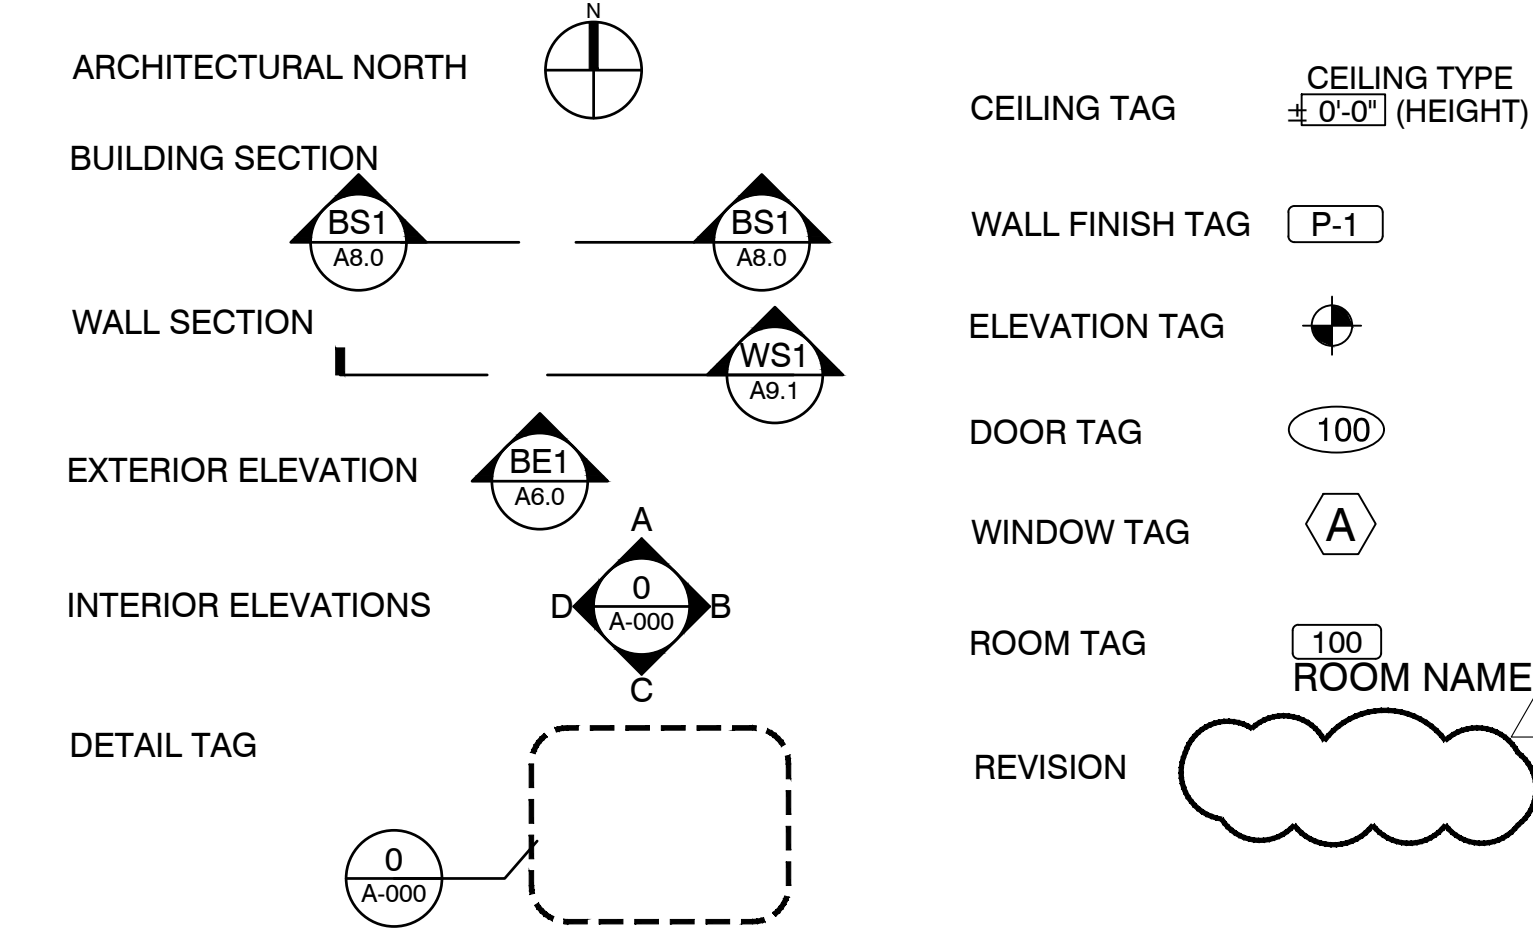

ABBREVIATIONS

A.F.F.	Above Finish Floor	EXP.	Expansion	N.I.C.	Not In Contract
A.C.T.	Acoustical Ceiling	E.J.	Expansion Joint	N.T.S.	Not To Scale
ADJ.	Adjacent	E.I.F.S.	Exterior Insulation & Finish System	O.C.	On Center
A.C.	Air Conditioning	F.R.P.	Fiberglass	O.H.	Overhead
ALTN.	Alternate	PR.	Reinforced	PAIR	Pair
ALUM.	Aluminum	PLYWD.	Plywood	PLAS. LAM.	Plastic Laminate
APPD.	Approved	P.V.C.	Polyester	PLYWD.	Plywood
APPROX.	Approximate	P.R.F.	Fire Rated	P.V.C.	Polyvinyl Chloride
ARCH.	Architectural	TREATED	Treated	PRE-FAB.	Prefabricated
ASPH.	Asphalt	F.F.	Finish Floor	P.T.	Pressure Treated
AUTO.	Automatic	F.E.	Fire Extinguisher	REINF.	Reinforcement
AVG.	Average	F.O.	Finished Opening	RM.	Room
BLK.	Block	FT.	Foot	S.A.T.	Suspended
BD.	Board	FTG.	Footing	SCHED.	Schedule
B.U.R.	Built-Up Roof	GA.	Gauge	SQ.	Square
C.B.	Catch Basin	G.C.	Gen. Contractor	SIM.	Similar
C.O.	Cleanout	GYP.	Gypsum	SQ.	Square
CLO.	Closet	H.V.A.C.	Heating, Ventilation & Air Conditioning	S.F.	Square Foot
C.W.	Cold Water	STL.	Steel	S.S.	Stainless Steel
COL.	Column	STR.	Structural	STL.	Storage
CONC.	Concrete	H.M.	Hollow Metal	STR.	Structural
C.M.U.	Concrete Masonry Unit	HORIZ.	Horizontal	TEL.	Telephone
CONT.	Continuous	H.W.	Hot Water	T&G	Tongue & Groove
CORR.	Corridor	HR.	Hour	TEL.	Telephone
COR.	Courses	IN.	Inch	T.O.	Top Of
DIA.	Diameter	INSUL.	Insulation or Insulated	T.G.	Top Of Grade
D.S.G.	Dick's Sporting Goods	INT.	Interior	T.O.S.	Top Of Steel
DR.	Door	JAN.	Janitor's Closet	TYP.	Typical
D.S.	Downspout	J.T.	Joint	UNFIN.	Unfinished
DWG.	Drawing	LAV.	Lavatory	U.N.O.	Unless Noted
D.F.	Drinking Fountain	M.D.F.	Medium Density Fiberboard	V.B.	Vapor Barrier
EA.	Each	M.H.	Manhole	VERT.	Vertical
E.W.	Each Way	MFGR.	Manufacturer	VEST.	Vestibule
ELEC.	Electrical	M.O.	Masonry Opening	V.C.T.	Vinyl Composition
EL.	Elevation	MAX.	Maximum	W.H.	Water Heater
ELEV.	Elevation	MECH.	Mechanical	W.W.F.	Welded Wire Fabric
EQUIP.	Equipment	MIN.	Minimum	W/	With
E.F.	Exhaust Fan	MISC.	Miscellaneous	W/O	Without
EXIST.	Existing	MTL.	Metal	WD.	Wood

DRAWING INDEX

REVISIONS	SHEET	DRAWING DESCRIPTION
		ARCHITECTURAL
		COVER SHEET
		OVERALL FLOOR PLAN
		LIFE SAFETY FLOORPLAN
		DEMOLITION FLOOR PLAN
		DEMOLITION CEILING PLAN
		FLOOR & BLOCKING PLAN
		FLOOR & BLOCKING DETAILS
		FINISH FLOOR PLAN & SCHEDULES
		REFLECTED CEILING PLAN
		FIXTURE PLAN - FOR REFERENCE ONLY
		INTERIOR ELEVATIONS
		INTERIOR ELEVATIONS
		MECHANICAL
		H.V.A.C. FLOOR PLANS
		ELECTRICAL
		ELECTRICAL DEMOLITION PLANS
		LIGHTING AND POWER PLANS
		LOW VOLTAGE AND SECURITY PLANS
		ELECTRICAL DETAILS, SCHEDULES, & NOTES
		PANEL SCHEDULES
		FIRE PREVENTION
		FIRE PREVENTION PLAN
		RACKING: BY OTHERS
		COVER SHEET
		SHELVING PLAN
		ENLARGED PLAN
		RIVETTER SHELVING, GENERAL NOTES, & DETAILS

NATIONAL VENDORS RESPONSIBILITY CHART

SOP CONTACTS:
DSG MANAGER OF ARCHITECTURAL SERVICES: MATTHEW JAROCK - MATTHEW.JAROCK@DCSG.COM (724) 273-5845
DSG DIRECTOR OF NON-MERCHANDISE PROCUREMENT: MALLORY GREENE - MALLORY.GREENE@DCSG.COM (724) 273-3169
DSG PROCUREMENT SPECIALIST: LHI TEAM - LHIPURCHASING@DCSG.COM

VENDOR #15: REFER TO STORE SPECIFIC VENDOR MATRIX FOR CONTACT NAME AND NUMBER.

Vendor Matrix

222 Keene, NH
Footwear Remodel
Fiscal Year: 02/2025
Issued: 02/25/25

Vendor	Scope of Work	Lead Time in Weeks	Purchased By	Installed By	Vendor Primary Contact
1 - Advanced Fixtures Inc.	Casework/Millwork, Slatwall/Plas. Lam. Panels/MDF Panels, Wall Louver	10	*	Vendor	Heather Ingram, 972-784-8800 x 225, dicksgm@advancedfixtures.com
2 - JCI / BA	Security	4	*	Vendor	DSG Support Team / Riley Vanbrocklin, 706-710-5605, bsdicksgsupport@jci.com, riley.vanbrocklin@jci.com
3 - Inside Edge	All Flooring Materials / Ceramic Tile / Wall Carpet	9	*	Vendor	Ron Myers, 651-389-4226, rmyers@iesdc.com
4 - Cook & Boardman Group	Hollow Metal Doors (Frames & Hardware, Cores, Keying), Filing Room Doors	6	*	G.C.	Lisa Steines, 855-447-8600, ext. 4517, dsig@cookandboardman.com
8 - ImageOne	Interior graphics, artwork, wall covering, overhead displays	8	*	Vendor	A.J. Roschio, (215) 826-0880 x1150, aroschio@11nd.com
13 - Level 10	Data / Telephone Wiring, Paging System / Trif-Sys. Speakers	15	*	Vendor	DSG Mailbox, 847-805-6055, dsig@level10.com
15 - Hy-Tek	Stockroom Shelving (including Conveyor System to Mezzanine when required), Dock Levelers / Dock Seals	15	*	Vendor	Matt Bommer, 216-208-8679, dsig-projects@hy-tek.com
18L - Reed Capitol Light	Lighting Fixtures	15	*	G.C.	Nathan Bernard, 614-771-7364, nathan.bernard@capitolight.com
19 - JCI / Sensormatic	CCTV, EAS	15	*	Vendor	Matthew Meade, 917-806-5838, matthew.meade@jci.com, Sensormatic, PMA, DSG@johnsoncontrols365.com@comcast.com


*When project is BTS, scope is purchased by Developer through GC; when RBTS, scope is purchased through DSG.
Please note: Lead Time is prototypical and may vary under current market conditions. Verify with vendors when project is awarded.
The information contained herein supersedes any information that may have been issued prior to this date and is subject to change.

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Page 1 of 1

SET BASED ON F-1 PLAN DATED 02/24/2025

WITH EXCEPTION OF THE NATIONAL ACCOUNT VENDORS THAT DSG IS PURCHASING DIRECTLY FROM AS NOTED ON THE VENDOR MATRIX, ALL WORK, MATERIALS, AND SYSTEMS SHOWN IN THESE PLANS AND SPECIFICATIONS IS THE SOLE RESPONSIBILITY OF THE GENERAL CONTRACTOR TO PURCHASE AND INSTALL COMPLETE AS SHOWN AND REFERENCED. THE GENERAL CONTRACTOR IS REQUIRED TO COORDINATE, SCHEDULE AND SUPERVISE ALL NATIONAL ACCOUNT VENDORS AS WELL AS THEIR SUBCONTRACTORS. THE TENANT (DICK'S SPORTING GOODS) HAS NO SCOPE OF WORK AND/OR RESPONSIBILITY SHOWN IN THESE PLANS AND/OR SPECIFICATIONS.

AREA PLAN

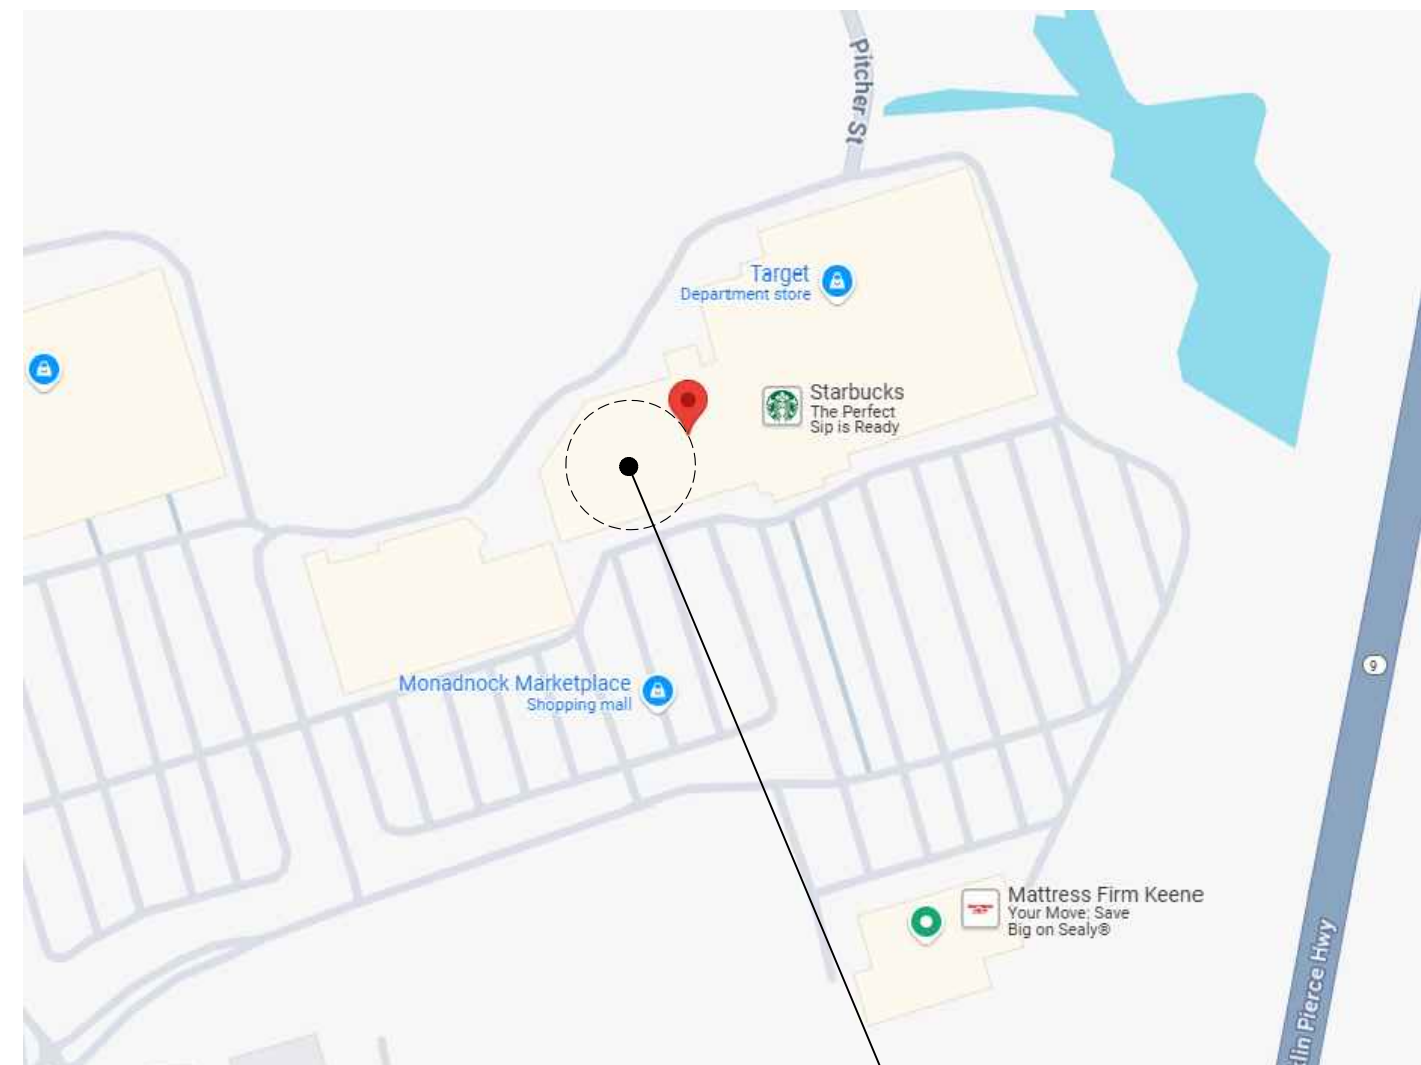

SITE MAP



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Date: 03-28-25 Issue: Issued for Bid-Permit

Drawn By: MCG

Project No.: 25061.10

STORE # 222

SPORTING GOODS

SET BASED ON F-1 PLAN DATED 02/24/2025

222 Keene, NH

Footwear Remodel
Fiscal Year: 02/2025
Issued: 02/25/25

Vendor	Scope of Work	Lead Time in Weeks	Purchased By	Installed By	Vendor Primary Contact
1 - Advanced Fixtures Inc.	Casework/Millwork, Slatwall/Plas. Lam. Panels/MDF Panels, Wall Louver	10	*	Vendor	Heather Ingram, 972-784-8800 x 225, dicksgm@advancedfixtures.com
2 - JCI / BA	Security	4	*	Vendor	DSG Support Team / Riley Vanbrocklin, 706-710-5605, bsdicksgsupport@jci.com, riley.vanbrocklin@jci.com
3 - Inside Edge	All Flooring Materials / Ceramic Tile / Wall Carpet	9	*	Vendor	Ron Myers, 651-389-4226, rmyers@iesdc.com
4 - Cook & Boardman Group	Hollow Metal Doors (Frames & Hardware, Cores, Keying), Filing Room Doors	6	*	G.C.	Lisa Steines, 855-447-8600, ext. 4517, dsig@cookandboardman.com
8 - ImageOne	Interior graphics, artwork, wall covering, overhead displays	8	*	Vendor	A.J. Roschio, (215) 826-0880 x1150, aroschio@11nd.com
13 - Level 10	Data / Telephone Wiring, Paging System / Trif-Sys. Speakers	15	*	Vendor	DSG Mailbox, 847-805-6055, dsig@level10.com
15 - Hy-Tek	Stockroom Shelving (including Conveyor System to Mezzanine when required), Dock Levelers / Dock Seals	15	*	Vendor	Matt Bommer, 216-208-8679, dsig-projects@hy-tek.com
18L - Reed Capitol Light	Lighting Fixtures	15	*	G.C.	Nathan Bernard, 614-771-7364, nathan.bernard@capitolight.com
19 - JCI / Sensormatic	CCTV, EAS	15	*	Vendor	Matthew Meade, 917-806-5838, matthew.meade@jci.com, Sensormatic, PMA, DSG@johnsoncontrols365.com@comcast.com

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Page 1 of 1



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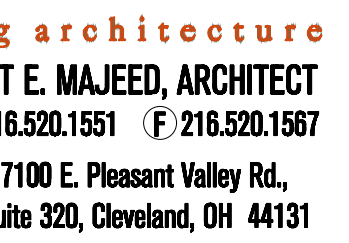
COVER SHEET

T1.0

	Issue
8-25	Issued for Bid-Permit


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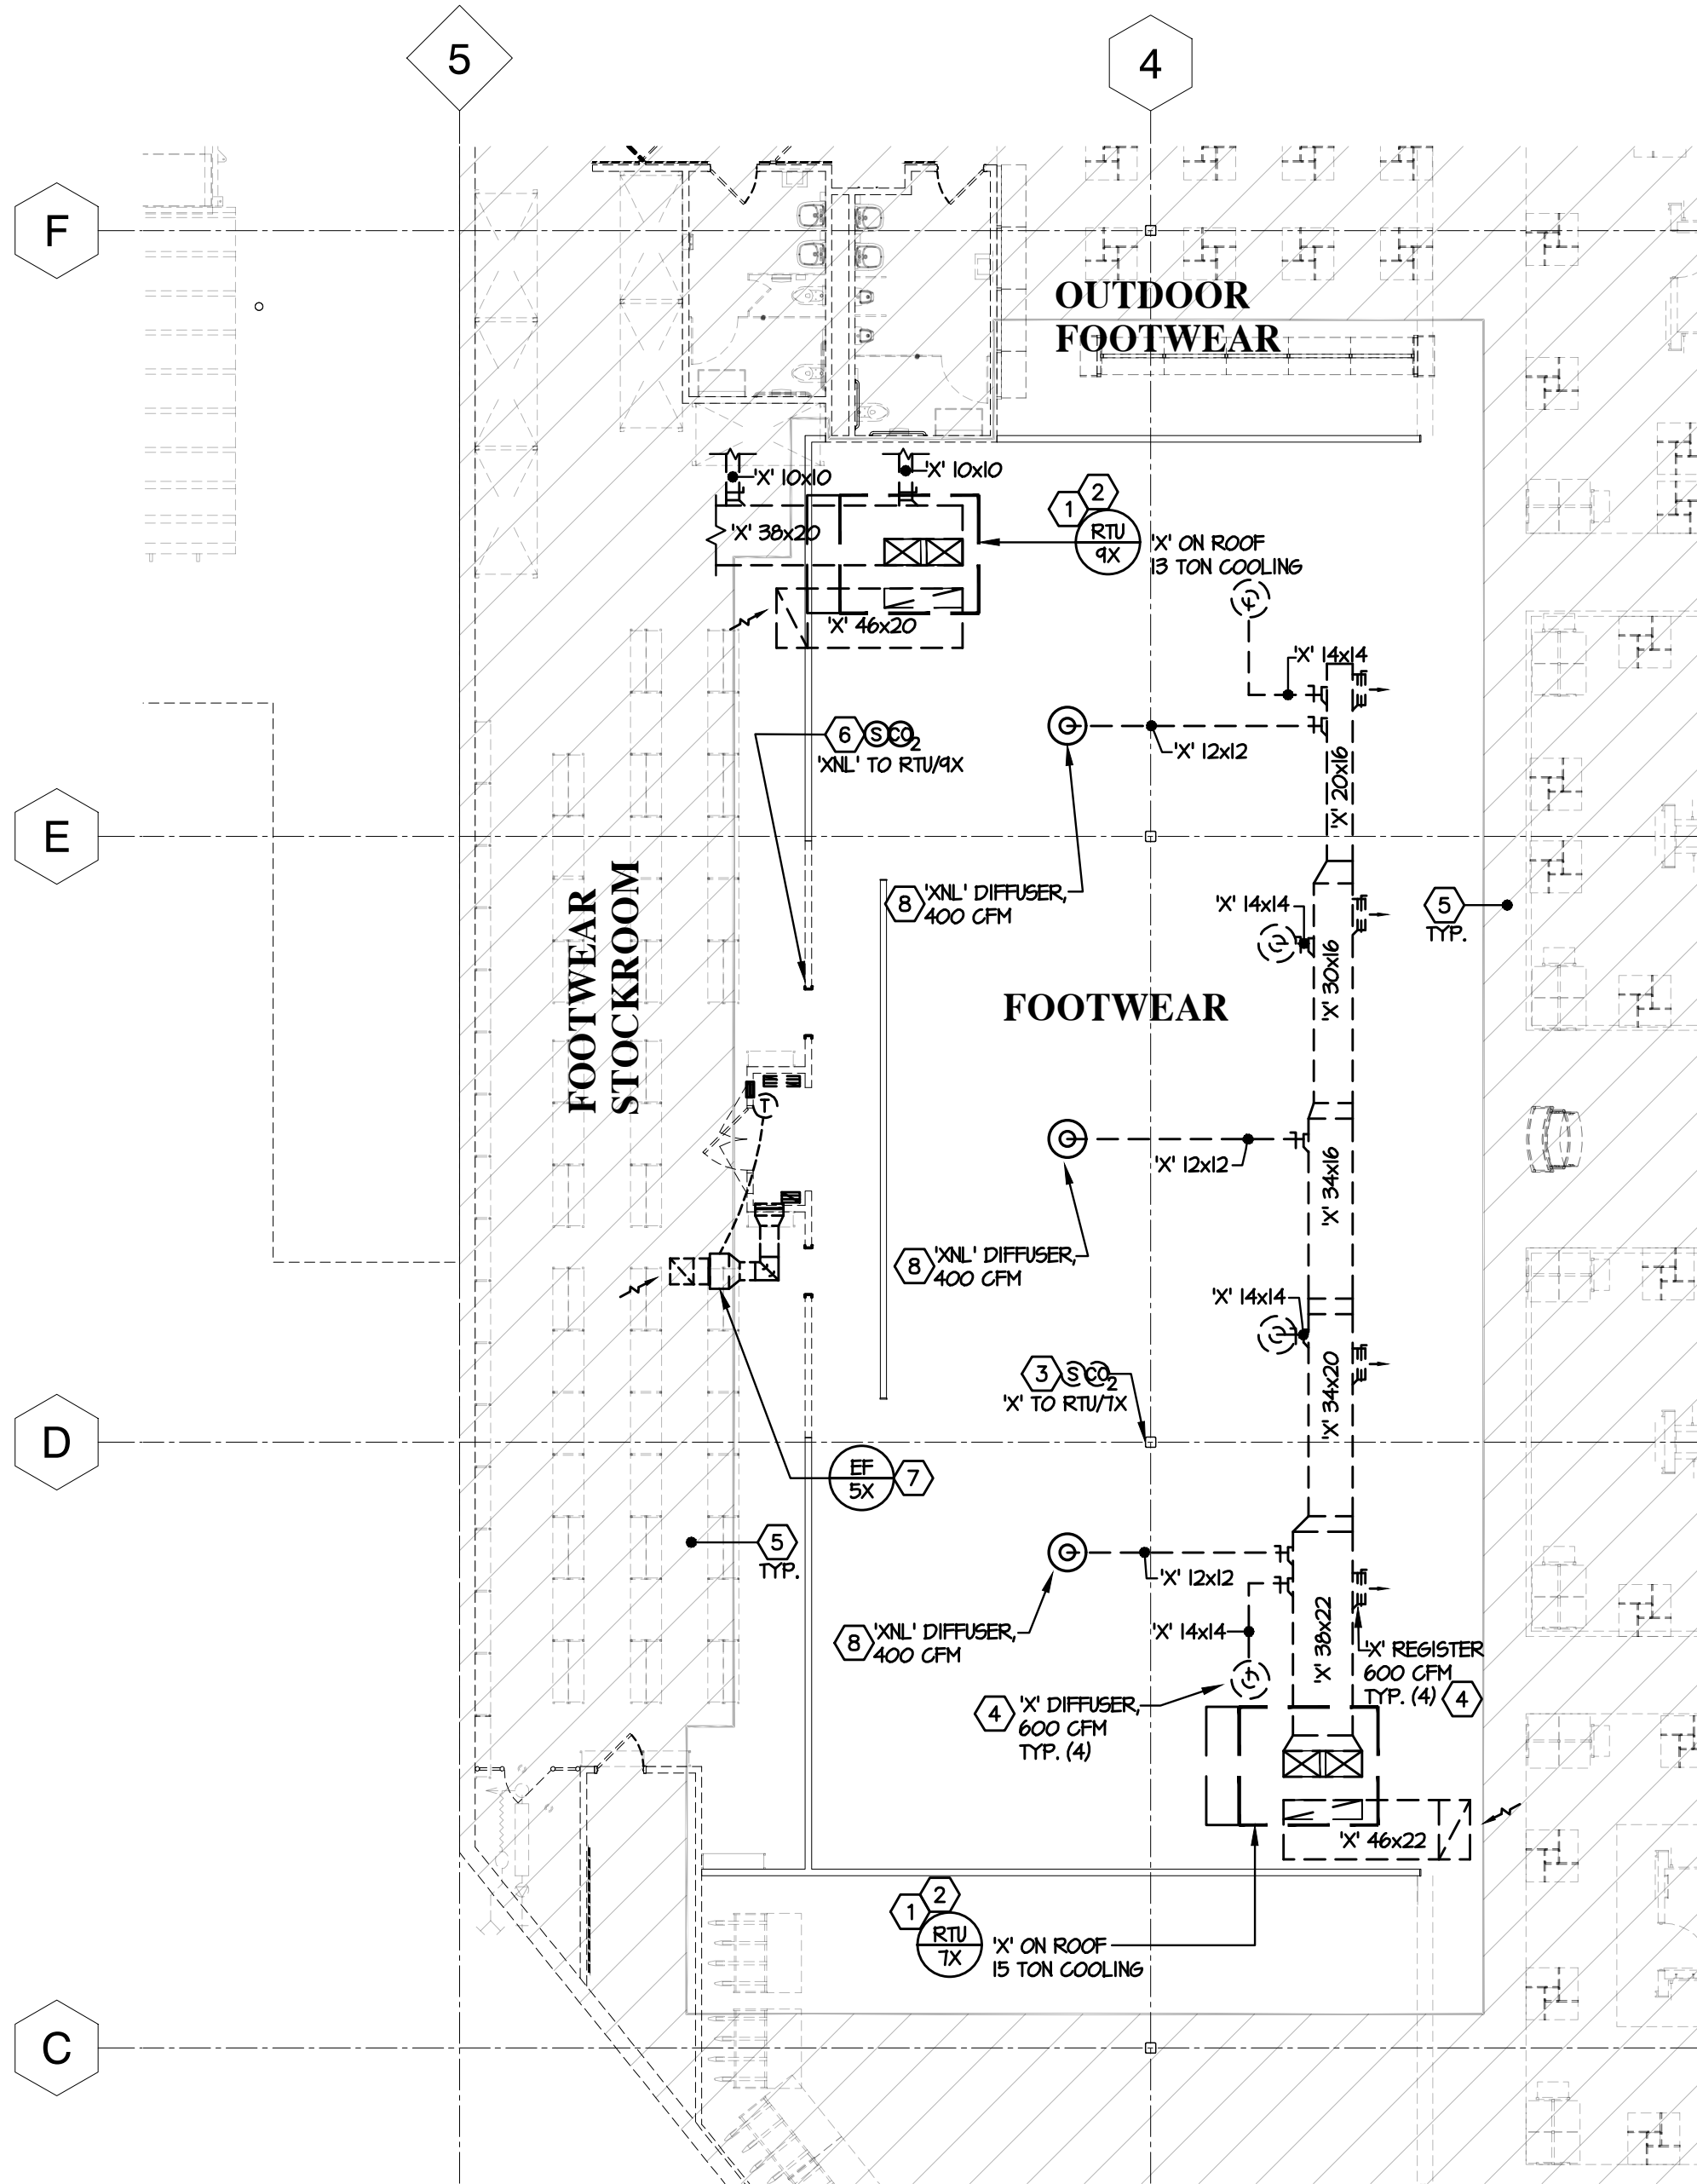
DICK'S
MONADNOCK MARKETPLACE
42 ASH BROOK ROAD
KEENE, NH 03431



OVERALL FLOOR

OVERALL FLOOR
PLAN
T2.0



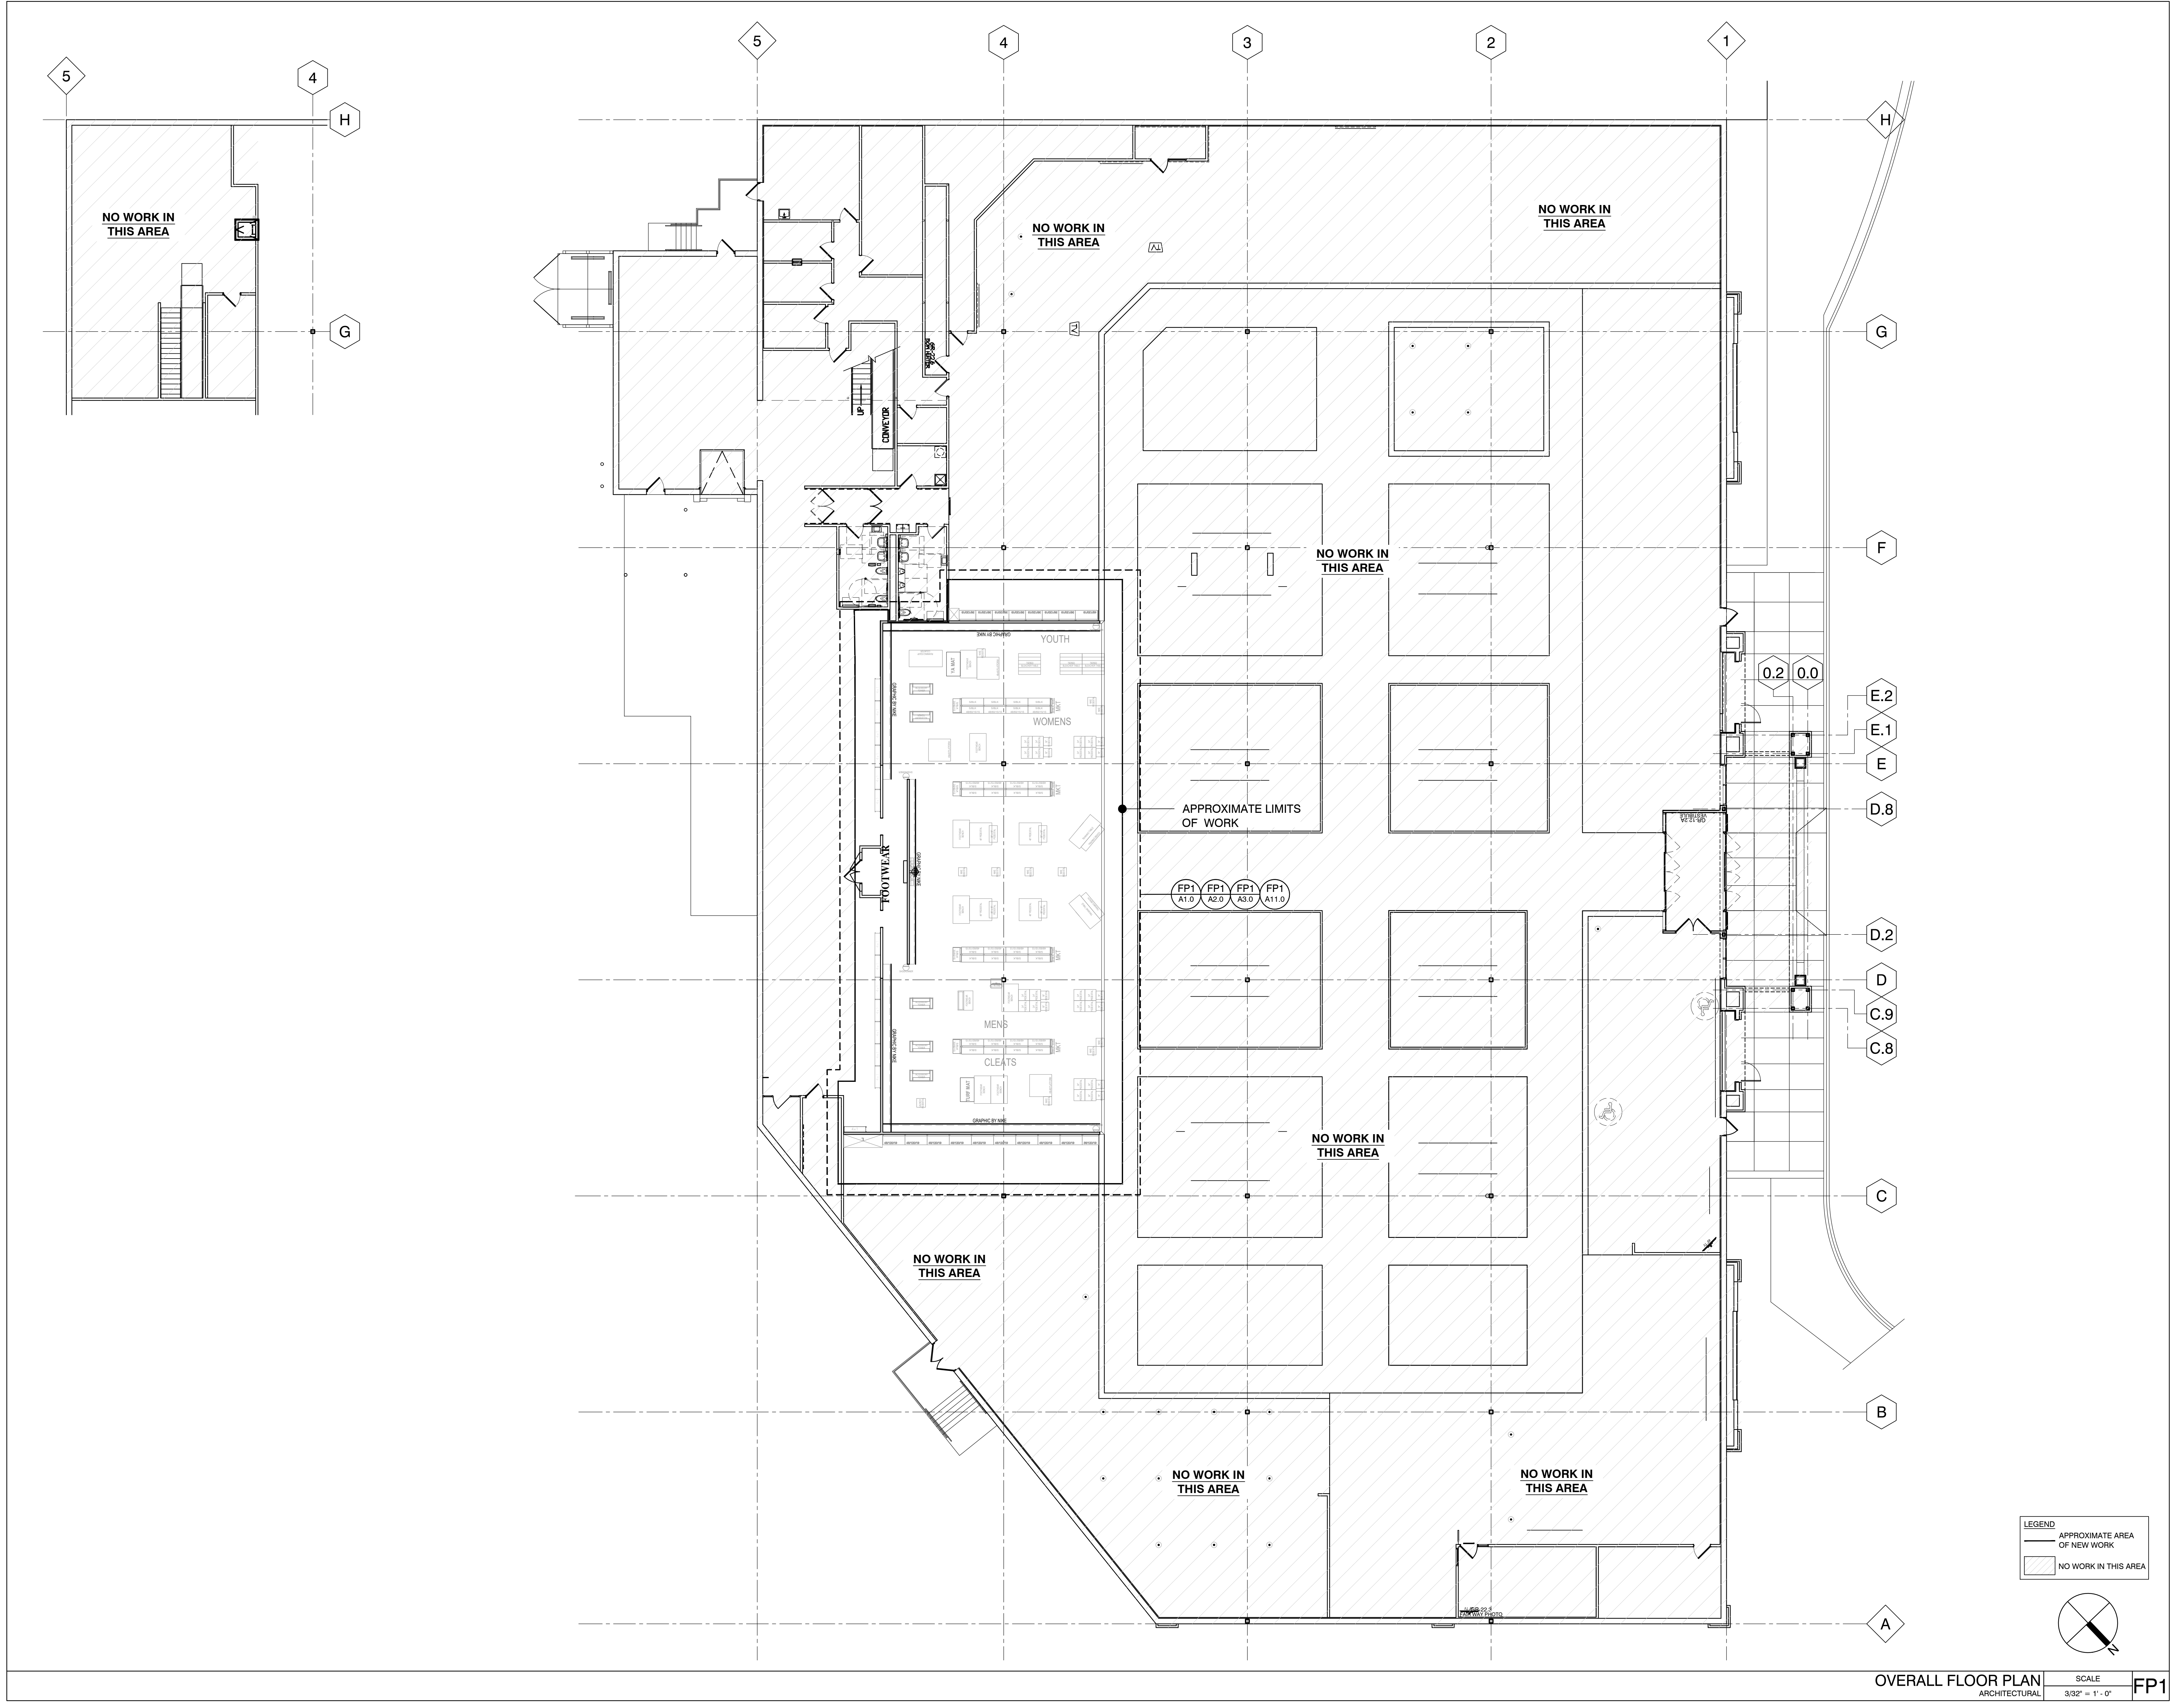

1 | H.V.A.C. FLOOR PLAN
SCALE: 3/32" = 1'-0"

DIFFUSER / GRILLE SCHEDULE											
MARK	MANUFACTURER # & MODEL	CFM	NECK SIZE	FRAME TYPE	FACE TYPE	PATTERN	DAMPER	MATERIAL	SERVICE	FINISH	NOTES
SR-1	TITUS 300-RL	AS NOTED	AS NOTED	SURFACE	HORIZ. BAR	DOUBLE DEFLECTION	YES	STEEL	SUPPLY	OFF-WHITE	1
6-1	TITUS 350-RL	AS NOTED	AS NOTED	SURFACE	HORIZ. BAR	NA	NO	STEEL	TRANSFER	OFF-WHITE	1

NOTES:


1. DIFFUSER DESIGNATIONS ON PLANS AS FOLLOWS:

GRILLE, REGISTER, OR
DIFFUSER TYPE
AS NOTED ABOVE

AIR QUANTITY

6-1, 12x12
400 CFM

DIFFUSER NECK SIZE
OR GRILLE REGISTER
SIZE.

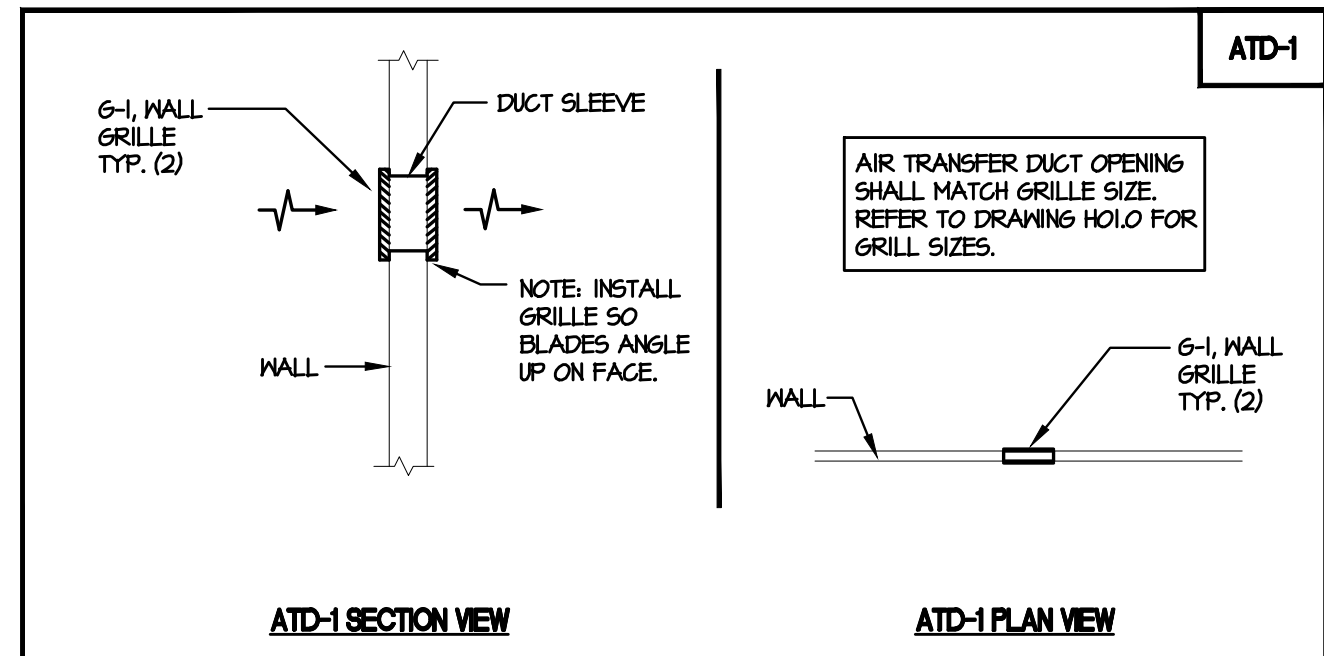


- NOTES FOR ALL AIR TRANSFER DUCTS:
- SEAL VOID BETWEEN WALL AND ALL DUCT PENETRATIONS AIRTIGHT.
 - ACOUSTIC LINE AIR TRANSFER DUCTS WITH 1/2" ACOUSTIC LINING.
 - DUCT DIMENSIONS ARE EXTERIOR AND INCLUDE LINING.
 - ALL GRILLES SHALL BE FURNISHED WITH FRAMES COMPATIBLE WITH WALL OR CEILING CONSTRUCTION.
 - REFER TO MECHANICAL FLOOR PLANS FOR MOUNTING HEIGHTS OF ALL WALL MOUNTED GRILLES.
 - WHEN GRILLE IS ABOVE 10'-0" AFF. INSTALL GRILLE 50 BLADES ANGLE UP ON FACE.
 - ALL GRILLES ON SALES FLOOR SHALL BE INSTALLED ABOVE PAINT BREAK LINE UNLESS INDICATED OTHERWISE ON FLOOR PLAN.

2 | AIR TRANSFER DUCT DETAILS
SCALE: NONE

ELBOW WITH AFFOL TURNING VANES	ACOUSTIC LINED DUCT (NOTE R)	DOUBLE SINGLE
BRANCH TAKE-OFF RECTANGULAR TO RECTANGULAR	BRANCH TAKE-OFF RECTANGULAR TO ROUND	45° H.V.D.
BRANCH TAKE-OFF ROUND TO ROUND	SQUARE TO ROUND TRANSITION FITTING	90°
PROPORTION SPLIT	FLEXIBLE DUCT	BRANCH DUCT TO DIFFUSER MAX. LENGTH = 48"
MANUAL VOLUME DAMPER (MVD)	NOTES: 1. DASHED LINE INDICATES 1" INTERIOR ACOUSTIC LINING UNLESS OTHERWISE NOTED. DUCT SIZE IS EXTERIOR AND INCLUDES LINING.	

3 | TYPICAL DUCT TAKE-OFF DETAIL
SCALE: NONE

- CODED NOTES:
- MAINTAIN EXISTING SMOKE DETECTOR IN RETURN AIR DUCT TO SHUT DOWN RTU UPON ALARM.
 - NEW BRANCH DUCT IN JOIST SPACE - SEE PLAN FOR LOCATION AND SIZE.
 - MODIFY EXISTING SUPPLY AIR DUCT DROP AND INSTALL MANUAL BALANCING DAMPER WITH LOCKING QUADRANT SIZED TO MATCH DUCT.
 - EXISTING CONCENTRIC DIFFUSER. BALANCE TO NEW SUPPLY AIR QUANTITY INDICATED ON H.V.A.C. FLOOR PLAN.

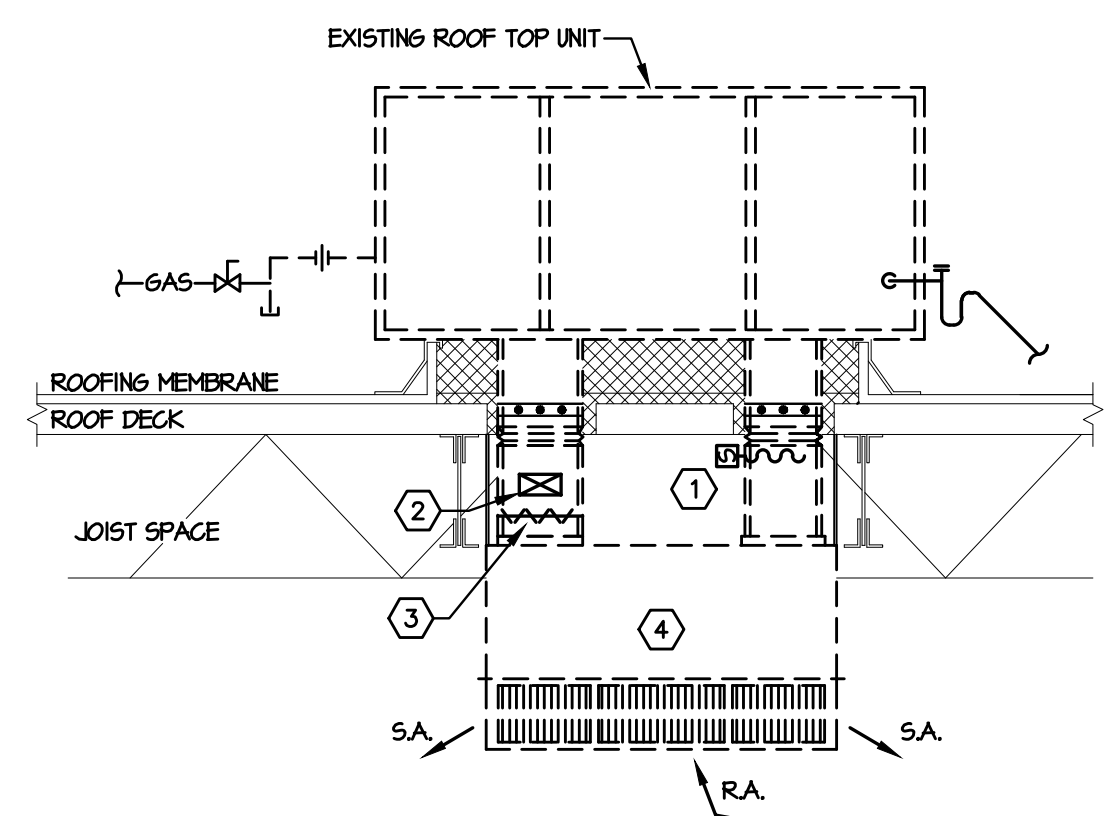

4 | ROOFTOP AIR CONDITIONING UNIT DETAIL
SCALE: NONE

H.V.A.C. GENERAL NOTES:

- CONTRACTOR SHALL VISIT SITE PRIOR TO BIDDING PROCESS AND FIELD VERIFY EXISTING CONDITIONS. CONTRACTOR SHALL TAKE ALL INTERFERENCES INTO CONSIDERATION. PROVIDE ALL NECESSARY OFFSETS OR TRANSITIONS WITH EQUIVALENT AREAS TO MATCH DUCT SIZES AS INDICATED ON DRAWINGS.
- CONTRACTOR SHALL OBTAIN AND PAY FOR ALL PERMITS, LICENSES, DOCUMENTS AND SERVICES RELATED TO INSTALLATION OF THE WORK.
- CONTRACTOR IS RESPONSIBLE TO AND SHALL PERFORM ALL WORK IN ACCORDANCE WITH THE LATEST STATE CODES, TOWNHIPS, AND NFPA, O.S.H.A., AND THE RULES AND REGULATIONS OF ALL CITY, STATE, AND FEDERAL AUTHORITIES HAVING JURISDICTION. PROVIDE OWNER WITH CERTIFICATES OF INSPECTION.
- CONTRACTOR SHALL BE LICENSED, TRAINED AND CERTIFIED IN THE PROPER INSTALLATION OF MECHANICAL SYSTEMS, INCLUDING DUCTS, PIPING AND EQUIPMENT. UNLICENSED PERSONS MAY NOT PERFORM MECHANICAL INSTALLATIONS ONLY WHEN UNDER DIRECT SUPERVISION AND RESPONSIBILITY OF A CERTIFIED INSTALLER OR LICENSED CONTRACTOR. VERIFICATION OF CERTIFICATION AND LICENSES ARE REQUIRED.
- THESE DRAWINGS INDICATE THE SIZE AND GENERAL LOCATION OF WORK. SCALED DIMENSIONS SHALL NOT BE USED. ANY DIMENSIONS NOT SHOWN SHALL BE OBTAINED FROM THE ARCHITECTURAL DRAWINGS. FOR EXACT LOCATIONS, HEIGHTS, MOUNTING HEIGHTS, ETC. REFER TO ARCHITECTURAL DRAWINGS AND DETAILS.
- PRIOR TO STARTING ANY WORK, PURCHASE OF EQUIPMENT, ETC. COORDINATE THE WORK WITH OTHER TRADES. COOPERATE WITH OTHER CONTRACTORS WHOSE WORK MIGHT AFFECT THIS INSTALLATION AND ARRANGE ALL PARTS OF THIS WORK AND EQUIPMENT OF OTHERS, WITH THE BUILDING CONSTRUCTION AND WITH ARCHITECTURAL FINISH.
- CONTRACTOR SHALL GUARANTEE ALL WORK AND MATERIALS FOR ONE YEAR, EFFECTIVE THE DAY THE PROJECT IS ACCEPTED BY THE OWNER.
- DO ALL NECESSARY CUTTING AND ROUGH PATCHING. FINISH PAINTING, FINISH PATCHING AND POWER WIRING IS BY OTHERS.
- REFER TO ARCHITECTURAL REFLECTED CEILING PLAN FOR EXACT LOCATION OF ALL MECHANICAL CEILING EQUIPMENT.
- HVAC DUCTWORK SHALL BE FABRICATED AND ERECTED IN ACCORDANCE WITH ASHRAE AND LATEST SMACNA STANDARDS. PROVIDE TURNING VANES IN ALL ELBOWS. DUCTWORK SHALL HAVE A MINIMUM PRESSURE CLASSIFICATION OF 2" SEAL CLASS 6, WITH A MAXIMUM LEAKAGE RATE OF 3%.
- PROVIDE A MANUAL BALANCING DAMPER AT ALL SUPPLY AND RETURN BRANCH TAKEOFFS, IN ACCESSIBLE LOCATION OR WITH ACCESS DOOR.
- DUCTWORK DIMENSIONS NOTED ON DRAWINGS ARE EXTERIOR DIMENSIONS AND INCLUDE LINING.
- INSTALL BOTTOM OF HORIZONTAL, EXPOSED DUCTWORK IN SALES AREAS AND STOCK ROOMS UP WITH-IN IN JOIST SPACE TO MAINTAIN MAXIMUM CLEARANCE.
- THE BALANCING CONTRACTOR SHALL BALANCE AIR FLOW QUANTITIES TO WITHIN 3% OF THE DESIGN CONDITIONS LISTED ON PLANS. THIS CONTRACTOR SHALL INCLUDE ONE (1) ADDITIONAL SET OF BELTS AND SHEAVES AND REBALANCING FOR EACH SYSTEM FOR THE PROJECT. ALL OF THE ABOVE WORK SHALL BE AT NO ADDITIONAL COST TO THE OWNER.
- ALL PIPING, DUCTS, VENTS, ETC., EXTENDING THROUGH WALLS AND ROOF SHALL BE FLASHED AND COUNTER-FLASHED IN A WATERPROOF MANNER.
- SPRINKLER CONTRACTOR SHALL COORDINATE INSTALLATION OF SPRINKLER PIPING WITH DUCTWORK, LIGHTS, AND PARTITION LAYOUT. LIGHTS ARE NOT TO BE MOVED; SPRINKLER PIPING SHALL BE ROUTED AROUND LIGHTS AS REQUIRED.
- MECHANICAL CONTRACTOR SHALL PERFORM ROUTINE SERVICE INSPECTION OF EXISTING ROOFTOP UNIT TO BE REUSED FOR THIS PROJECT. LUBRICATE BEARINGS, SERVICE CONTROL SYSTEMS, REPLACE FAN BELTS AS REQUIRED, CLEAN AND COND EVAPORATOR AND CONDENSER COILS, CLEAN CONDENSATE DRAIN AND PAN AND INSTALL NEW FILTERS AFTER COMPLETION OF CONSTRUCTION. ADD REFRIGERANT AS REQUIRED TO MEET MANUFACTURER'S RECOMMENDED OPERATING CHARGE. EQUIPMENT SHALL BE PLACED IN FULL OPERATION WITH CONTROLS CALIBRATED UPON COMPLETION OF PROJECT. SUBMIT A WRITTEN REPORT TO OWNER OF ANY MAJOR COMPONENT FAILURES OR ANTICIPATED COMPONENT FAILURES. REPORT SHALL INCLUDE COST INCLUDING LABOR TO SERVICE ALL ITEMS NOT OTHERWISE LISTED ABOVE.
- CONTRACTORS BIDDING THIS PROJECT SHALL HAVE PRIOR EXPERIENCE WORKING IN THIS JURISDICTION AND MUST LIST ON BID FORM ANY LOCAL REQUIREMENTS THAT ARE NOT SHOWN ON THE DRAWINGS. SUBMISSION OF A BID SHALL BE EVIDENCE THAT THE CONTRACTOR'S BID INCLUDES ALL JURISDICTIONAL REQUIREMENTS.
- THIS CONTRACTOR SHALL COMPLETE ALL DEMOLITION OF EXISTING MECHANICAL SYSTEMS AS INDICATED ON MECHANICAL AND ARCHITECTURAL PLANS OR AS NECESSARY FOR THE PROJECT. REMOVE FROM SITE AND DISPOSE OF ALL MATERIAL AND DEBRIS FROM THIS WORK IN A CODE AND EPA APPROVED MANNER.
- CONTRACTOR SHALL TAKE NOTE THAT NOT ALL NEW WORK CAN BE PERFORMED AT ONE TIME. CONTRACTOR SHALL COORDINATE ALL NEW WORK WITH STORE PHASING CONSTRUCTION PLAN. REFER TO ARCHITECTURAL PLANS.

H.V.A.C. CODED NOTES:

- CONTRACTOR SHALL PERFORM ROUTINE SERVICE INSPECTION OF EXISTING ROOFTOP UNIT TO BE REUSED FOR THIS PROJECT. LUBRICATE BEARINGS, SERVICE CONTROL SYSTEMS, REPLACE FAN BELTS AS REQUIRED, CLEAN AND COND EVAPORATOR AND CONDENSER COILS, CLEAN CONDENSATE DRAIN AND PAN AND INSTALL NEW FILTERS AFTER COMPLETION OF CONSTRUCTION. ADD REFRIGERANT AS REQUIRED TO MEET MANUFACTURER'S RECOMMENDED OPERATING CHARGE. EQUIPMENT SHALL BE PLACED IN FULL OPERATION WITH CONTROLS CALIBRATED UPON COMPLETION OF PROJECT. SUBMIT A WRITTEN REPORT TO OWNER OF ANY MAJOR COMPONENT FAILURES OR ANTICIPATED COMPONENT FAILURES. REPORT SHALL INCLUDE COST INCLUDING LABOR TO SERVICE ALL ITEMS NOT OTHERWISE LISTED ABOVE.
- EXISTING DUCT SMOKE DETECTOR(S) TO REMAIN TO SHUT DOWN ROOFTOP UNIT UPON ALARM.
- EXISTING TEMPERATURE AND CARBON DIOXIDE SENSORS TO REMAIN. CALIBRATE SENSORS ONCE WORK IS COMPLETE.
- CLEAN EXISTING DIFFUSER AND DUCTWORK FOR NEW PAINT. BALANCE DIFFUSER TO CFM INDICATED.
- NO H.V.A.C. WORK DONE IN HATCHED AREA.
- EXISTING TEMPERATURE AND CARBON DIOXIDE SENSOR SHOWN IN NEW LOCATION. ELECTRICAL CONTRACTOR SHALL INSTALL AND WIRE. INSTALL SENSOR AT HEIGHT TO MATCH EXISTING. CALIBRATE SENSORS ONCE WORK IS COMPLETE.
- EXISTING EXHAUST FAN, AIR DISTRIBUTION, AND CONTROLS TO REMAIN. CONTRACTOR SHALL PERFORM ROUTINE SERVICE INSPECTION OF EXISTING FAN TO BE REUSED FOR THIS PROJECT. LUBRICATE BEARINGS, SERVICE CONTROL SYSTEMS, AND REPLACE FAN BELTS AS REQUIRED. FANS SHALL BE PLACED IN FULL OPERATION WITH CONTROLS CALIBRATED UPON COMPLETION OF PROJECT. SUBMIT A WRITTEN REPORT TO OWNER OF ANY MAJOR COMPONENT FAILURES OR ANTICIPATED COMPONENT FAILURES. REPORT SHALL INCLUDE COST INCLUDING LABOR TO SERVICE ALL ITEMS NOT OTHERWISE LISTED ABOVE.
- EXISTING DIFFUSER SHOWN IN NEW LOCATION. CLEAN AND PAINT DIFFUSER PRIOR TO INSTALLATION. BALANCE DIFFUSER TO CFM INDICATED.

AFF	ABOVE FINISHED FLOOR
ATD	AIR TRANSFER DUCT
B'	BOTTOM OF
CD	CEILING DIFFUSER
CFM	CUBIC FEET PER MINUTE
CONN.	CONNECT / CONNECTION
CORR.	CORRIDOR
CUH	CABINET UNIT HEATER
DIA	DIAMETER
DES	DEGRESS
DLPD	DRUM LOWER PLENUM DIFFUSER SYSTEM
DWG	DRAWING
ENA	EXHAUST AIR
EER	ENERGY EFFICIENCY RATIO
EF	EXHAUST FAN
EFF.	EFFICIENCY
E.S.P.	EXTERNAL STATIC PRESSURE
EXH.	EXHAUST
G	GRILLE
HP	HORSE POWER
HTG	HEATING
KW	KILOWATTS
LD	LINEAR DIFFUSER
MEH	THOUSAND BTU/HOUR
MVD	MANUAL VOLUME DAMPER
OA	OUTSIDE AIR
OP. INT.	OPERABLE HEIGHT
PRESS.	PRESSURE
RA	RETURN AIR
RO	ROOF OPENING
RTU	ROOFTOP UNIT
SA	SUPPLY AIR
SP	STATIC PRESSURE
SR	SUPPLY REGISTER
T'	TOP OF
TSTAT	THERMOSTAT
TYP.	TYPICAL
UH	UNIT HEATER
UL	UNDERWRITER'S LABORATORY
GC	GENERAL CONTRACTOR
FFC	FIRE PROTECTION CONTRACTOR
PC	PLUMBING CONTRACTOR
MC	MECHANICAL CONTRACTOR
EC	ELECTRICAL CONTRACTOR

---	6-	LOW PRESSURE GAS PIPING
---	RPS-2#	REGULATED 2 PSI GAS PIPING
X' OR	---	EXISTING TO REMAIN
XR' OR	---	EXISTING TO BE REMOVED
XX' OR	---	EXISTING TO BE ABANDONED IN PLACE
XXR' OR	---	EXISTING TO BE RELOCATED
XXL' OR	---	EXISTING, RELOCATED, SHOWN IN NEW LOCATION
2		CO-2 SENSOR TO BE FURNISHED BY MC. INSTALLED AND WIRED BY EC.
2H		NOVAR GLOBAL HUMIDITY SENSOR. REFER TO ELECTRICAL DWG6 FOR DETAILS.
2H		LENNOX HUMIDITY SENSOR. REFER TO ELECTRICAL DWG6 FOR DETAILS.
2H		NOVAR INDOOR TEMPERATURE SENSOR. REFER TO ELECTRICAL DWG6 FOR DETAILS.
2H		NOVAR TEMPERATURE SENSOR. REFER TO ELECTRICAL DWG6 FOR DETAILS.
2H		THERMOSTAT, FURNISHED BY MC. INSTALLED AND WIRED BY EC.
2H		COMBINATION TEMPERATURE/RELATIVE HUMIDITY/CARBON DIOXIDE SENSOR FURNISHED BY MC. INSTALLED AND WIRED BY VENDOR 16.
2H		INDICATES CODED NOTE
2H		MOTORIZED DAMPER, 120 VOLT
2H		1L' LISTED FIRE DAMPER WITH DUCT ACCESS DOOR
2H		DUCT SMOKE DETECTOR TO SHUT DOWN UNIT UNDER ALARM. DETECTOR SHALL BE LOCATED, INSTALLED AND WIRED AS INDICATED ON FLOOR PLAN AND SPECIFICATIONS. ALL WIRING TO BE IN CONDUIT PER NEC.
2H		UNDERCUT DOOR, REFER TO ARCHITECTURAL DRAWINGS.
2H		EQUIPMENT TAG
2H		ONE (1) HOUR TIMER MATH SWITCH, FURNISHED BY MC. INSTALLED AND WIRED BY EC.

5 | H.V.A.C. LEGEND

SCALE: NONE

CONTRACTOR MUST VERIFY ALL CLEARANCES AND DIMENSIONS IN FIELD

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Date: 03-28-25
Issue: Issued for Bid-Permit

PROGRESS SET
DATE: 03-21-25

Drawn By: MM

Project No.: 25061-10

STORE # 222


DICK'S SPORTING GOODS

DICK'S
MONADNOCK MARKETPLACE
42 ASH BROOK ROAD
KEENE, NH 03431

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H.V.A.C.
FLOOR PLAN
H1.0



1 | H.V.A.C. DEMOLITION FLOOR PLAN
SCALE: 3/32" = 1'-0"

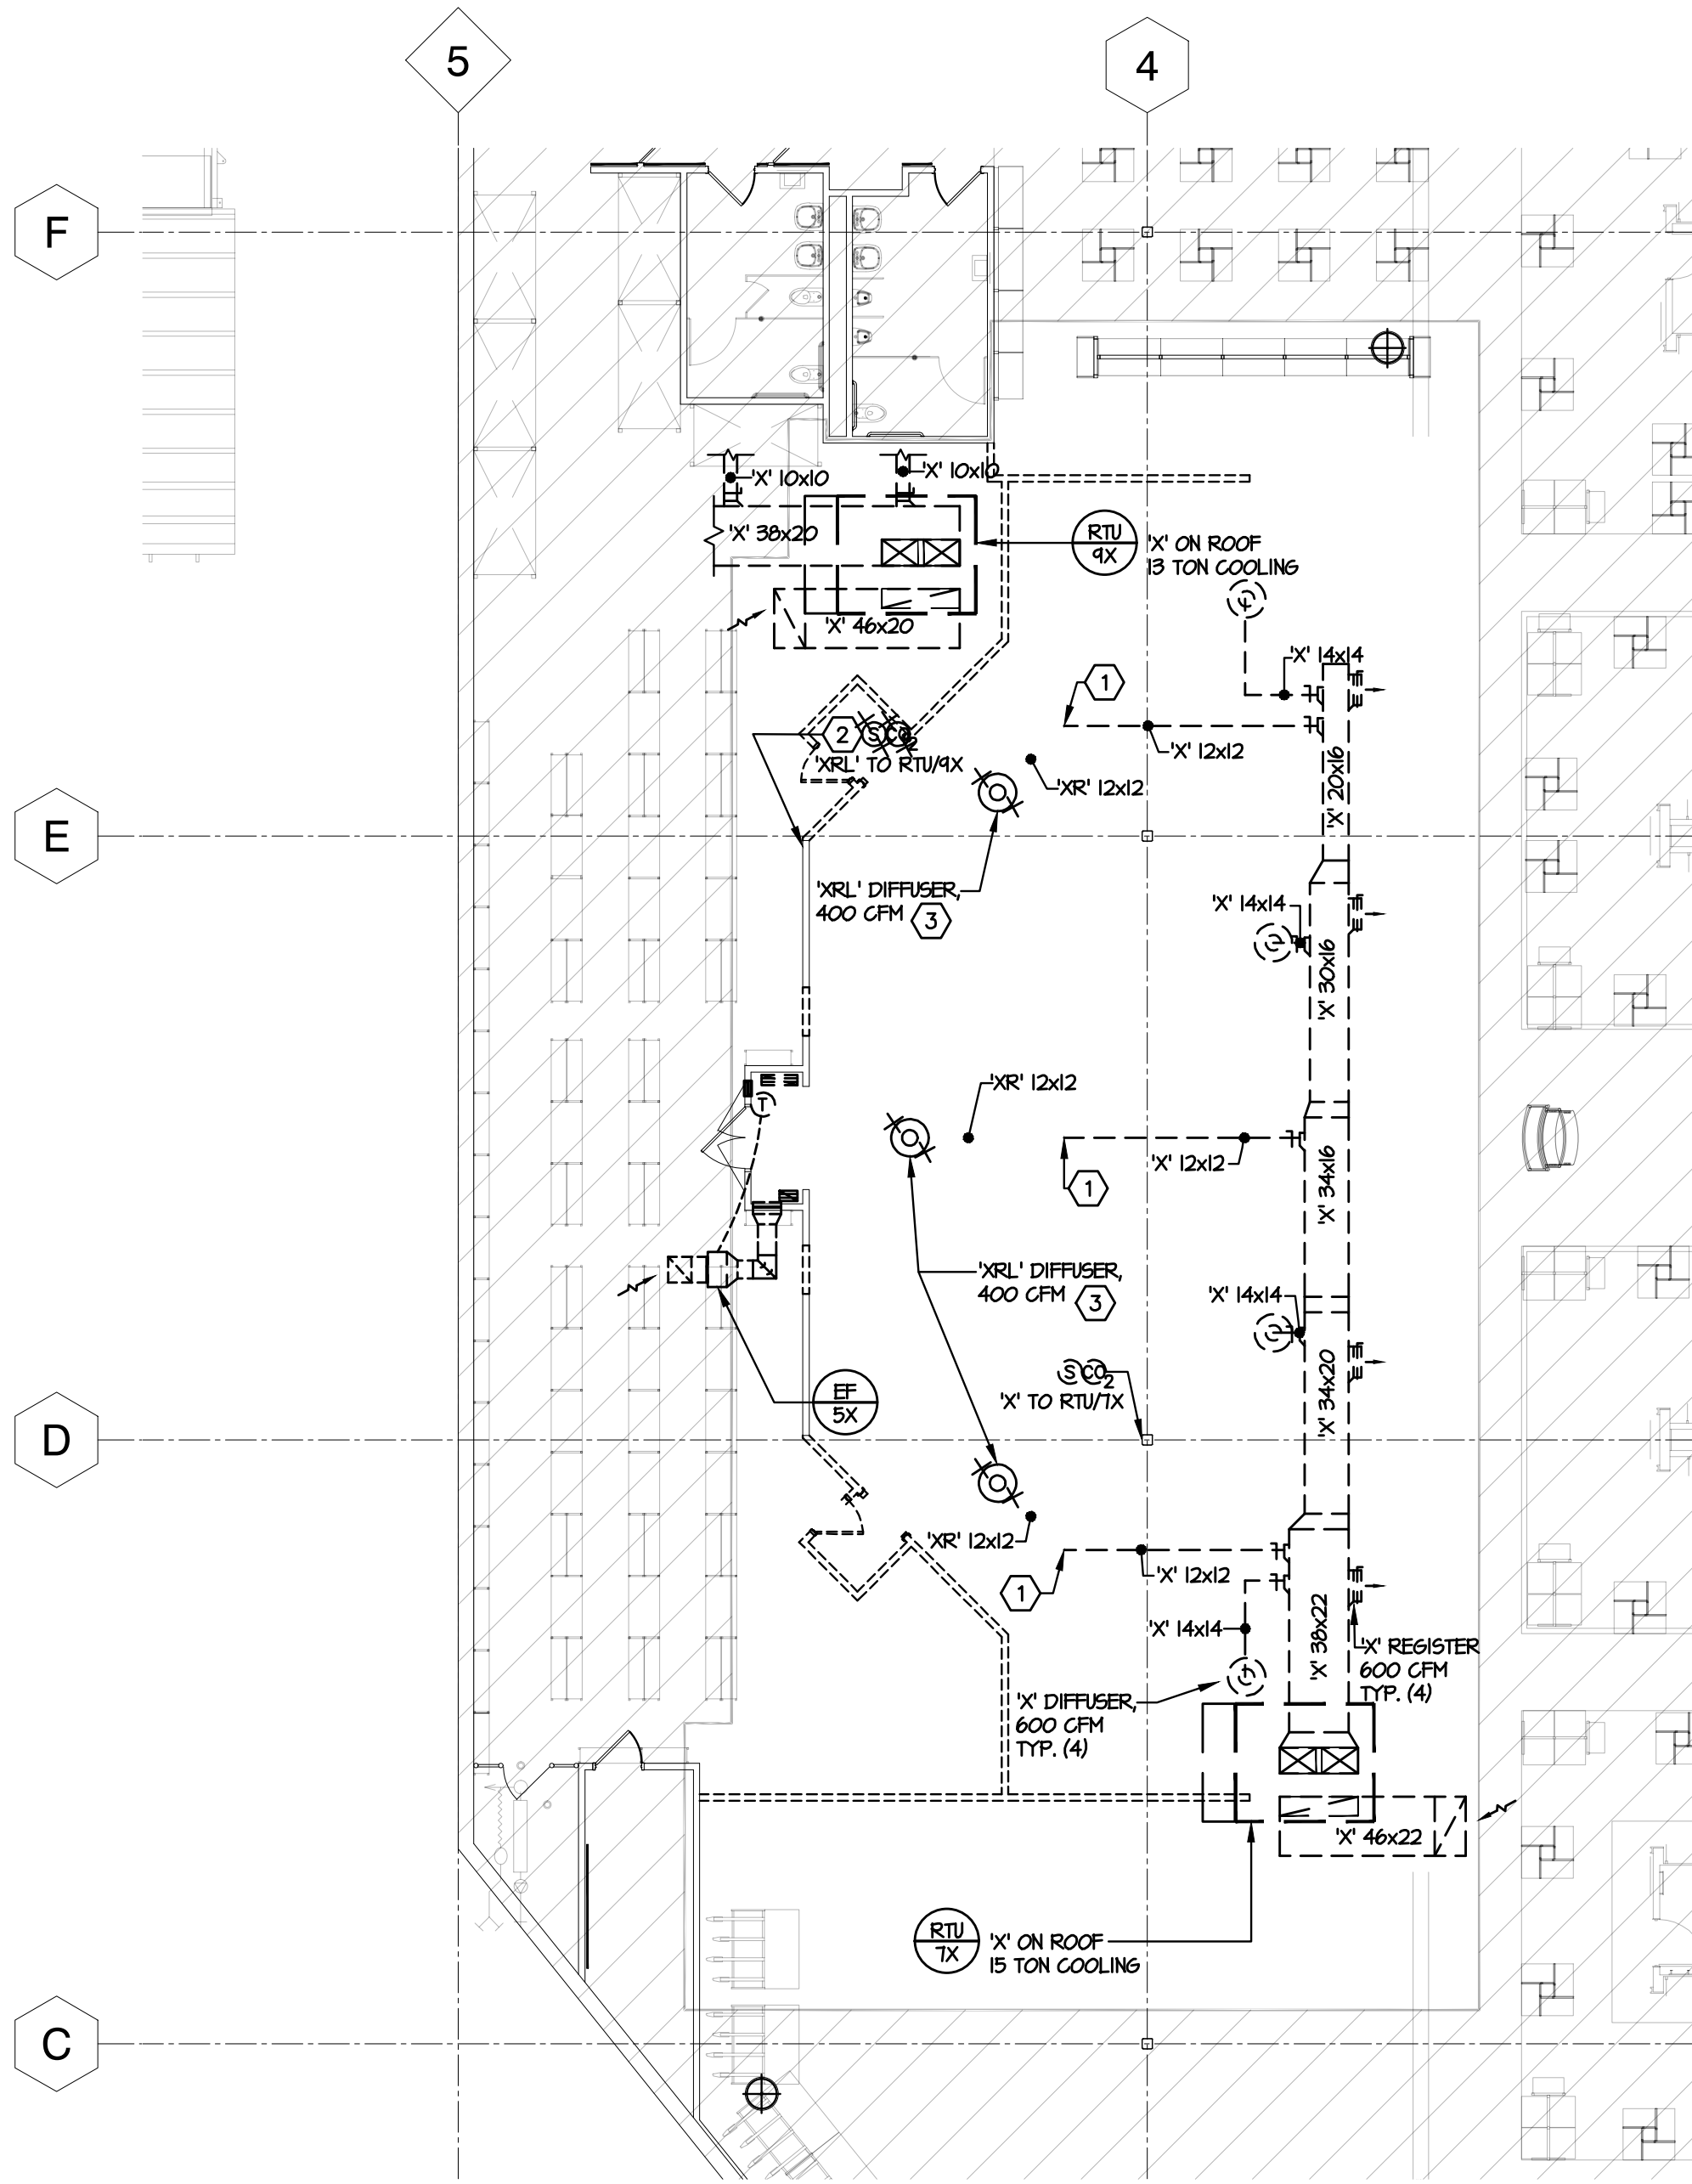H.V.A.C. GENERAL DEMOLITION NOTES:

- A. THIS CONTRACTOR SHALL COMPLETE ALL DEMOLITION OF EXISTING MECHANICAL SYSTEMS AS INDICATED ON MECHANICAL AND ARCHITECTURAL PLANS OR AS NECESSARY FOR THE PROJECT. REMOVE FROM SITE AND DISPOSE OF ALL MATERIAL AND DEBRIS FROM THIS WORK IN A CODE AND EPA APPROVED MANNER.
- B. DEMOLITION DRAWINGS ARE GENERAL IN NATURE SHOWING THE GENERAL SCOPE OF DEMOLITION WORK. CONTRACTOR SHALL VISIT SITE PRIOR TO BID AND BECOME FAMILIAR WITH ALL EXISTING MECHANICAL SYSTEMS AND PROVIDE ALL DEMOLITION REQUIRED FOR THE PROJECT.
- C. DEMOLITION WORK INCLUDES THE REMOVAL OF ALL UNSED EQUIPMENT, SUPPORTS, HANGERS, CONTROL WIRING, DUCTWORK, PIPING, ETC. ALL PIPING SHALL BE REMOVED BACK TO ACTIVE MAINS AND CAPPED WATERTIGHT.
- D. DISCONNECT, DISASSEMBLE, CAP, PLUG AND REMOVE ALL PIPING, DUCTS AND EQUIPMENT INDICATED ON THE DRAWINGS OR NOT REQUIRED FOR THE PROJECT. ALL OPENINGS ON PIPING AND DUCTS THAT REMAIN SHALL BE CAPPED AND PROPERLY SECURED. VERIFY ALL DEMOLITION WORK IN FIELD.
- E. OWNER SHALL DESIGNATE ANY ITEMS TO BE SALVAGED BY CONTRACTOR PRIOR TO START OF DEMOLITION. CONTRACTOR SHALL PROTECT AND TURN OVER TO OWNER ALL SALVAGED ITEMS AT AN OWNER DESIGNATED LOCATION ON SITE.
- F. DEMOLITION TO BE DONE IN A MANNER SO AS NOT TO DAMAGE SHOPPING CENTER OR ADJACENT SHOPPING CENTER TENANTS OR TENANT OPERATIONS AND SHALL NOT AFFECT THE OPERATION OF SYSTEMS TO REMAIN IN USE OR CAUSE ANY DISRUPTION TO OTHER TENANT OPERATIONS. ANY ITEM TO REMAIN THAT IS DAMAGED BY THE CONTRACTOR SHALL BE REPLACED AT THE CONTRACTOR'S EXPENSE.
- G. REPAIR ANY OPENINGS IN FIRE RATED CONSTRUCTION CAUSED BY THE DEMOLITION WORK TO MATCH EXISTING CONSTRUCTION AND MAINTAIN FIRE RATING.
- H. PATCH ALL HOLES IN WALLS, CEILINGS AND FLOORS THAT RESULT FROM THE DEMOLITION WORK FOR NEW SURFACE FINISH.
- I. COORDINATE TIMES TO WORK IN SPECIFIC AREAS OF THE EXISTING BUILDING WITH OWNERS REPRESENTATIVE. IF AFTER HOURS WORK IS REQUIRED, CONTRACTOR SHALL INCLUDE ALL PREMIUM TIME IN BID.
- J. CONTRACTOR SHALL MAINTAIN EXISTING ENERGY MANAGEMENT SYSTEM WIRING AND COMPONENTS. ANY ENERGY MANAGEMENT SYSTEM WIRING AND/OR EQUIPMENT THAT IS ACCIDENTALLY REMOVED OR DAMAGED DURING DEMOLITION/CONSTRUCTION SHALL BE REPLACED AT CONTRACTOR'S EXPENSE.
- K. PHASING: CONTRACTOR SHALL TAKE NOTE THAT NOT ALL DEMOLITION WORK CAN BE PERFORMED AT ONE TIME. CONTRACTOR IS REQUIRED TO COORDINATE THE REMOVAL AND/OR SHUTDOWN OF ANY EXISTING MECHANICAL SYSTEM AND ANY RELATED ELECTRICAL, PLUMBING OR FIRE PROTECTION SYSTEM REQUIRED FOR THIS PROJECT TO MAINTAIN THE EXISTING BUILDING OPERATIONAL THROUGHOUT THE COURSE OF CONSTRUCTION. CONFORM TO THE PROJECT CONSTRUCTION SCHEDULE, PHASING SEQUENCE AND INTENT IDENTIFIED BY THE CONSTRUCTION MANAGER AND ARCHITECT. CONTRACTOR SHALL COORDINATE ALLOWABLE WORKING HOURS IN SPECIFIC AREAS OF THE EXISTING BUILDING WITH THE CONSTRUCTION MANAGER. IF AFTER HOURS WORK IS REQUIRED, PREMIUM TIME SHALL BE INCLUDED IN BID. ANY REQUIRED DEMOLITION, RELOCATION OR SHUTDOWN OF EXISTING SYSTEMS, SHALL BE SUBMITTED FOR APPROVAL A MINIMUM OF TWO (2) WEEKS PRIOR TO PERFORMING THE REQUIRED WORK. NO DEMOLITION WORK AFFECTING EXISTING SYSTEMS TO REMAIN SHALL BE PERFORMED WITHOUT APPROVAL FROM THE CONSTRUCTION MANAGER.

H.V.A.C. CODED NOTES:

- 1. EXISTING BRANCH DUCTWORK TO BE REMOVED BACK TO THIS POINT. REFER TO H.V.A.C. FLOOR PLAN FOR NEW WORK.
- 2. EXISTING TEMPERATURE AND CARBON DIOXIDE SENSORS TO BE RELOCATED TO NEW LOCATION. REMOVE SENSORS, PROTECT, AND REINSTALL. REFER TO DRAWING HLD FOR NEW LOCATION.
- 3. EXISTING DIFFUSER TO BE RELOCATED. REMOVE, PROTECT, CLEAN, PAINT AND REINSTALL. REFER TO H.V.A.C. FLOOR PLAN FOR NEW LOCATION.

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Date	Issue
03-28-25	Issued for Bid-Permit

PROGRESS SET
DATE: 03-21-25

Drawn By:	MM
Project No.:	25061.10

DICK'S SPORTING GOODS STORE # 222
MONADNOCK MARKETPLACE
42 ASH BROOK ROAD
KEENE, NH 03431
*With exception of the National Account Vendor that DSG is purchasing directly from as noted on this vendor invoice, the General Contractor shall be responsible for the purchase and installation of all materials and equipment shown on these drawings. The General Contractor is required to obtain all necessary permits and approvals from the appropriate authorities. The General Contractor shall be responsible for the removal and disposal of all materials and equipment shown on these drawings. The General Contractor shall be responsible for the removal and disposal of all materials and equipment shown on these drawings. The General Contractor shall be responsible for the removal and disposal of all materials and equipment shown on these drawings. (Dick's Sporting Goods) has the right to change prices and/or specifications without notice.



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H.V.A.C.
DEMOLITION PLANS


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CONTRACTOR MUST VERIFY ALL CLEARANCES AND DIMENSIONS IN FIELD


McHenry & Associates Incorporated

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Consulting Engineers est. 1960


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1 ELECTRICAL POWER PLAN
SCALE 3/32" = 1'-0"

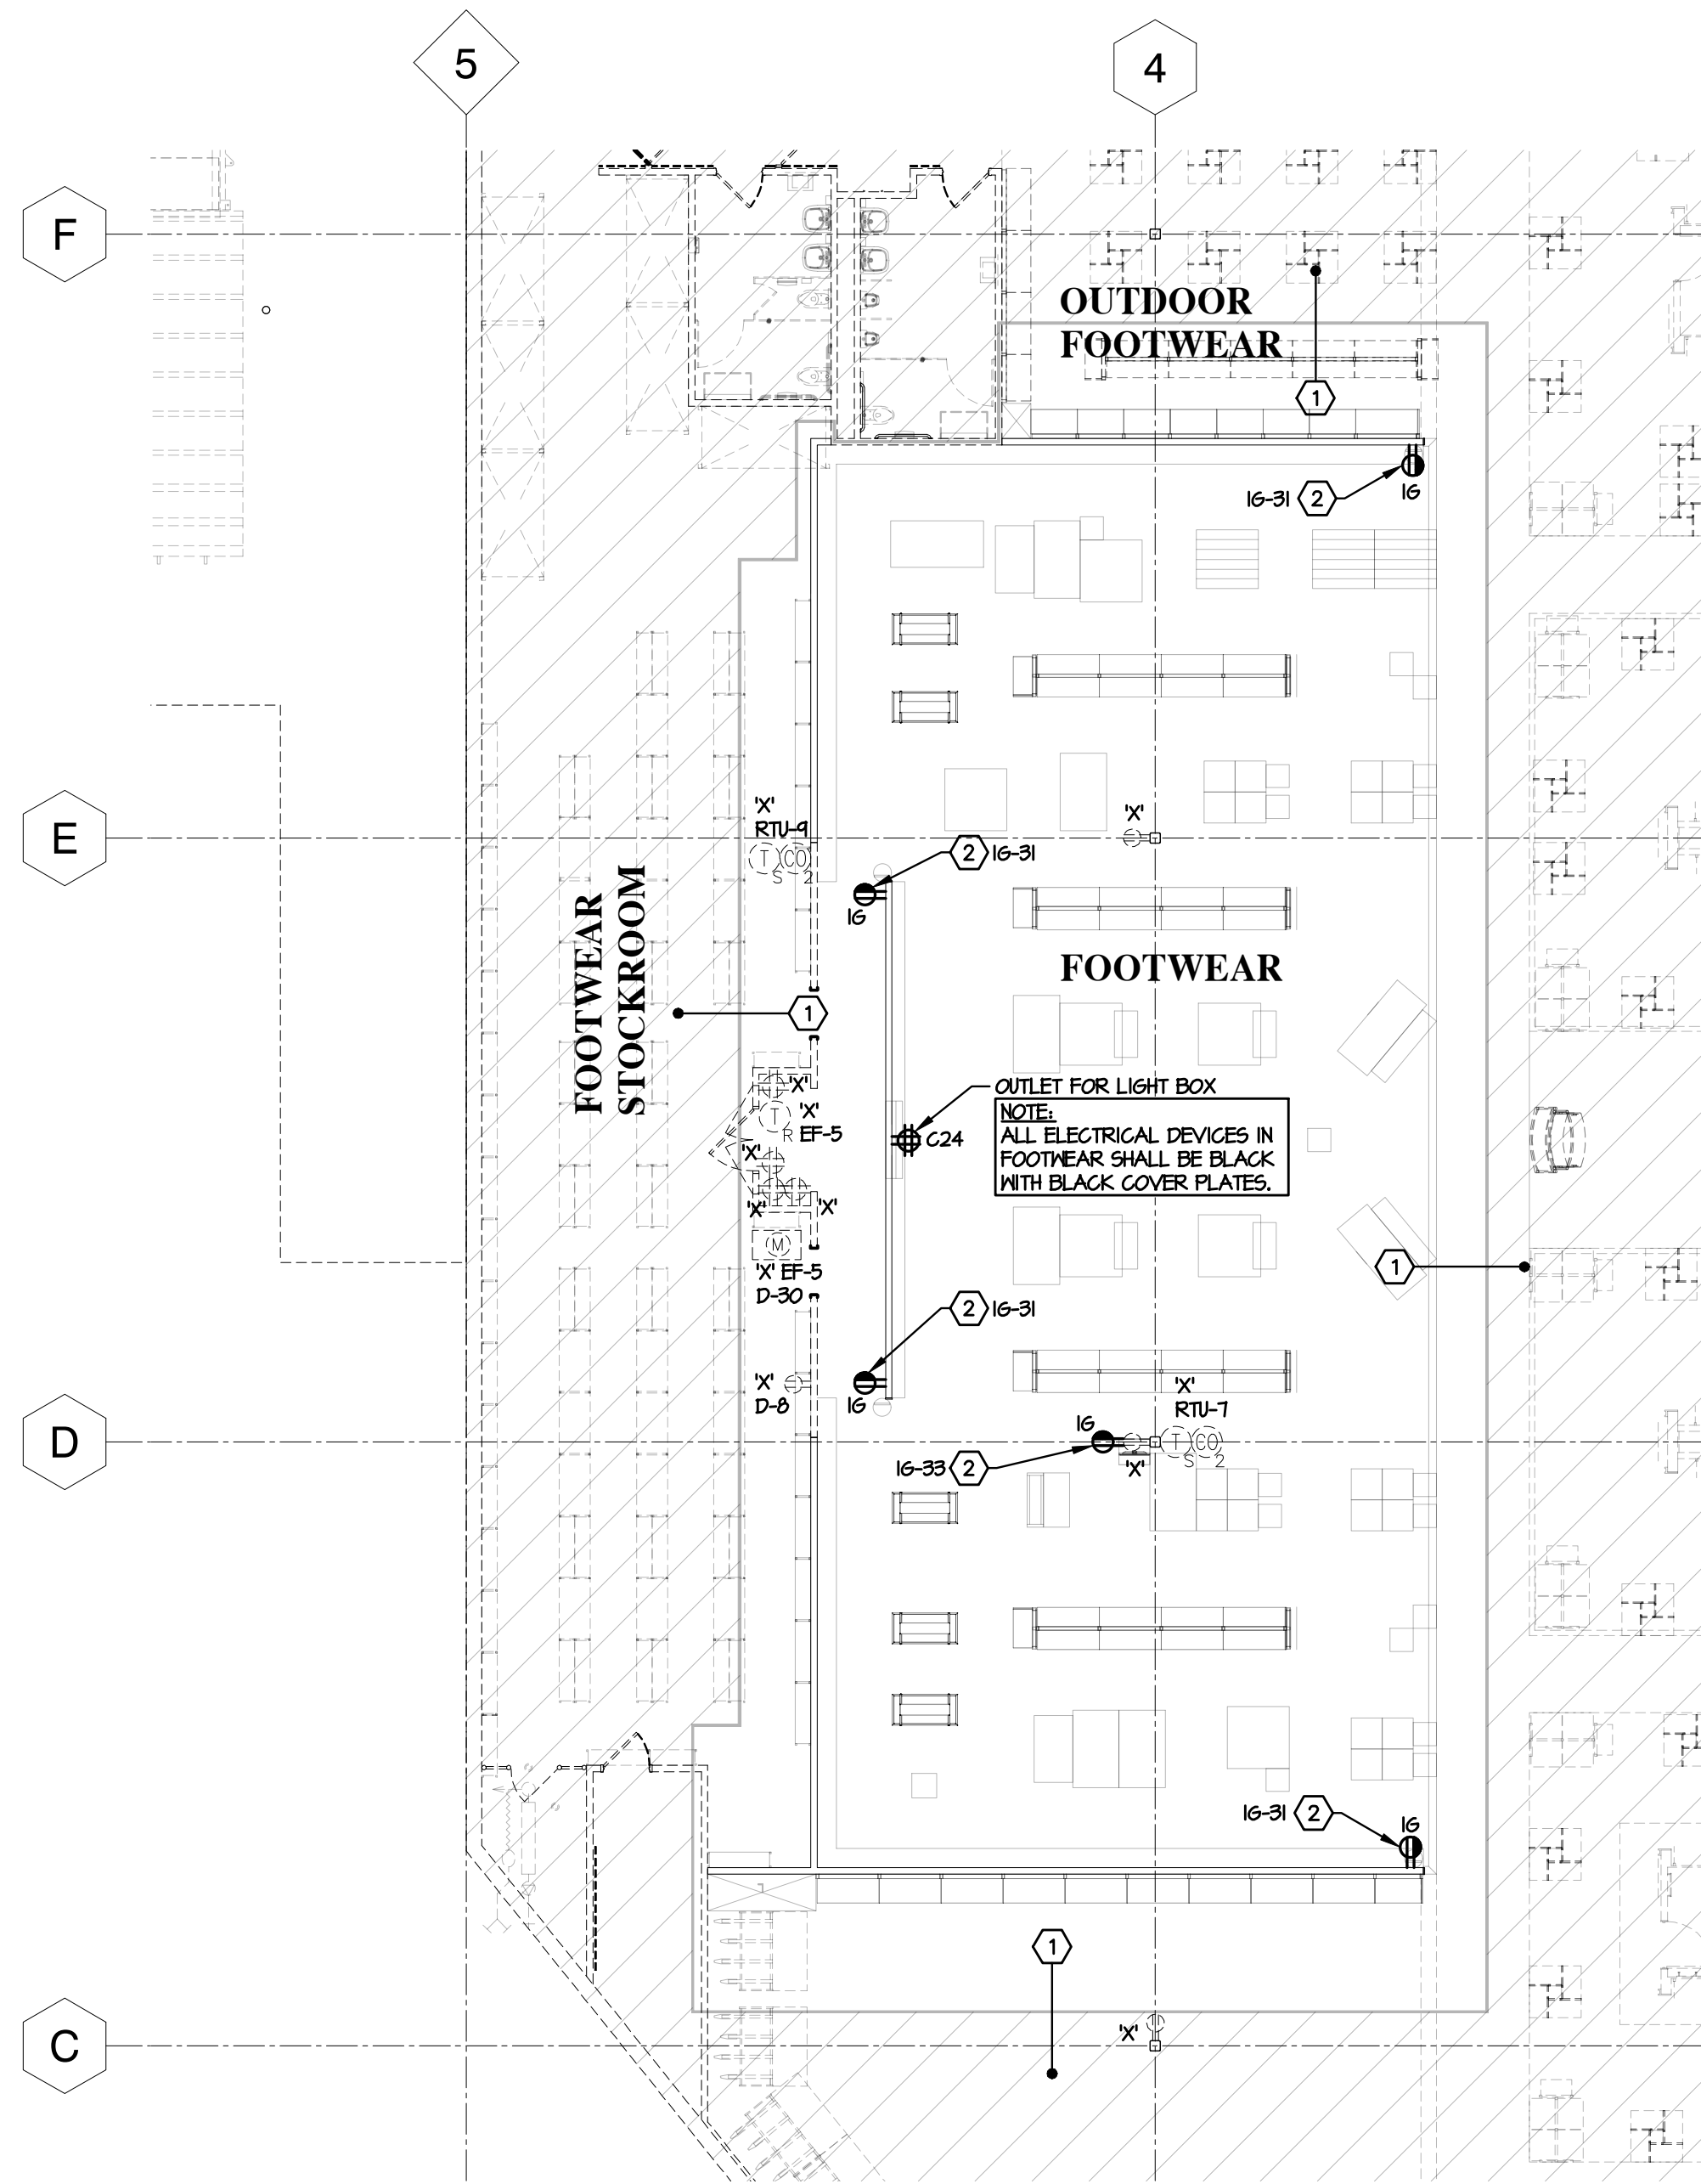

2 LIGHTING & TRACK PLAN
SCALE 3/32" = 1'-0"

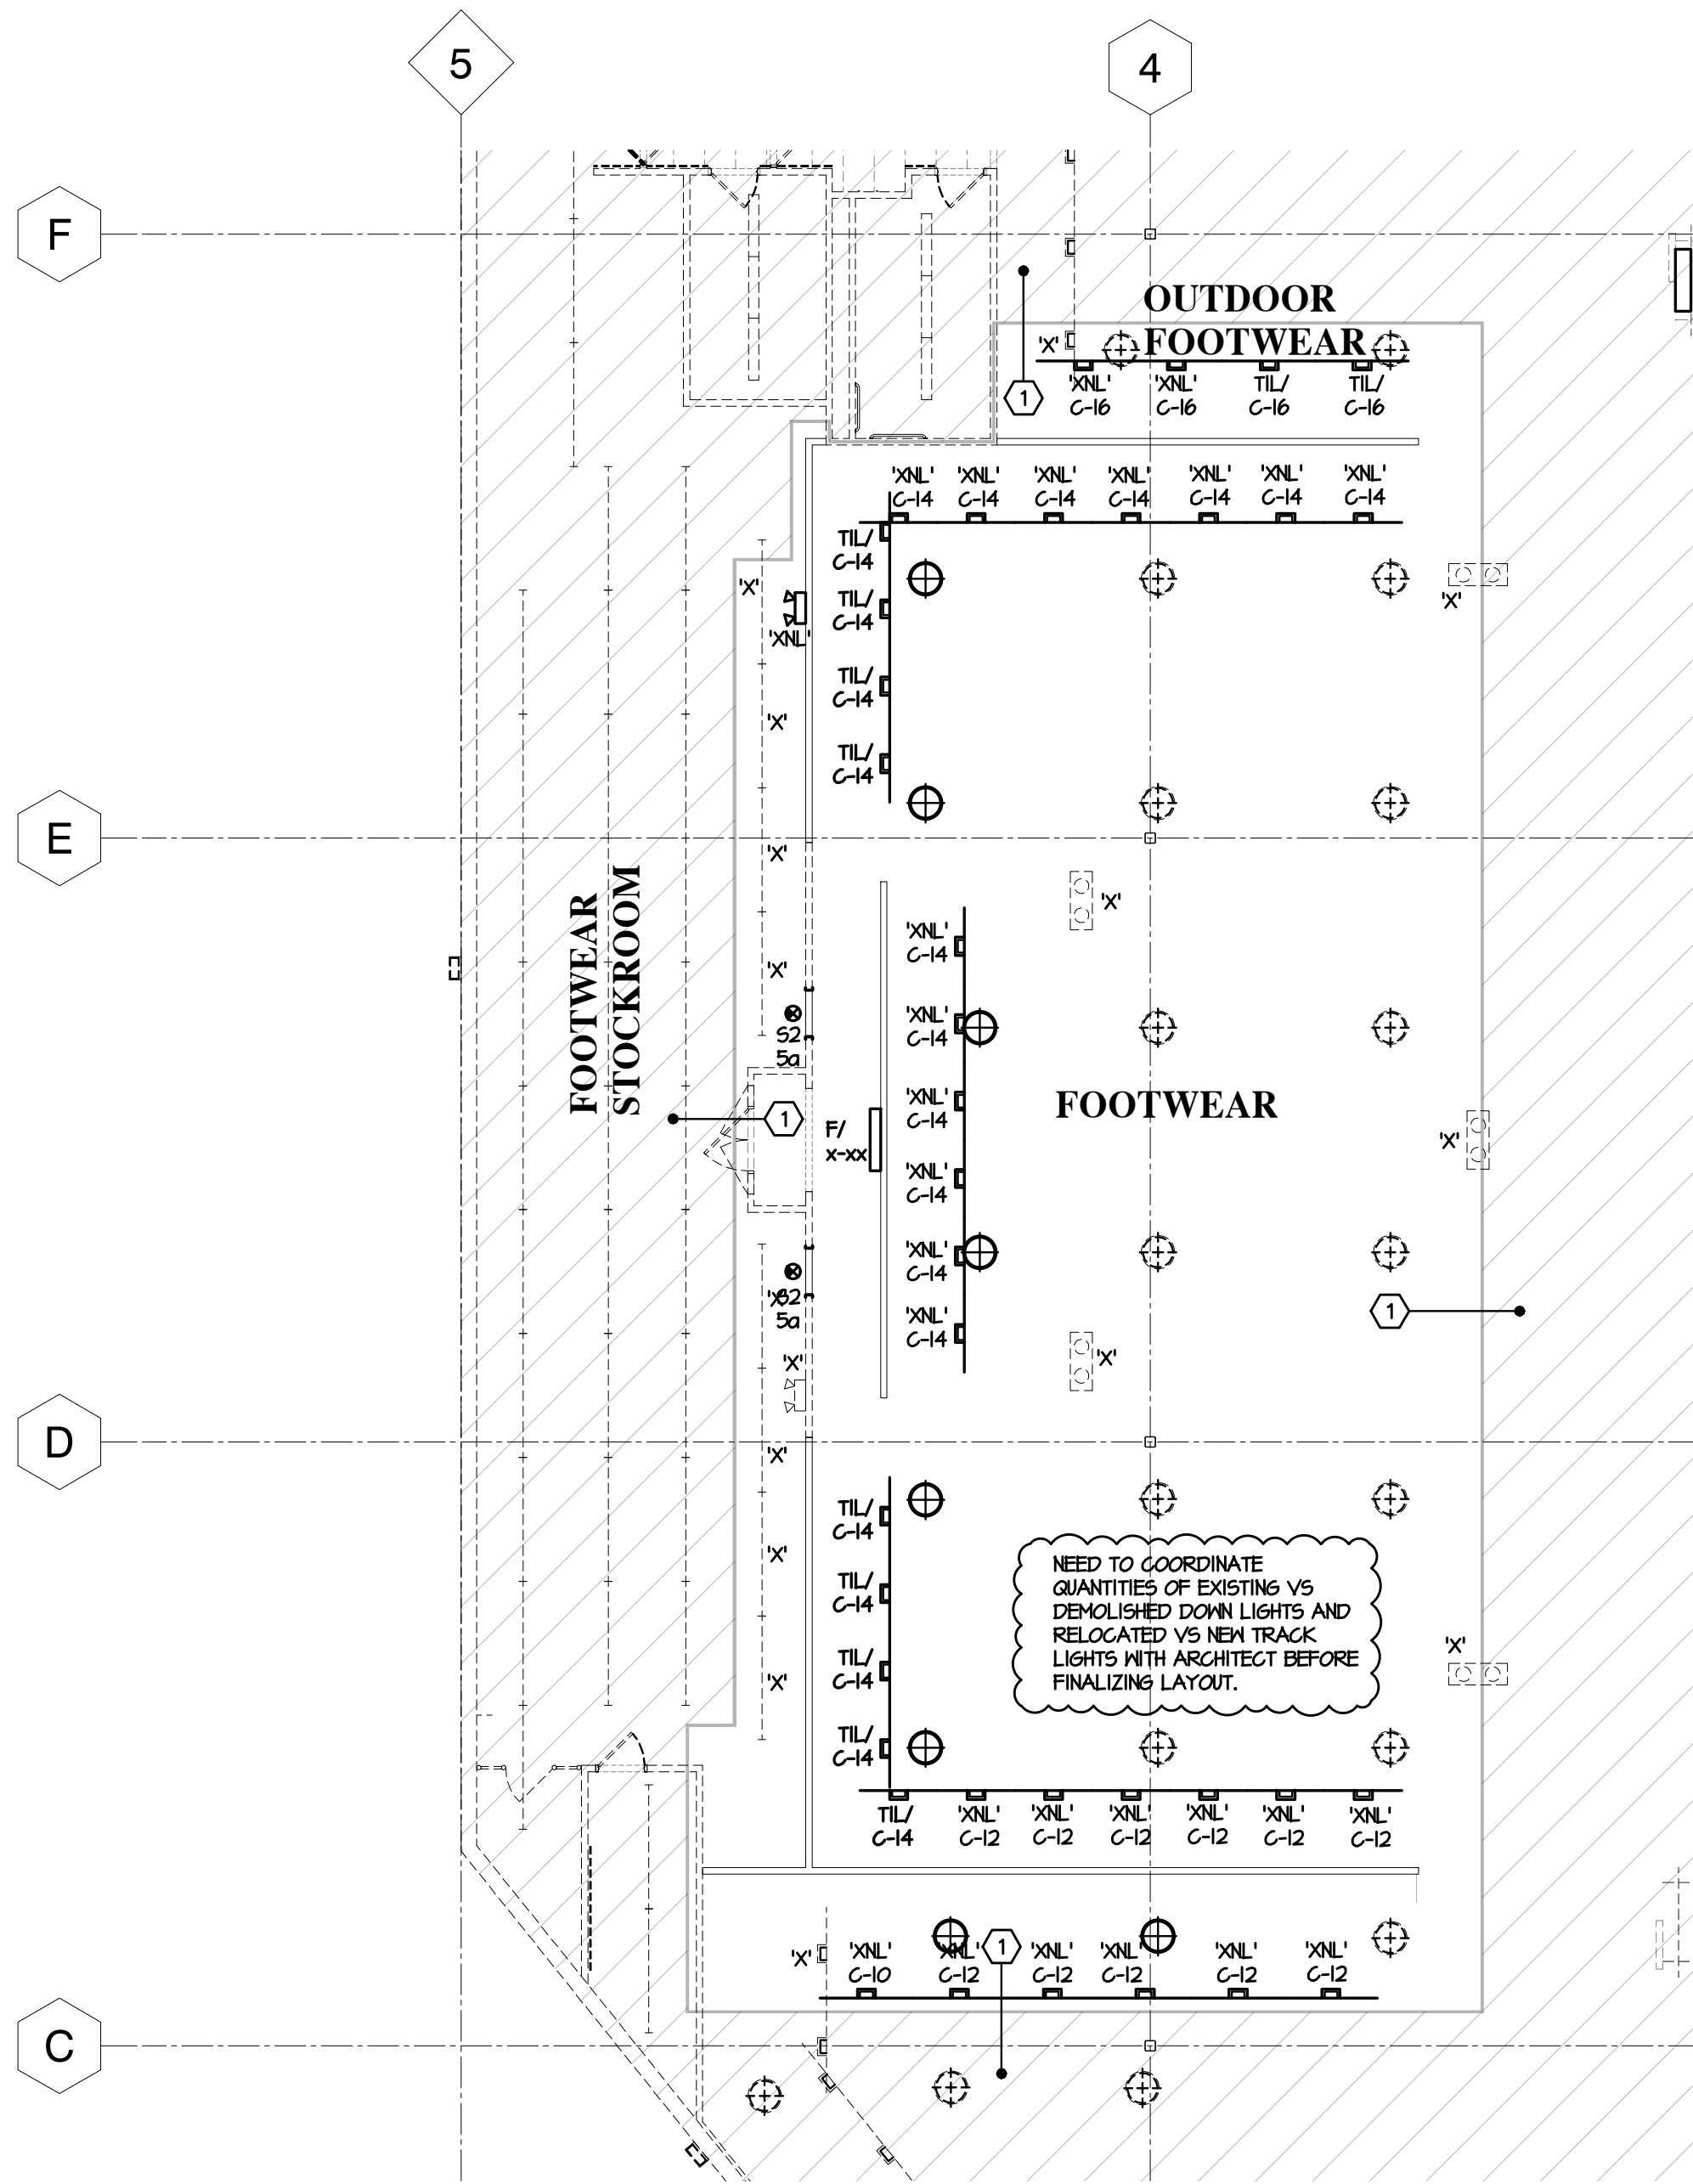

- NOTES:**
1. SWITCH LEG DESIGNATIONS ARE MATCHED BETWEEN CONTROL DEVICES AND LIGHT FIXTURES LOCATED IN THE SAME ROOM UNLESS NOTED OTHERWISE. CONTACT ENGINEER IF CLARIFICATION IS REQUIRED.
 2. SUBSCRIPT 'V' DENOTES AN UNWITTED NOT LBS 'V' THAT MUST ALWAYS REMAIN ON TO EACH EMERGENCY BATTERY PACK AND EXIT SIGNS, SHOWN WIRED TO CONTROLLED LIGHTING CIRCUITS INDICATED ON PLANS. WHERE NOT NOTED AS 'NL', FIXTURES SHALL BE ON CONTROLLED CIRCUIT.
 3. ALL LIGHT FIXTURES ARE FED FROM PANEL 'A' UNLESS OTHERWISE NOTED.

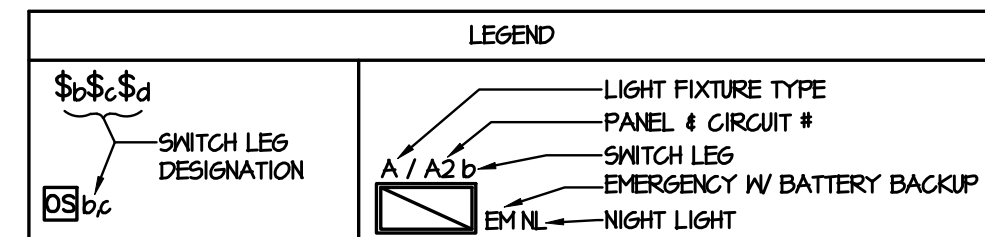- GENERAL LIGHTING NOTES:**
- ALL GENERAL LIGHTING CIRCUITS SHOWN ON THIS LIGHTING PLAN ARE FROM EXISTING PANEL 'A' LOCATED IN POWER WALL IN THE STOCK ROOM UNLESS NOTED OTHERWISE AND ALL CIRCUITS SHOWN ON TRACK LIGHTING PLAN ARE FROM PANEL 'C'.
 - ALL CIRCUITS SHOWN ON DRAWING ARE FOR REFERENCE ONLY. E.G. IS TO FIELD VERIFY NUMBER OF SPARE CIRCUIT BREAKERS AND SPACES IN EXISTING PANELS AND REDUCE FOR NEW CIRCUITS SHOWN ON DRAWING. E.G. IS TO VERIFY LOADS ON PANELS AFTER DEMO OF EXISTING CIRCUITS AND ADDING NEW CIRCUITS TO PANELS. PROVIDE NEW CIRCUIT BREAKERS OR REDUCE EXISTING IN PANELS. MATCH PANEL TYPES AND UL RATINGS.
 - E.G. SHALL FIELD VERIFY ALL EXISTING CIRCUITS SHOWN TO BE REUSED HAVE AMPLE LOAD CAPACITY FOR WORK INDICATED. E.G. SHALL VERIFY THAT EXISTING CONDITIONS ARE AS SHOWN ON DRAWINGS. IF A DISCREPANCY EXISTS THAT WILL AFFECT THE WORK, IT SHALL IMMEDIATELY BE BROUGHT TO THE ATTENTION OF THE OWNER AND ENGINEER.
 - ALL LIGHT FIXTURES ARE CONTROLLED BY ENERGY MANAGEMENT SYSTEM.
 - ELECTRICAL CONTRACTOR SHALL VERIFY THE PROPER MOUNTING HEIGHT OF THE EMERGENCY FIXTURES WITH THE LOCAL FIRE MARSHALL PRIOR TO INSTALLATION.
 - REFER TO DRAWING THIS DRAWING FOR ROOM/AREA NAMES.
 - SEE LIGHT FIXTURE SCHEDULE ON DRAWING E3.0.
 - ALL BRANCH CIRCUITS MORE THAN 100 FEET IN LENGTH FOR 120 VOLT CIRCUITS AND 200 FEET FOR 277 VOLT CIRCUITS SHALL BE MINIMUM #10 AWG.
 - REFER TO THIS DRAWING FOR EXACT LOCATION AND MOUNTING HEIGHT OF ALL LIGHT FIXTURES. COORDINATE WITH ARCHITECT'S REFLECTED CEILING PLAN PRIOR TO ROUGH-IN.
 - ALL CONDUITS RUN IN EXPOSED CEILING AREAS SHALL BE RUN WITH STRUCTURE TIGHT TO UNDER SIDE OF ROOF DECKING IN ACCORDANCE WITH NEC, ARTICLE 300-4(E).
 - PROVIDE ADDITIONAL EXIT SIGNS TO MATCH EXISTING IN PROJECT AREA AS DIRECTED BY THE LOCAL AUTHORITY HAVING JURISDICTION.
- TRACK NOTES:**
- LOCATE TRACK LIGHTING AS SHOWN ON ARCHITECT'S REFLECTED CEILING PLAN.
 - MOUNT ALL TRACK LIGHTING AT 16'-0" AFF. AT EXPOSED AREAS, UNLESS OTHERWISE NOTED.
 - ELECTRICAL CONTRACTOR TO VERIFY COUNTS OF TRACK FIXTURES.
 - INITIAL ADJUST FOR FIXTURES MOUNTED AT 15'-6" - 16'-0" AFF. AM LIGHT FIXTURES 40 DEGREES AS DIAGRAMMED, EMPHASIZING THE ADJACENT MERCHANDISE WALL DISPLAY AND BRANDING GRAPHICS. PERFORM FINAL ADJUSTMENTS AS DIRECTED BY DICK'S SPORTING GOODS AUTHORIZED REPRESENTATIVE.
 - TRACK SUPPORTS ARE TO BE 4'-0" ON CENTER WITH A SUPPORT LOCATED AT EACH TRACK END (OR PER LOCAL CODE). FACTORY PREDRILLED HOLES ARE NOT DESIGNATED SUPPORT HANGING POINTS AND WILL NOT PROVIDE THE PROPER SPACING.
- DEMOLITION SYMBOLS:**
- 'X' = INDICATES EXISTING DEVICE TO REMAIN.
- 'XR' = INDICATES EXISTING DEVICE TO BE REMOVED, INCLUDING ALL CONDUIT AND WIRING BACK TO PANEL OR POINT OF COMMON USAGE.
- 'XRL' = INDICATES EXISTING DEVICE TO BE REMOVED AND RELOCATED, EXTEND EXISTING WIRING AND RENEW WITH LIKE KIND OR AS SHOWN ON DRAWING. CORRESPONDS WITH 'XRL'.
- 'XNL' = INDICATES NEW LOCATION OF RELOCATED EQUIPMENT. CORRESPONDS WITH 'XRL'.
- 'XRW' = INDICATES EXISTING DEVICE TO BE REMOVED. REMOVED AS SHOWN OR REPLACE EXISTING DEVICE WITH NEW AND RENEW AS INDICATED.
- 'XR0' = INDICATES EXISTING DEVICE TO BE DISCONNECTED AND ALL CONDUIT AND WIRING TO BE REMOVED.
- 'CTX' = INDICATES CONNECT TO EXISTING CIRCUITS).
- POWER GENERAL NOTES:**
- VOLTAGE DROPS ARE BASED ON FEEDER CONDUCTORS SIZED FOR A MAXIMUM VOLTAGE DROP OF 2% AT DESIGN LOAD. BRANCH CIRCUIT CONDUCTORS SHALL BE SIZED FOR A MAXIMUM VOLTAGE DROP OF 3% AT DESIGN LOAD. THE CONTRACTOR SHALL USE THE FOLLOWING CHART TO SIZE BRANCH CIRCUITS:
FOR 20A BRANCH CIRCUITS ONLY:
ALL BRANCH CIRCUITS MORE THAN 75 FEET IN LENGTH FOR 120 VOLT CIRCUITS AND 200 FEET FOR 277 VOLT CIRCUITS SHALL BE MINIMUM #10 AWG.
ALL BRANCH CIRCUITS MORE THAN 150 FEET IN LENGTH FOR 120 VOLT CIRCUITS AND 400 FEET FOR 277 VOLT CIRCUITS SHALL BE MINIMUM #8 AWG.
ALL BRANCH CIRCUITS MORE THAN 225 FEET IN LENGTH FOR 120 VOLT CIRCUITS SHALL BE MINIMUM #6 AWG.
ALL BRANCH CIRCUITS MORE THAN 350 FEET IN LENGTH FOR 120 VOLT CIRCUITS SHALL BE MINIMUM #4 AWG.
 - ALL THERMOSTAT LOCATIONS SHALL BE APPROVED BY DICKS ON SITE REPRESENTATIVE.
 - ALL CONDUITS RUN IN EXPOSED CEILING AREAS SHALL BE RUN WITH STRUCTURE TIGHT TO UNDER SIDE OF ROOF DECKING IN ACCORDANCE WITH NEC, ARTICLE 300-4(E).
 - ALL ELECTRICAL PANELS ARE LOCATED IN POWER WALL IN ELECTRICAL ROOM.
- GOODS NOTES:**
- ALL EXISTING ELECTRICAL POWER & LIGHTING IN HATCHED AREA IS EXISTING TO REMAIN 'X'. MAINTAIN ALL EXISTING CONTROLS AND RELATED WIRING BACK TO PANELS OR POINT OF COMMON USAGE.
 - ELECTRICAL CONTRACTOR TO PROVIDE A SEPARATE INSULATED/ISOLATED GROUND CONDUCTOR FROM EACH ISOLATED GROUND RECEPTACLE BACK TO PANEL 'A'.
 - STOCKROOM OCCUPANCY SENSOR TO BE INSTALLED DIRECTLY TO END OF FIXTURE VIA KNOCKOUT ON THE FIXTURE HOUSING.
 - MOUNT TYPE 1L6" AND 1L6H" FIXTURES IN STOCK ROOM @ 15'-0" AFF BETWEEN SHELVING. E.G. SHALL PROVIDE UNISTRUT AT STRUCTURE ABOVE TO CHAIN-HANG FIXTURES AT HEIGHT INDICATED. PROVIDE CHAIN AND ALL NECESSARY MOUNTING HARDWARE. POWER SHALL BE ROUTED FROM JUNCTION BOX AT UNISTRUT DOWN THROUGH MC CABLE ZIP-TIED TO CHAIN TO FIXTURE (TYPICAL).

CONTRACTOR MUST VERIFY ALL CLEARANCES AND DIMENSIONS IN FIELD

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Date: 03-28-25
Issue: Issued for Bid-Permit

PROGRESS SET
DATE: 03-21-25

Drawn By: DB
Project No.: 25061-10

DICK'S SPORTING GOODS STORE # 222
MONADNOCK MARKETPLACE
42 ASH BROOK ROAD
KEENE, NH 03431


***With exception of the National Account Vendor that DSG is purchasing directly from as noted on the vendor list, all other goods and services are purchased from Dick's Sporting Goods. The General Contractor is required to purchase and install complete as shown and referenced. The General Contractor is required to coordinate with the National Account Vendors as well as their subcontractors. The General Contractor is responsible for all materials and labor required to complete the project. The General Contractor is responsible for all materials and labor required to complete the project. The General Contractor is responsible for all materials and labor required to complete the project. (Dick's Sporting Goods) has the right to accept or reject any and all work and materials submitted for approval.

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LIGHTING AND
POWER PLANS
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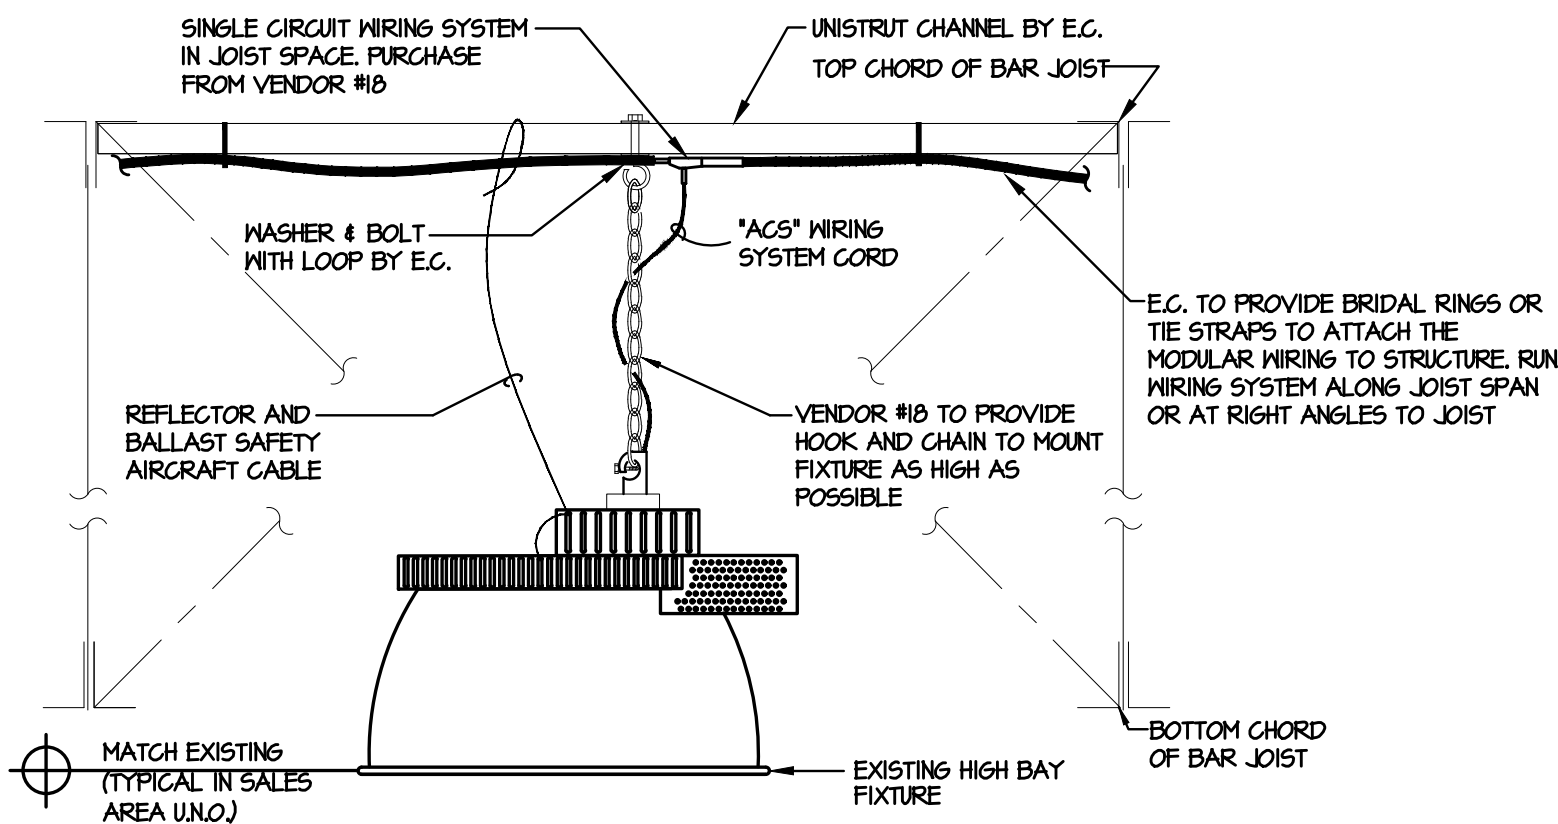


TRACK NOTES:

- LOCATE TRACK LIGHTING AS SHOWN ON ARCHITECT'S REFLECTED CEILING PLAN.
- MOUNT ALL TRACK LIGHTING AT 16'-0" AFF. AT EXPOSED AREAS, UNLESS OTHERWISE NOTED.
- ELECTRICAL CONTRACTOR TO VERIFY COUNTS OF LED TRACK FIXTURES. LOCATE FIXTURES AS SHOWN ON DRAWING ELOA. ELECTRICAL CONTRACTOR TO PROVIDE 5 ADDITIONAL FIXTURES FOR USE BY DICK'S SPORTING GOODS.
- INITIAL AIMING FOR FIXTURES MOUNTED AT 15'-6" - 16'-0" AFF. AIM LIGHT FIXTURES 40 DEGREES AS DIAGRAMMED, EMPHASIZING THE ADJACENT MERCHANDISE WALL DISPLAY AND BRANDING GRAPHICS. PERFORM FINAL AIMING ADJUSTMENTS AS DIRECTED BY DICK'S SPORTING GOODS AUTHORIZED REPRESENTATIVE.
- TRACK SUPPORTING CABLES ARE TO BE 4'-0" ON CENTER WITH A SUPPORT LOCATED AT EACH TRACK END (OR PER LOCAL CODE). FACTORY PREDRILLED HOLES ARE NOT DESIGNATED SUPPORT HANGING POINTS AND WILL NOT PROVIDE THE PROPER SPACING.

3 TRACK LIGHTING DETAIL (OPEN CEILING)

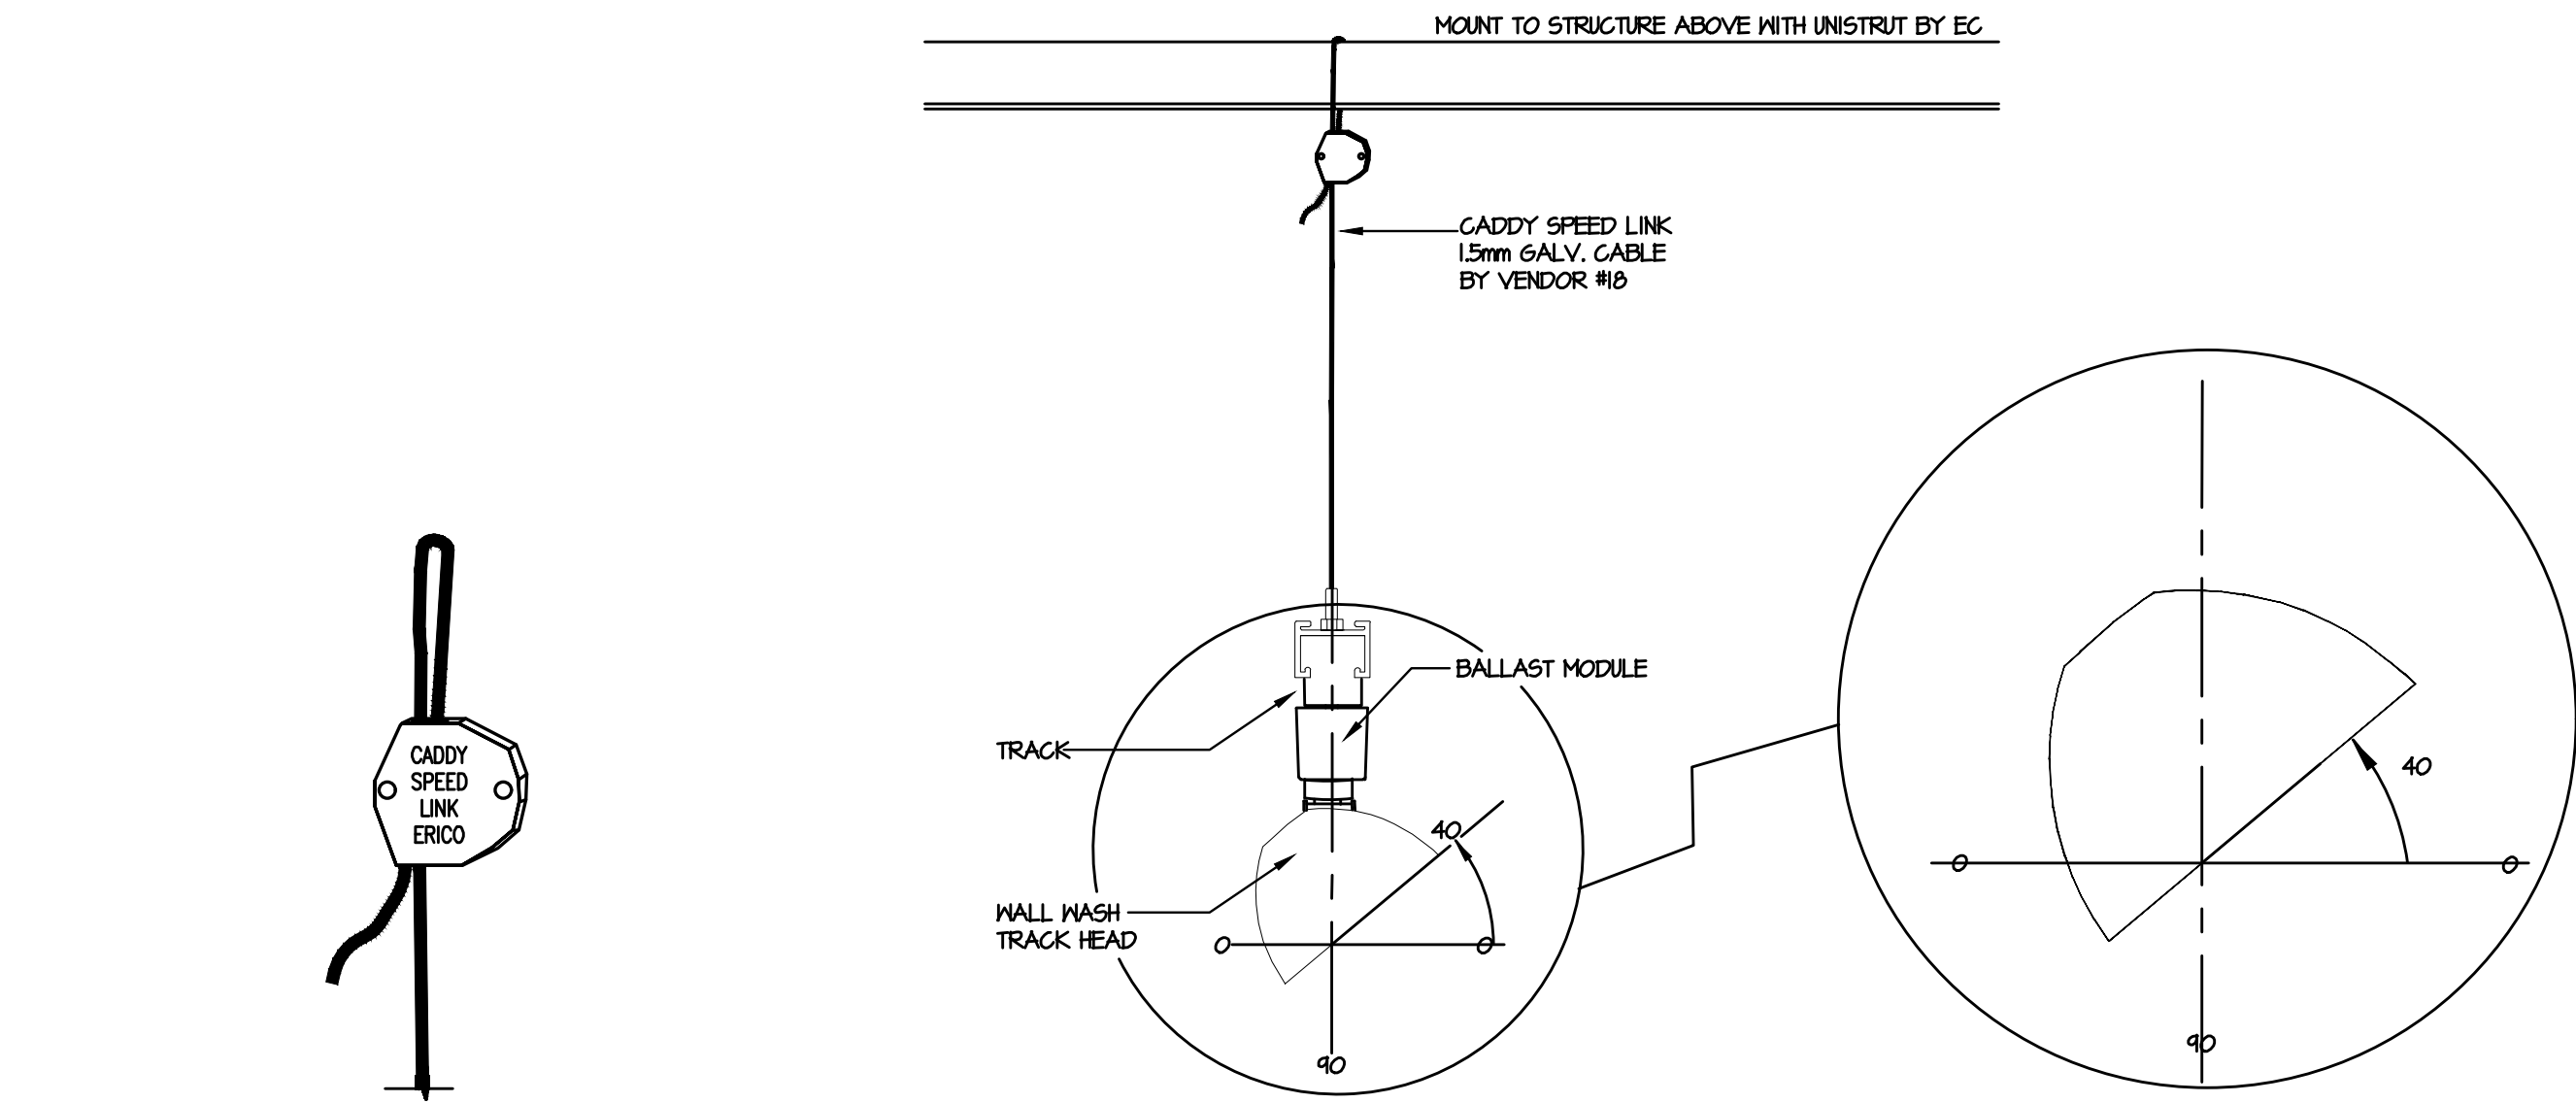SCALE: N.T.S.



NOTES:

- BOLT HOOK TO UNISTRUT, DOUBLE NUT ALL THREADED CONNECTIONS. PROVIDE HOOK AND LOOP TO SUPPORT FIXTURE BY MEANS OF STEEL CHAIN. SUPPORT FIXTURE FROM UNISTRUT, COORDINATE METHOD OF FASTENING UNISTRUT TO TOP CHORD OF JOIST WITH STRUCTURAL ENGINEER PRIOR TO INSTALLATION. DO NOT DRILL OR WELD TO JOIST. ASSEMBLY SHALL SUPPORT FOUR TIMES THE FIXTURE WEIGHT.
- WHERE FIXTURES OCCUR DIRECTLY BELOW BAR JOIST (I.E. MAIN CENTER AISLE), PROVIDE JOIST CLAMP WITH HOOK AND CHAIN FOR FIXTURE MOUNTING TO JOIST.
- ALL UNISTRUT SHALL BE PAINTED TO MATCH CEILING, REFER TO ARCHITECTURAL DRAWINGS.
- E.G. SHALL INSTALL ALL LIGHTING IN ACCORDANCE WITH N.E.C.

SYMBOL LIST	
----	CONDUIT RUN IN OR BELOW FLOOR SLABS - MAINTAIN 2" MINIMUM CONCRETE COVER ABOVE CONDUIT
	CEILING OUTLET BOX AND FLUORESCENT LIGHTING FIXTURE.
	INDUSTRIAL OR STRIP FLUORESCENT LIGHTING FIXTURE. INDICATES "EM" - EMERGENCY BATTERY PACK REQUIRED.
	CEILING OUTLET BOX AND FLUORESCENT LIGHTING FIXTURE WITH "EM" - EMERGENCY BATTERY PACK REQUIRED.
	EMERGENCY LIGHTING FIXTURE, INTEGRAL BATTERY
	EXIT LIGHT FIXTURE
	EXIT LIGHT FIXTURE, WALL MOUNTED
	WALL OUTLET BOX AND 20 AMP DUPLEX RECEPTACLE. MOUNT 18" AFF. UNLESS NOTED. COLOR OF RECEPTACLE SHALL BE WHITE WITH WHITE COVER PLATE
	"TV" INDICATES CEILING MOUNTED TELEVISION RECEPTACLE. "VCR" INDICATES WALL MOUNTED VCR RECEPTACLE. "IG" INDICATES ISOLATED GROUND RECEPTACLE - ORANGE IN COLOR
	"GFI" INDICATES GROUND FAULT INTERRUPTING RECEPTACLE. "WFG" INDICATES WEATHERPROOF GFI RECEPTACLE.
	TWO GANG WALL OUTLET BOX AND 20 AMP TWO DUPLEX RECEPTABLES.
	SPECIALTY TYPE SIMPLEX RECEPTACLE, 15 AMPERE, MOUNT AS INDICATED, HUBBELL 5295
	TELEPHONE LINE WALL OUTLET BOX AND PLATE WITH MINIMUM 3/4" CONDUIT TO ABOVE ACCESSIBLE FINISHED CEILING. PROVIDE PULL CORD, ANALOG LINE.
	DATA CABLE LOCATION.
	PULL BOX, FLUSH MOUNTED OR ABOVE CEILING, UNLESS OTHERWISE NOTED. SIZE AS REQUIRED.
	EQUIPMENT CONNECTION, WITH DESIGNATION FROM ELECTRIC EQUIPMENT AND CONTROL SCHEDULE
	LOCATION OF ONE OR MORE EQUIPMENT CONTROL DEVICES AS SCHEDULED ON ELECTRIC EQUIPMENT AND CONTROL SCHEDULE. NUMBER REFERS TO EQUIPMENT CONTROLLED
	NON FUSED DISCONNECT SWITCH, VOLTAGE RATING TO MATCH EQUIPMENT SERVED.
	FUSED DISCONNECT SWITCH, VOLTAGE RATING TO MATCH EQUIPMENT SERVED.
	EDWARDS #600 - 48V BRASS WEATHERPROOF PUSH BUTTON E.G. TO INSTALL AND WIRE AT BACKDOOR.
	EDWARDS #640-465 - 24V AC 4" BELL WITH 120V AC / 24V AC TRANSFORMER. E.G. TO INSTALL AND WIRE AT BACKDOOR.
	SPECIAL PURPOSE RECEPTACLE AS REQUIRED. VERIFY EXACT LOCATION IN FIELD WITH DICK'S REPRESENTATIVE.
	POWER CONNECTION TO LOCAL DOOR ALARM
	2X DUPLEX RECEPTACLE OUTLETS, WITH FLUSH SQUARE 2 GANG CAST IRON FLOOR BOX. PROVIDE BRASS COVER PLATE - HUBBELL OR EQUAL
	TEMPERATURE SENSOR
	THERMOSTAT - PROVIDED BY MECH. CONTRACTOR. WIRED AND MOUNTED BY E.G. MTD. 4'-0" UNLESS NOTED OTHERWISE.
	REVERSE ACTING THERMOSTAT - PROVIDED BY MECH. CONTRACTOR. WIRED AND MOUNTED BY E.G. MTD. 4'-0" UNLESS NOTED OTHERWISE.
	ONE HR. TIMER SWITCH FURNISHED BY MECH. CONTRACTOR. INSTALLED AND WIRED BY E.G.
	CODED DRAWING NOTE
	DIMENSION ABOVE FINISHED FLOOR TO BOTTOM OF DEVICE
	GLOBAL HUMIDITY SENSOR
	HUMIDITY SENSOR
	COMBINED TEMPERATURE / RELATIVE HUMIDITY / CARBON DIOXIDE SENSOR
	ANTENNA LOCATION
	WIRELESS CALL BOX
	120/277V AUTOMATIC WALL SWITCH WITH OCCUPANCY SENSING AND TIMED SHUT OFF. MATT STOPPER MODEL #PWH-10W. BY VENDOR #10
	ACCESS POINTS IN CEILING.
	ULTRASONIC CEILING MOUNT OCCUPANCY SENSOR - MATTSTOPPER #W500A OR EQUAL (FOR USE WITH MATTSTOPPER #55-50 POWER PACK) BY VENDOR #10
	INFRARED CEILING MOUNT OCCUPANCY SENSOR - MATTSTOPPER #W500B-H-13 OR EQUAL BI-DIRECTIONAL. BY VENDOR #10
	EDWARDS #642, 120V, PUSH BUTTON BY E.G. FOR FRONT OF STORE.
	VIKING SR-1, 120V AC/13.8V AC 1.25A, WITH MODEL 25AE. BY E.G. FOR RETAIL FLOOR AND OFFICE SUITE.
	FLUSH SINGLE GANG CAST IRON FLOOR BOX FOR DATA / TELEPHONE CABLING. PROVIDE BRASS COVER PLATE - HUBBELL OR EQUAL
	CORD REEL WITH HUBBELL 3464 VULC CONNECTOR, WHITE WITH WHITE CORD. SIMILAR TO HUBBELL #HBL/255225 (25' 12/3 SJT CABLE, RATED 20 AMPS) PROVIDED BY VENDOR #10
	DUAL CHAMBER POWER POLE WITH OUTLETS SHOWN ON PLANS. FOR POWER AND DATAPHONE DROP TO EQUIPMENT. PROVIDE LENGTH AS REQUIRED. HUBBELL OR EQUAL. PAINT TO MATCH SURROUNDING SURFACES. COORDINATE WITH ARCHITECT.

GENERAL NOTES:

- NO DUCTWORK OR PIPING TO BE RUN ABOVE ELECTRICAL PANELS. ELECTRICAL CONTRACTOR SHALL COORDINATE WITH ALL TRADES FOR EQUIPMENT LAYOUTS PRIOR TO ROUGH-IN OF ALL SYSTEMS
- DEVICES IN THE FLOOR ARE NOT TO BE SCALED FROM THESE DRAWINGS. LOCATIONS SHALL BE VERIFIED WITH THE DICKS ON SITE REPRESENTATIVE AND OR DIMENSIONS TAKEN IN THE FIELD.
- ELECTRICAL CONTRACTOR TO CONFIRM ALL REQUIREMENTS AND LOCATIONS OF ALL EXIT SIGNS, EMERGENCY LIGHTS AND FIRE ALARM DEVICES WITH LOCAL FIRE AUTHORITIES PRIOR TO ROUGH-IN.
- ELECTRICAL CONTRACTOR TO CONFIRM LOCATIONS OF ALL ELECTRICAL DEVICES WITH FIXTURING LOCATIONS PRIOR TO ROUGH-IN.
- ELECTRICAL CONTRACTOR TO VERIFY ALL EQUIPMENT ELECTRICAL CHARACTERISTIC PRIOR TO ROUGH-IN.
- VENDOR FOR ALL LIGHTING FIXTURES IS VENDOR #10.
- CONDUIT ROUTING IS SHOWN ON DRAWINGS IN APPROXIMATE LOCATIONS UNLESS DIMENSIONED. UNLESS NOTED OTHERWISE, ALL CONDUIT SHALL BE CONCEALED. WHERE SHOWN EXPOSED, CONCEAL IN WALLS AT MAXIMUM HEIGHT POSSIBLE FOR RUNS TO FLUSH DEVICE BOXES.
- NO ELECTRICAL ROUGH-IN BOXES ARE PERMITTED ON WALL GRAPHICS.
- CONTRACTORS BIDDING THIS PROJECT SHALL HAVE PRIOR EXPERIENCE WORKING IN THIS JURISDICTION AND MUST LIST ON BID FORM ANY LOCAL REQUIREMENTS THAT ARE NOT SHOWN ON THE DRAWINGS. SUBMISSION OF A BID SHALL BE EVIDENCE THAT THE CONTRACTOR'S BID INCLUDES ALL JURISDICTIONAL REQUIREMENTS.

BRANCH CIRCUITING GENERAL NOTES:

- ON 20 AMP, 1 POLE CIRCUITS, HOMERINGS SHALL BE 2 #12 AWG + #12 GND IN 3/4" CONDUIT MINIMUM (INCLUDE ADDITIONAL ISOLATED GROUND CONDUCTOR SIZED TO MATCH GROUND CONDUCTOR IS IDENTIFIED AS ISOLATED GROUND CIRCUIT). INCREASE WIRE SIZE AS REQUIRED PER VOLTAGE DROP TABLE ON THIS DRAWING.
 - VOLTAGE DROPS ARE BASED ON FEEDER CONDUCTORS SIZED FOR A MAXIMUM VOLTAGE DROP OF 2% AT DESIGN LOAD. BRANCH CIRCUIT CONDUCTORS SHALL BE SIZED FOR A MAXIMUM VOLTAGE DROP OF 2% AT DESIGN LOAD.
- ALL CIRCUITS SHALL HAVE INDIVIDUAL NEUTRAL CONDUCTORS CONTINUOUS FROM PANEL. SHARED NEUTRALS ARE NOT PERMITTED.

VOLTAGE DROP SCHEDULE

120 VOLT BRANCH CIRCUITS UP TO 10 AMPS	
TOTAL WIRE LENGTH (FEET)	WIRE SIZE (AWG)
1' - 100'	#12
101' - 150'	#10
151' - 240'	#8
241' - 300'	#6
120 VOLT BRANCH CIRCUITS UP TO 14 AMPS	
TOTAL WIRE LENGTH (FEET)	WIRE SIZE (AWG)
1' - 75'	#12
76' - 100'	#10
101' - 150'	#8
151' - 240'	#6
277 VOLT BRANCH CIRCUITS UP TO 16 AMPS	
RUN DISTANCE IN FEET	WIRE SIZE AWG
1' - 100'	#12
101' - 220'	#10
221' - 340'	#8
341' - 540'	#6

MINIMUM LIGHTING CIRCUIT WIRING IS 12 AWG. CONTRACTOR SHALL INCREASE WIRE SIZE BASED ON GREENE MOVING

LIGHTING FIXTURE SCHEDULE

SYMBOL	MARK	DESCRIPTION	CATALOG #	INPUT VOLTAGE	REMARKS
	52	56L FACE EXIT WITH EMERGENCY DRIVER	ELX-603-R-W	24V	MOUNTED AT 4'-6" AFF.
	L61	4' LED STRIP	C4BLV52W6100LYDMV40K	52V	
	L61EM	4' LED STRIP WITH EMERGENCY DRIVER	C4BLV52W6100LYDMV40K-EM	52V	PROVIDE EMERGENCY BATTERY DRIVER

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Date: 03-28-25
Issue: Issued for Bid-Permit

PROGRESS SET
DATE: 03-27-25

Drawn By: DB
Project No.: 25061.10

DICK'S SPORTING GOODS STORE # 222
MONADNOCK MARKETPLACE
42 ASH BROOK ROAD
KEENE, NH 03431
*With exception of the National Account Vendor that DSG is purchasing directly from as noted on this vendor list, all other vendors are to be purchased through the Dick's Sporting Goods National Account Vendor. The General Contractor is required to purchase and install complete as shown and referenced. The General Contractor is required to coordinate and supervise all labor and material as well as their subcontractors and suppliers. (Dick's Sporting Goods) has the right to remove and/or reposition any items from these plans without notification.

DICK'S SPORTING GOODS
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mog
mog architecture

MATT E. MAJEED, ARCHITECT
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ELECTRICAL DETAILS,
SCHEDULES & NOTES

E3.0

CONTRACTOR MUST VERIFY
ALL CLEARANCES AND
DIMENSIONS IN FIELD

McHenry & Associates Incorporated

Mc & A
Consulting Engineers est. 1960

25001 Emery Road, Suite #200
Warrensville Heights, Ohio 44128
Phone: 216-292-4696
Fax: 216-292-5874
Email: mail@mcHenryassociates.com

PANEL

VOLTAGE:

PH & WIRES:

BUSING AMPS:

208/120

3P 4W

100A

WANS:

AC RATING:

MOUNTING:

100A M.C.B.

EXISTING

IN SWITCHGEAR

LOCATION:

FEEDER CAPACITY:

REMARKS:

IFTS CHORDS

100

EXISTING PANEL TO BE MODIFIED AS SHOWN

	LOAD DESCRIPTION	KVA	P	AMP	CCT	KVA LOADS			CCT	AMP	P	KVA	LOAD DESCRIPTION	
						PH A	PH B	PH C						
X,P	LTS - CUSTOMER TRACKS	0.85	1	20	1	1.17	----	----	2	20	1	0.32	LTS - RESTROOMS	
X,P	LTS - CUSTOMER TRACKS	1.08	1	20	3	----	----	1.08	----	4	20	1	0.00	SPARE
X,P	LTS - CUSTOMER TRACKS	1.15	1	20	5	----	----	1.15	6	20	1	0.00	SPARE	
X,P	LTS - CUSTOMER TRACKS	0.75	1	20	7	0.91	----	----	8	20	1	0.16	ED - STORE FRONT DOOR BELL	
	SPARE	0.00	1	20	9	----	0.00	----	10	20	1	0.00	SPARE	
	C SPARE	0.00	1	20	11	----	0.00	12	20	1	0.00	SPARE		
	C LTS - GOLF OUTRIGGERS	1.00	1	20	13	1.00	----	----	14	20	1	0.00	SPARE	
	C SPARE	0.00	1	20	15	----	0.60	----	16	20	1	0.60	EQ - GOLF TV	
X,P,W,C	REC - FOOTWEAR LIGHTBOX	0.60	1	20	17	----	----	1.50	18	20	1	1.00	REC - CHECK OUT TV'S	
	LTS - PORTAL / FITTING RM VALENCE	1.60	1	20	19	1.00	----	----	20	20	1	0.00	SPARE	
X,P	LTS - CUSTOMER SERVICE COUNTER	0.50	1	20	21	----	1.04	----	22	20	1	0.54	CONTROLLED REC - BREAK RM. & LIT	
	C SPARE	0.00	1	20	23	----	0.72	24	20	1	0.72	CONTROLLED REC - BEPT MGR		
	C SPARE	0.00	1	20	25	0.90	----	----	26	20	1	0.90	CONTROLLED REC - CASH & STOR MGR	
	C SPARE	0.00	1	20	27	----	0.50	----	28	20	1	0.50	LTS - GOLF DISPLAY VALENCE	
	C SPARE	0.00	1	20	29	----	0.50	30	20	1	0.50	LTS - GOLF DISPLAY VALENCE		
X,L	LTS - FITTING ROOMS	0.58	1	20	31	1.08	----	----	32	20	1	0.50	LTS - GOLF DISPLAY VALENCE	
	EMERGENCY LIGHTING	0.00	--	--	33	----	0.00	----	34	20	1	0.00	SPARE	
	C SPARE	0.00	1	20	35	----	0.70	36	20	1	0.70	EQ - EFX		
	C SPARE	0.00	1	20	37	0.00	----	----	38	20	1	0.00	SPARE	
	C SPARE	0.00	1	20	39	----	0.20	----	40	20	1	0.20	EQ - BP	
	C SPARE	0.00	1	20	41	----	0.70	42	20	1	0.70	EQ - EFX		
		CONNECTED AMPS:			40.93	6.06	3.42	5.26	CONNECTED KVA:			14.75		

NOTES:

PROVIDE SOLID NEUTRAL BUS & GROUND BAR.

E = INDICATES CONTROLLED CIRCUIT BREAKER W/ ADDITIONAL UNCONTROLLED EMERGENCY LIGHTING CIRCUIT BREAKER

CONTROLLABLE CIRCUIT BREAKER THAT CONTROLS EMERGENCY LIGHTING SHALL HAVE 2 POLES. ONE POLE SHALL BE UNCONTROLLED

THIS CIRCUIT BREAKER WILL USE 2 SPACES. ROUTE THE UNSWITCHED POLE TO EMERGENCY LIGHTING.

C = INDICATES CONTROLLED CIRCUIT BREAKER

X = INDICATES EXISTING CIRCUIT TO REMAIN

XW = INDICATES EXISTING CIRCUIT BREAKER SHALL BE USED FOR NEW CIRCUIT OR MADE SPARE FOLLOWING DEMOLITION

Desired Load Amps =

55.4

	Contracted	Desired
Lighting	5.40	6.76
Signage	0.00	0.00
Show Window Length	0.00	0.00
Track Amps	3.83	7.68
Track Length	0.00	0.00
Receptacles	3.76	3.76
Ac Units	0.00	0.00
Elec. Heat	0.00	0.00
Hot Water Htr.	0.00	0.00
Kitchen Equip.	0.00	0.00
Microwaves	1.75	1.75
Total KVA	14.7	19.9
Total Amps	40.9	55.4

[illegible]

1. ALL PANEL SCHEDULES AND ELECTRICAL LOAD INFORMATION SHOWN ON THIS PLAN HERE OBTAINED FROM SITE SURVEY AND ARE TO BE VERIFIED IN FIELD PRIOR TO ADDING NEW LOADS TO PANELS.
2. DOCUMENTS ELECTRICAL CONTRACTOR SHALL BALANCE CURRENT IN ALL PANELS. MODIFY AND/OR ADJUST CIRCUITS AS REQUIRED.
3. ELECTRICAL CONTRACTOR SHALL PROVIDE INDIVIDUAL NEUTRAL CONDUCTORS FOR ALL CIRCUITS PER NEC 200.4.
4. CIRCUITS SHOWN IN BOLD LETTERING ARE CIRCUITS AFFECTED BY REWIRE. ALL OTHERS ARE EXISTING REMAIN.
5. ALL CIRCUITS SHOWN ON DRAWINGS ARE FOR REFERENCE ONLY. E.G. IS TO VERIFY LOADS AND CIRCUIT BREAKERS ARE CORRECT AND SPACES IN EXISTING PANELS AND REUSE FOR NEW CIRCUITS SHOWN ON DRAWING. E.G. IS TO VERIFY LOADS ON PANELS AFTER DEMO OF EXISTING PANELS AND REUSE FOR NEW CIRCUITS TO PANELS. PROVIDE NEW CIRCUIT BREAKERS OR REUSE EXISTING IN PANELS. MATCH PANEL TYPES AND VOLT RATINGS.
6. E.G. SHALL FIELD VERIFY ALL EXISTING CIRCUITS SHOWN TO BE REDUCED OR AMPLIFIED FOR NEW LOADS. E.G. SHALL FIELD VERIFY ALL EXISTING CIRCUITS SHOWN TO BE AMPLIFIED. IF A DISCREPANCY EXISTS THAT WILL AFFECT THE WORK, THE DISCREPANCY SHALL BE BROUGHT TO THE ATTENTION OF THE OWNER AND ENGINEER.

I. CONTROLLED OR SWITCHABLE CIRCUIT BREAKER FOR THIS NEW CIRCUIT IN PANEL IS TO BE CONTROLLED WITH CUSTOMER LIGHTING CONTROL GROUP BY EMS SYSTEM.

Project No.: 25061.10

2

STORE # 222

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MONADNOCK MARKETPLACE
42 ASH BROOK ROAD
KEENE, NH 03424



AAA

MC&A
Consulting Engineers est. 1960


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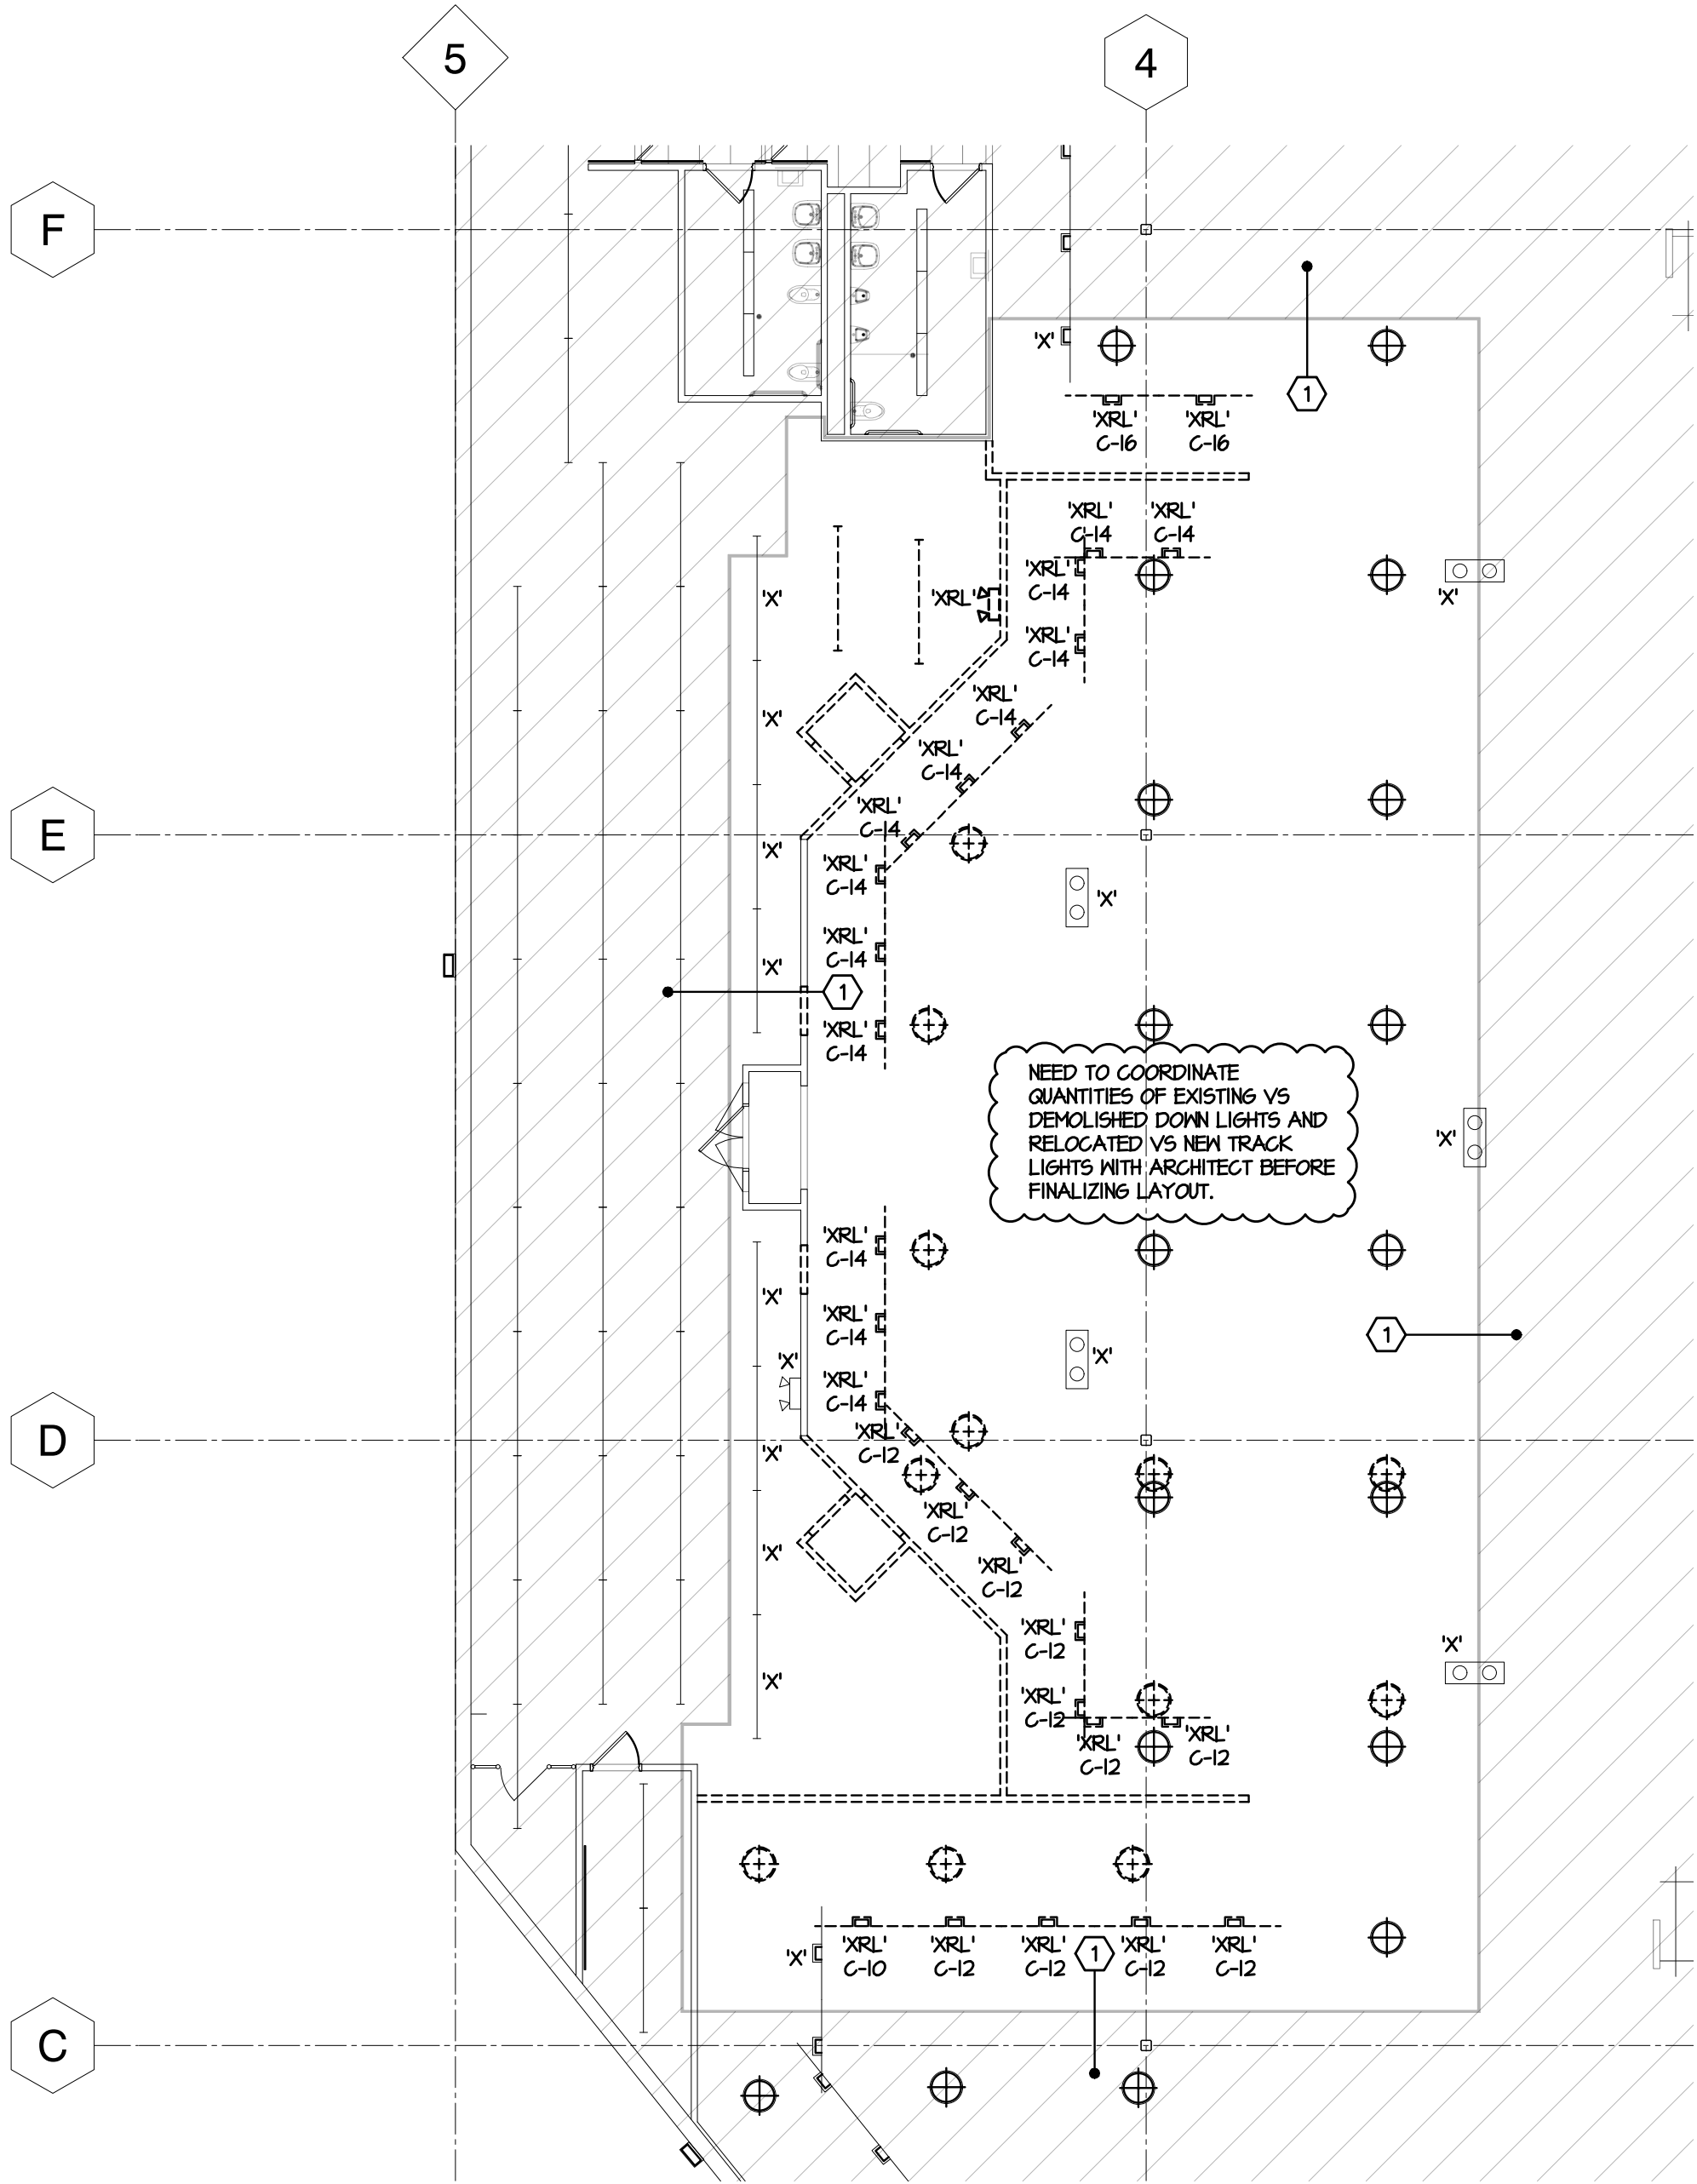
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PANEL SCHEDULES E4.0

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1 POWER, TELEPHONE, SECURITY, SPECIAL SYSTEMS, DEMOLITION FLOOR PLAN
SCALE 3/32" = 1'-0"



2 LIGHTING DEMOLITION PLAN
SCALE 3/32" = 1'-0"

SYMBOL LIST	
	HIGHBAY LIGHTING FIXTURE
	HIGHBAY NIGHTLIGHT FIXTURE
	TRACK HEAD LIGHT AND TRACK FIXTURE
	STRIP LIGHTING FIXTURE
	STRIP LIGHTING FIXTURE WITH EMERGENCY BATTERY DRIVER
	PENDANT MOUNTED EMERGENCY LIGHTING FIXTURE
	WALL MOUNTED EMERGENCY LIGHTING FIXTURE
	EXIT LIGHT FIXTURE
	EXIT LIGHT FIXTURE, WALL MOUNTED
	DATA CABLE LOCATION
	TEMPERATURE SENSOR
	CARBON DIOXIDE SENSOR
	COMBINED TEMPERATURE / RELATIVE HUMIDITY / CARBON DIOXIDE SENSOR
	ACCESS POINT IN CEILING
	FIRE ALARM WALL MOUNTED VISUAL ONLY DEVICE
	FIRE ALARM WALL MOUNTED AUDIO/VISUAL DEVICE
	FIRE ALARM CEILING OR PENDANT MOUNTED AUDIO/VISUAL DEVICE

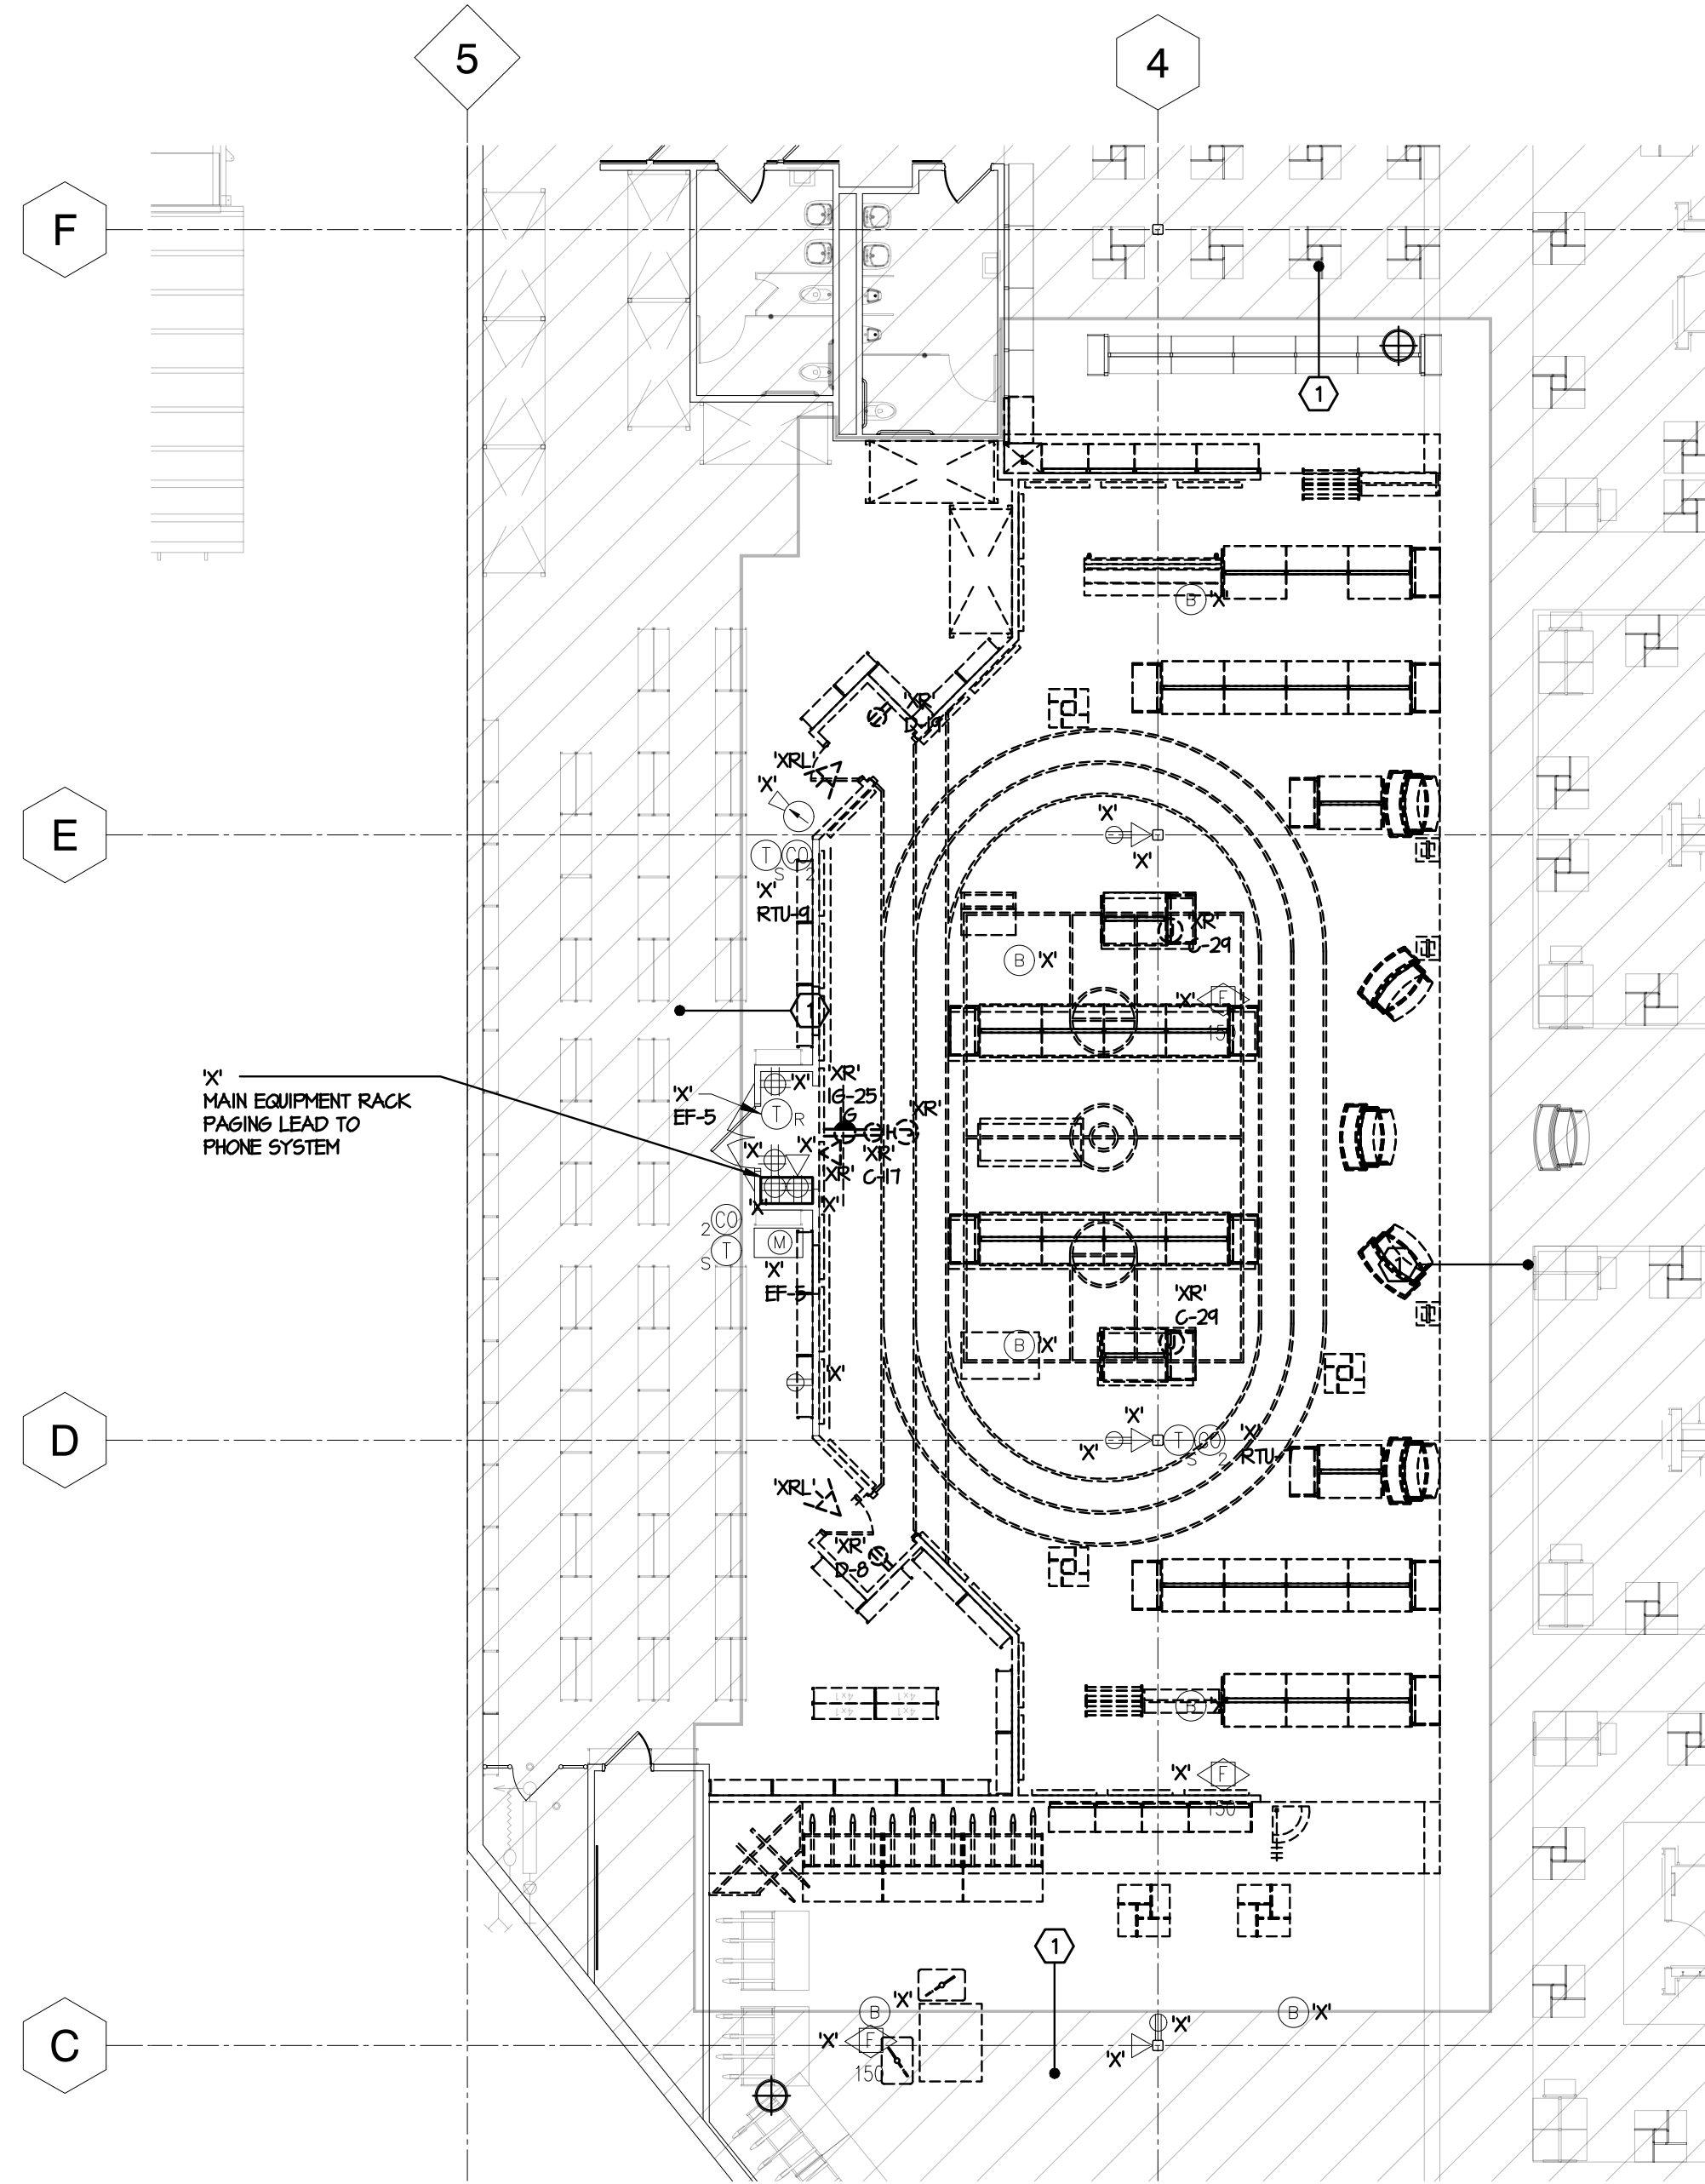BA LEGEND	
SYMB	DESCRIPTION
	DOOR CONTACT
	CURTAIN MOTION
	MOTION DETECTOR - 360 DEG CEILING MOUNTED
	CEILING INFRARED SENSOR

CCTV LEGEND	
SYMB	DESCRIPTION
	FIXED CAMERA
	CAMERA - PENDANT MOUNTED
	PUBLIC VIEW MONITOR
	DEAD DROP

SPEAKER LEGEND	
I	SPEAKER # IN ZONE
F	ZONE (A THROUGH G)
	SPEAKER MOUNTED TO BOTTOM OF JOIST
	VOLUME CONTROL SPEAKER, CEILING MOUNT
	HORN SPEAKER
	VOLUME CONTROL SWITCH

- GENERAL DEMOLITION NOTES:**
- THIS CONTRACTOR SHALL PERFORM ALL DEMOLITION OF EXISTING ELECTRICAL SYSTEMS AS INDICATED ON ELECTRICAL AND ARCHITECTURAL PLANS OR NECESSARY FOR THE PROJECT. REMOVE FROM SITE AND PROPERLY DISPOSE OF ALL MATERIAL AND DEBRIS FROM THIS WORK.
 - DEMOLITION DRAININGS ARE GENERAL IN NATURE SHOWING THE SCOPE OF DEMOLITION WORK. CONTRACTOR SHALL VISIT THE SITE AND BECOME FAMILIAR WITH THE QUANTITY OF LIGHT FIXTURES, DEVICES, OUTLETS, CONNECTIONS, ETC. REMOVE ALL LIGHT FIXTURES, EQUIPMENT AND DEVICES AS NOTED OR NO LONGER REQUIRED FOR FINISHED CONSTRUCTION. ALL EXISTING RELATED CONDUIT, WIRE AND DEVICES IN PROJECT AREAS SHALL BE REMOVED AND DISPOSED OF. REMOVE CONDUITS BEYOND NEW SURFACES. REMOVE ALL EXISTING WIRE FROM CONDUIT BACK TO POINT OF COMMON USE OR TO PANELS. LABEL EXISTING CIRCUIT BREAKERS "SPARE" IF NOT REUSED FOR NEW WORK.
 - DISCONNECT EXISTING EQUIPMENT IN BUILDING THAT IS TO BE REMOVED UNDER OTHER SECTIONS. REMOVE DATA AND PHONE CABLES SYSTEM AS DIRECTED BY OWNER. NO CABLES SHALL BE REMOVED OR CUT WITHOUT APPROVAL FROM OWNER. ANY EXISTING CABLES TO REMAIN SHALL BE SUPPORTED FROM STRUCTURE BEFORE CEILING REMOVAL.
 - PATCH ALL SURFACES TO MATCH SURROUNDING FOR DEVICES TO BE REMOVED FROM EXISTING WALLS TO BE MAINTAINED. EXISTING ROUGH-IN BOXES IN WALL TO REMAIN MAY BE REUSED IF CODE COMPLYING AND APPROVED FOR LOCATION BY ARCHITECT.
 - THE OWNER RESERVES THE RIGHT OF SALVAGE FOR ALL EXISTING ELECTRICAL EQUIPMENT PRIOR TO DEMOLITION. THE CONTRACTOR SHALL REVEAL ALL MATERIALS AND DELIVER TO THE OWNER THOSE REQUIRED IN THEIR EXISTING CONDITION. ALL OTHER MATERIAL SHALL BE REMOVED BY THIS CONTRACTOR.
 - ALL CIRCUITS WHICH ARE REQUIRED TO REMAIN ACTIVE SHALL BE MAINTAINED OR REWORKED AS REQUIRED. ANY EXISTING CIRCUITS OR CABLES SYSTEMS SERVING AREAS NOT AFFECTED BY DEMOLITION SHALL BE MAINTAINED. ALL CIRCUITS SHALL BE VERIFIED WITH EXISTING DRAWINGS AND ACTUAL FIELD CONDITIONS PRIOR TO BEGINNING DEMOLITION.
 - CONTRACTOR MAY OPTION TO REUSE WIRING WHEN FEASIBLE WHERE EQUIPMENT IS BEING REMOVED AND REPLACED IN THE SAME LOCATION. E.G. SHALL REFERENCE NEW WORK DRAWINGS TO SEE IF CIRCUITS ARE REUSED. IF WIRING IS IN ACCEPTABLE CONDITION IT MAY BE USED TO REFEED NEW OR RELOCATED EQUIPMENT.
 - STORE TO REMAIN OPEN DURING DEMOLITION AND CONSTRUCTION. E.G. / E.G. TO GO OVER CONSTRUCTION PHASING SCHEDULE WITH DSG CONSTRUCTION MANAGER.
 - CONTRACTOR TO MAINTAIN ALL LOW VOLTAGE SYSTEM DEVICES THAT ARE NOT AFFECTED BY REMODEL. VERIFY QUANTITY AND LOCATION OF DEVICES IN THE FIELD. REFER TO NEW WORK PLANS FOR ADDITIONAL INFORMATION.

- DEMOLITION SYMBOLS:**
- 'X' = INDICATES EXISTING DEVICE TO REMAIN.
 - 'XR' = INDICATES EXISTING DEVICE TO BE REMOVED, INCLUDING ALL CONDUIT AND WIRING BACK TO PANEL OR POINT OF COMMON USAGE.
 - 'XRL' = INDICATES EXISTING DEVICE TO BE REMOVED AND RELOCATED. EXTEND EXISTING WIRING AND REWIRE WITH LIKE KIND OR AS SHOWN ON DRAWING. CORRESPONDS WITH 'XRL'.
 - 'XRL' = INDICATES NEW LOCATION OF RELOCATED EQUIPMENT. CORRESPONDS WITH 'XRL'.
 - 'XRLN' = INDICATES EXISTING DEVICE TO BE REMOVED. REWORK AS SHOWN OR REPLACE EXISTING DEVICE WITH NEW AND REWIREAS INDICATED.
 - 'XR'D' = INDICATES EXISTING DEVICE TO BE DISCONNECTED AND ALL CONDUIT AND WIRING TO BE REMOVED.
 - CTX = INDICATES CONNECT TO EXISTING CIRCUITS.

- CODED NOTES:**
- ALL EXISTING ELECTRICAL POWER, LIGHTING, LOW VOLTAGE, SOUND, AND FIRE PROTECTION IN HATCHED AREA IS EXISTING TO REMAIN 'X'. MAINTAIN ALL EXISTING CONTROLS AND RELATED WIRING BACK TO PANELS OR POINT OF COMMON USAGE.
 - EXISTING FLOOR OUTLET TO BE DISCONNECTED AND CIRCUIT CAPPED AND LABELED SPARE WITH DETAILS ON LOCATION.
 - E.G. TO REMOVE ALL CONDUIT, WIRE, AND CONTROLS FOR EXHAUST FAN COMPLETELY 'XR'. REFER TO DEMOLITION NOTES FOR ADDITIONAL DETAILS. SEAL ALL CONDUIT PENETRATIONS WITH WEATHER TIGHT MATERIAL.

FOR ALL LIGHTING CIRCUITS THROUGHOUT THE SALES AREA, THE E.G. CAN OPTION TO REUSE, WHEREVER POSSIBLE, ANY EXISTING CONDUIT THAT IS IN CODE COMPLIANT CONDITION. ALL WIRING IS TO BE NEW FOR LIGHTING CIRCUITS. RECONNECT TO EXISTING CONTROLS AND ANY LIGHTING / EMERGENCY LIGHTING / EXIT SIGNS NOT SPECIFICALLY ADDRESSED SHALL BE RE-CIRCUITED TO NEARBY CIRCUITS PER THE CIRCUITING DESIGN SCHEME SHOWN. SUBMIT RFI WITH FIXTURE LOCATIONS TO ENGINEER OF RECORD IF CLARIFICATION IS NEEDED FOR ITEMS NOT ADDRESSED ON THIS DRAWING.

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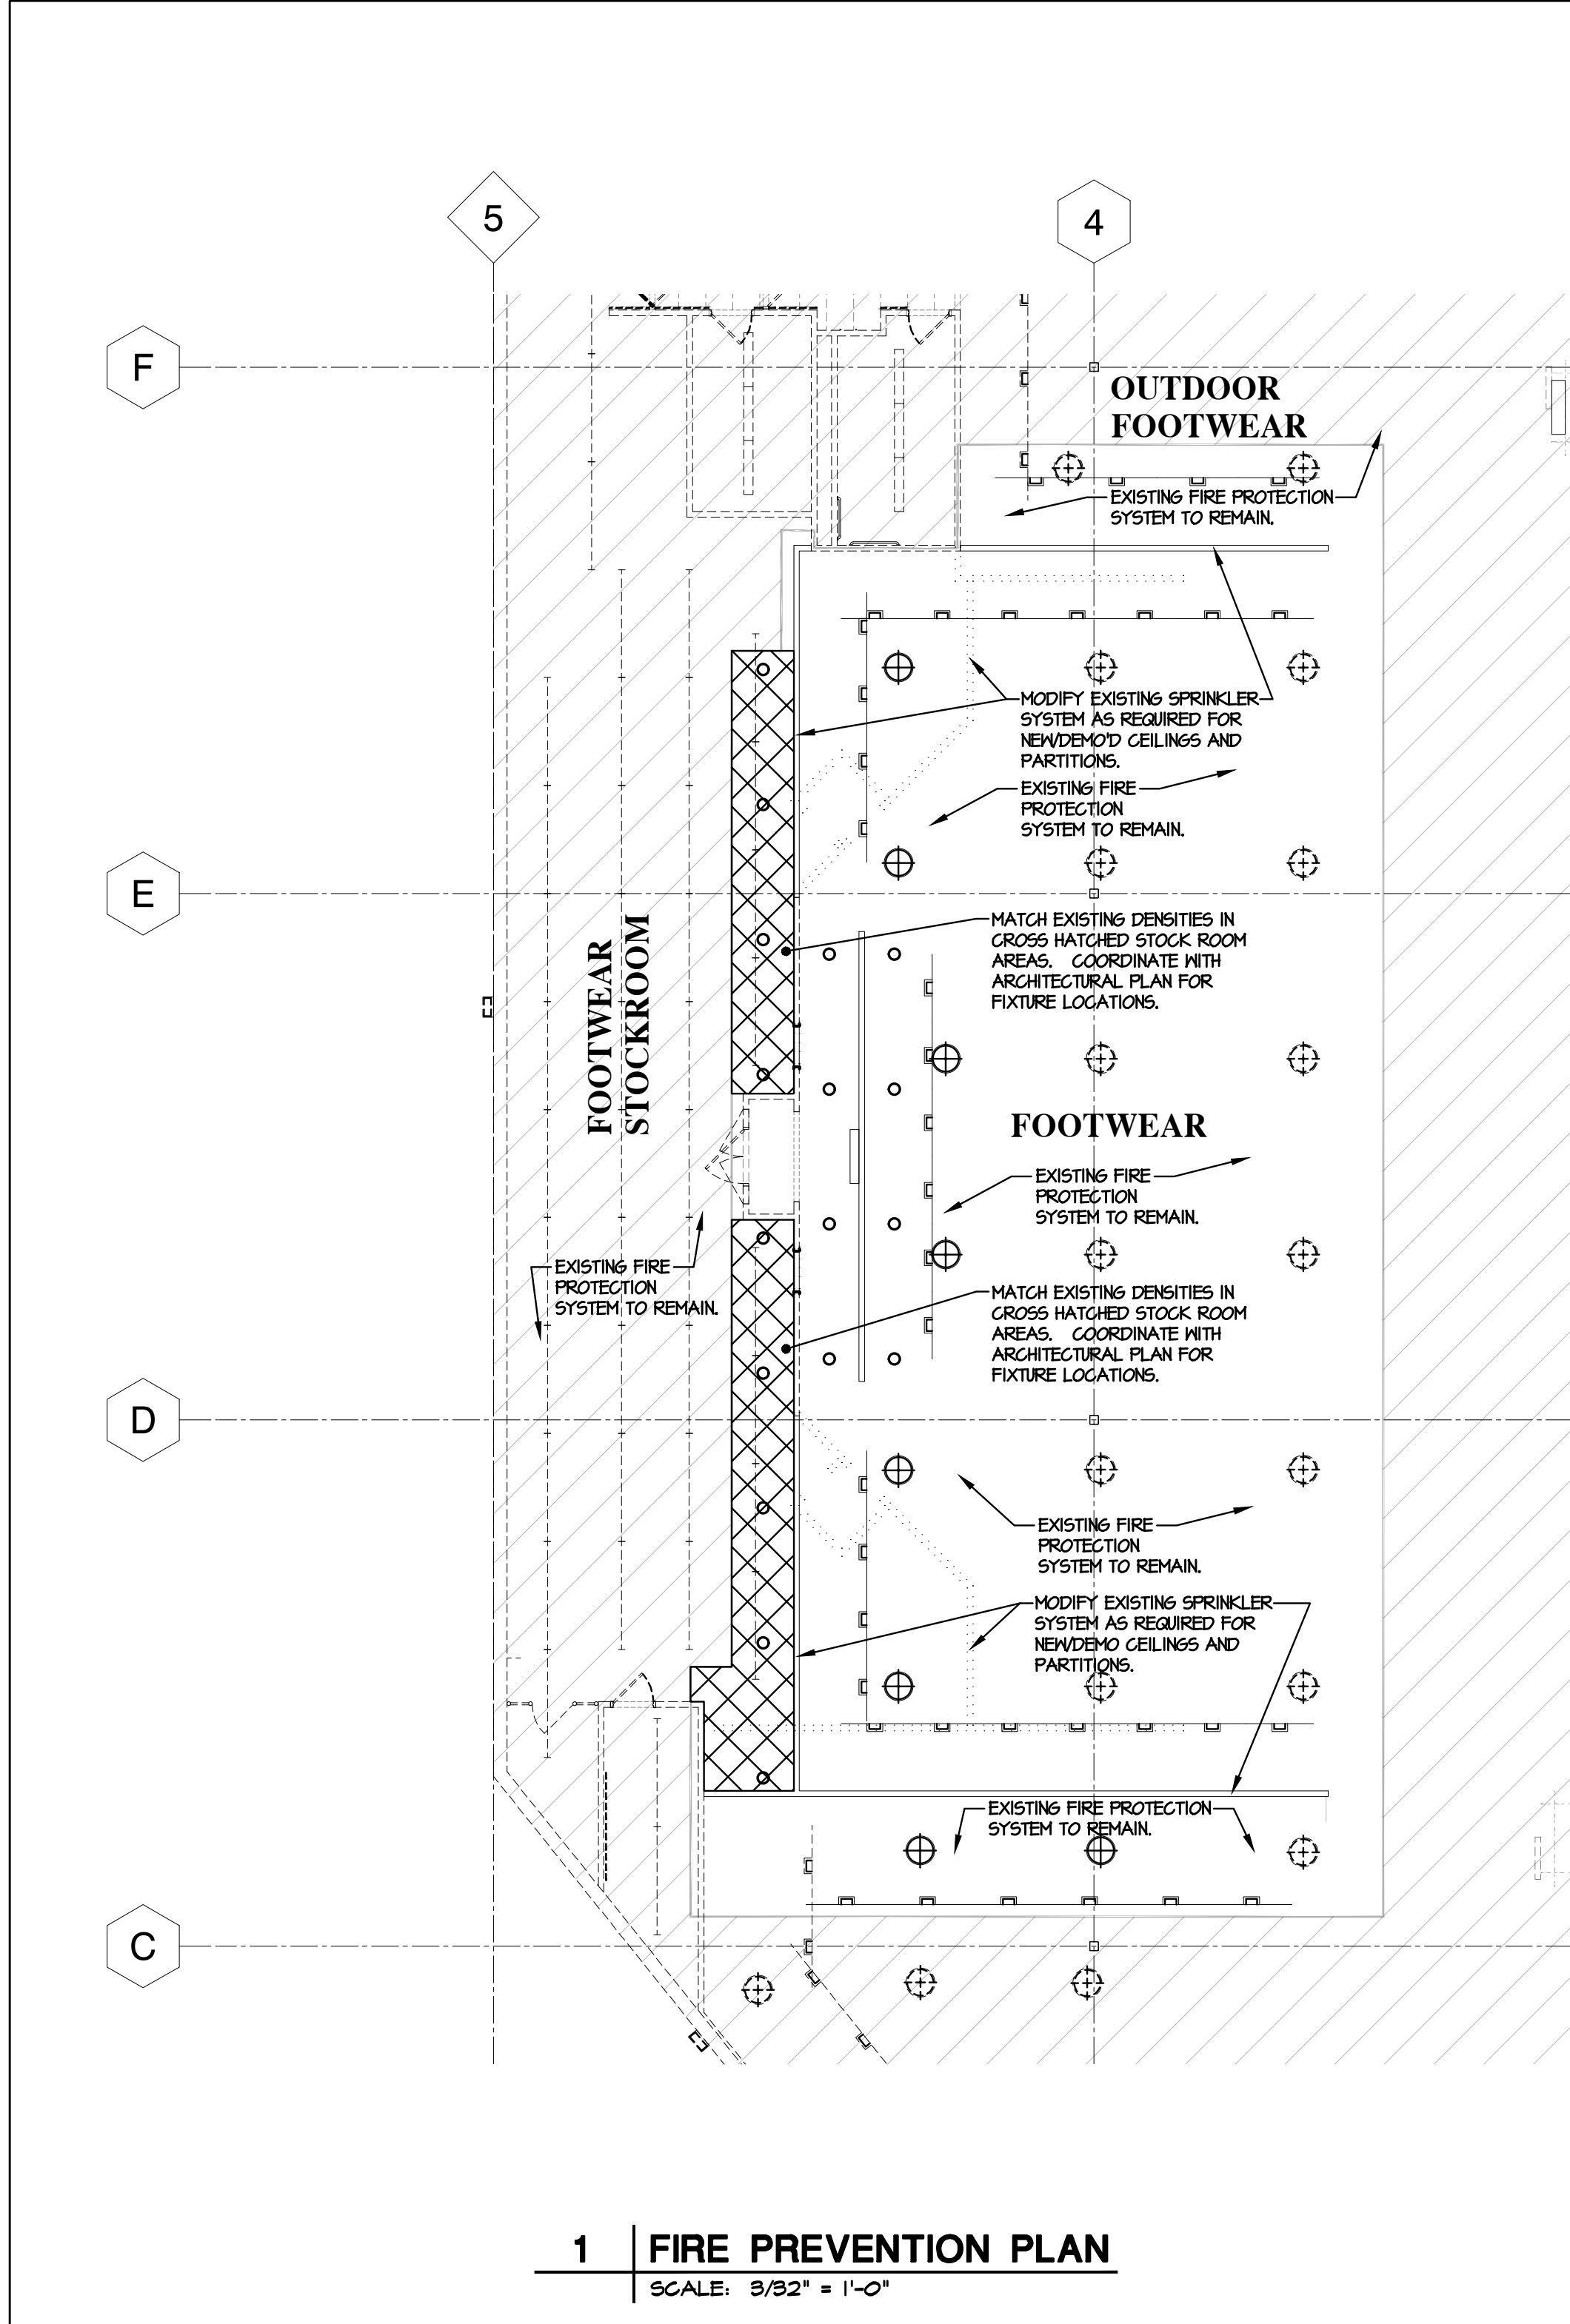
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ELECTRICAL
DEMOLITION PLANS
ED1.0



FIRE PROTECTION LEGEND

F	-FIRE PROTECTION PIPING
●	-RECESSED PENDANT SPRINKLER HEAD FOR AREAS WITH FINISHED TILED CEILINGS
◀	-DRY SIDE WALL HIGH TEMPERATURE SPRINKLER HEAD, DISPLAY ROOMS
○	-UPRIGHT SPRINKLER HEAD
●	-CONCEALED PLATE SPRINKLER HEAD (IN AREAS WITH GYPSOBOARD CEILINGS)
⊙	-UPRIGHT SPRINKLER HEAD WITH PROTECTIVE CAGE (IN GOLF FITTING CENTER)
⊠	-DRY/ANTH-FREEZE CONCEALED PLATE SPRINKLER HEAD
X	-EXISTING TO REMAIN

HEAD TYPE	AREA
RECESSED PENDANT	AREAS WITH FINISHED TILED CEILINGS
UPRIGHT	EXPOSED AREAS
CONCEALED	SHEETROCK AND COFFERED VAULTED CEILINGS

FIRE PROTECTION NOTES:

A. MODIFY EXISTING FIRE PROTECTION SYSTEM AS REQUIRED FOR NEW CEILINGS AND PARTITIONS. FIRE PROTECTION CONTRACTOR SHALL PROVIDE NEW HEADS, PIPING, ETC., AS REQUIRED TO PROVIDE A CODE COMPLIANT SPRINKLER SYSTEM. CONTRACTOR SHALL VISIT SITE AND FIELD VERIFY EXISTING CONDITIONS PRIOR TO START OF ANY WORK.

B. FIRE PROTECTION SYSTEM SHALL BE AN EXISTING WET SPRINKLER SYSTEM AND SHALL BE DESIGNED PER THE LATEST EDITION OF NFPA 13, FM AND ALL LOCAL AND STATE FIRE CODES.

C. REFER TO SPECIFICATIONS FOR HAZARD CLASSIFICATION AND ALL DESIGN DENSITIES.

D. REFER TO SPECIFICATIONS FOR ADDITIONAL INFORMATION ON SPRINKLER HEADS.

E. A MINIMUM 8" CLEARANCE SHALL BE PROVIDED FROM THE BOTTOM OF THE SPRINKLER PIPING TO THE SUSPENDED CEILING.

F. PROVIDE AN INSPECTOR'S TEST CONNECTION WITH DRAINS LOCATED TO THE EXTERIOR OF THE BUILDING OR INTO SANITARY DRAINS OF ADEQUATE SIZE TO PERMIT FULL FLOW DRAIN TESTS.

G. NEW SPRINKLER PIPING TO BE INSTALLED WITHIN BAR JOISTS WITH MAINS INSTALLED TIGHT TO BOTTOM OF JOISTS. PITCH ALL PIPING FOR PROPER DRAINAGE.

H. FIRE EXTINGUISHERS SHALL BE AS SPECIFIED AND TO BE SET WITH WALL BRACKET. NUMBER AND LOCATIONS OF EXTINGUISHERS TO BE AS DIRECTED BY LOCAL FIRE MARSHAL. REFER TO ARCHITECTURAL PLANS FOR ADDITIONAL INFORMATION.

I. ALL SPRINKLER PIPING AND HEADS SHALL BE INSTALLED TO PERMIT THE INSTALLATION OF ALL MECHANICAL AND ELECTRICAL SYSTEMS. SPRINKLER CONTRACTOR SHALL RELOCATE PIPING AND HEADS IF REQUIRED TO ACCOMMODATE MECHANICAL AND ELECTRICAL SYSTEMS.

J. NO WET SPRINKLER PIPING SHALL BE INSTALLED AT LOCATIONS SUBJECT TO FREEZING. PROVIDE ANTI-FREEZE SYSTEM DRY PIPE SYSTEM FOR AREAS NOTED, VESTIBULES, DISPLAY ROOMS OR ANY SPACE EXTERIOR OR NOT CLIMATE CONTROLLED.

K. THIS DRAWING IS INTENDED TO PROVIDE GENERAL LOCATIONS AND TYPES OF SPRINKLER HEADS, NOT ALL SPRINKLER HEADS ARE INDICATED ON THE DRAWING. SPRINKLER CONTRACTOR SHALL PROVIDE ADDITIONAL SPRINKLER HEADS AS REQUIRED BY NFPA 13 AND LOCAL JURISDICTIONAL REQUIREMENTS.

L. SPRINKLER HEADS SHALL BE INSTALLED ABOVE AND BELOW ALL DUCTWORK GREATER THAN 48" WIDE.

M. ALL PIPE PENETRATIONS OF FIRE RATED WALLS SHALL BE FIRE STOPPED TO MAINTAIN FIRE RATING OF WALL.

N. ALL FIRE PROTECTION DRAWINGS HYDRAULIC CALCULATIONS AND SUPPORTING DOCUMENTATION SHALL BE COMPLETED BY THE FIRE PROTECTION CONTRACTOR AND SUBMITTED TO LOCAL AUTHORITIES HAVING JURISDICTION AND TO DICK'S INSURANCE UNDERWRITER FOR REVIEW AND APPROVAL PRIOR TO FABRICATION OF ANY PIPING OR SYSTEM COMPONENTS. REFER TO SPECIFICATIONS FOR DICK'S INSURANCE UNDERWRITER INFORMATION.

O. COORDINATE INSTALLATION OF SPRINKLER PIPING WITH DUCTWORK, LIGHTS, AND PARTITION LAYOUT. LIGHTS ARE NOT TO BE MOVED, SPRINKLER PIPING SHALL BE ROUTED AROUND LIGHTS AS REQUIRED.

P. HANGER NOTES:

1. PIPES LARGER THAN 4 IN. RUNNING PARALLEL TO BAR JOIST SHALL BE HUNG FROM TRAPEZE HANGERS SUPPORTED NEARLY EQUALLY BY TWO JOISTS.
2. ONLY ONE PIPE SHALL BE SUPPORTED FROM A SINGLE TRAPEZE HANGER UNLESS OTHERWISE APPROVED IN WRITING BY THE STRUCTURAL ENGINEER OF RECORD.
3. HANGERS WITH MORE THAN 150 POUNDS OF LOAD SHOULD BE ATTACHED TO THE JOIST AT A PANEL POINT.
4. COORDINATE ALL HANGER TYPES AND LOCATIONS WITH THE STRUCTURAL ENGINEER OF RECORD.

THIS DRAWING IS FOR REFERENCE ONLY. FIRE PROTECTION CONTRACTOR FOR THIS PROJECT SHALL PROVIDE FULLY DETAILED SPRINKLER PLANS AND CALCULATIONS.

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42 ASH BROOK ROAD
KEENE, NH 03431

*With exception of the National Account Vendor that DSG is purchasing directly from as noted on this vendor list, all other vendors are to be purchased through the General Contractor to purchase and install complete as shown and referenced. The General Contractor is required to coordinate and supervise all work and ensure all work is done in accordance with the specifications and drawings. (Dick's Sporting Goods) has the right to review and/or reject any work that does not meet the specifications.

DICK'S
MONADNOCK MARKETPLACE
42 ASH BROOK ROAD
KEENE, NH 03431

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FIRE PREVENTION
PLAN
FP1.0

CONTRACTOR MUST VERIFY ALL CLEARANCES AND DIMENSIONS IN FIELD

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